GENERAL NOTES:

1. ALL DIMENSIONS SHOWN ON DRAWINGS ARE STRUCTURAL MEASUREMENT IN MILLIMETRES AND ALL LEVELS SHOWN IN METERS ABOVE PRINCIPAL DATUM UNLESS OTHERWISE STATED.

2. EVERY REQUIRED STAIRCASE SHALL:

(a) HAVE A CLEAR HEIGHT OF NOT LESS THAN 2000mm,

(b) BE CONSTRUCTED WITH TREADS NOT LESS THAN 280mm IN WIDTH AND RISERS NOT EXCEEDING 150mm IN HEIGHT FOR THE RESTAURANT

(c) BE PROVIDED WITH HANDRAILS ON BOTH SIDES AT A HEIGHT NOT LESS THAN 850mm NOR MORE THAN 950mm AND EXTENDED 300mm TO LANDING IN ACCORDANCE WITH CODE OF PRACTICE FOR FIRE SAFETY IN BUILDINGS 2011 (FSB 2011) CLAUSE B14.6 & (BFA 2008) CLAUSE 28-30.

3. ALL DOORS REQUIRED TO HAVE AN FRR SHALL COMPLY WITH B(C)R 90 & (FSB 2011) CLAUSE C16.

4. THE LOCKING DEVICE PROVIDED FOR EXIT DOORS, IF NECESSARY, SHALL BE OF THE TYPE, WHICH IS CAPABLE OF BEING OPENED FROM THE INSIDE WITHOUT USING A KEY.

5. PROTECTIVE BARRIERS (SUCH AS PARAPET WALL AND RAILING) SHOULD BE PROVIDED IN ACCORDANCE WITH B(P)R 3A & B(C)R 8.

6. A VERTICAL BARRIER PROVIDED TO SURROUND THE INTERNAL UNPROTECTED OPENING IN FLOORS WITHIN A COMPARTMENT FOR AGAINST SPREAD OF FIRE, SUCH AS THOSE FOR ESCALATORS, CIRCULATION STAIRCASES OR WALKWAYS IN AN ATRIUM, SHALL HAVE AN FRR OF NOT LESS THAN 60 MIN. AND EXTEND NOT LESS THAN 450mm FROM THE UNDERSIDE OF THE FLOOR OR BELOW THE FALSE CEILING IF THE FALSE CEILINGS ARE HUNG IN THE VICINITY OF THE OPENING (FSB 2011) CLAUSE C10.1

7. THE GLAZING MATERIALS IN SKYLIGHT SHALL MEET THE FOLLOWING CRITERIA:

(a) IT SHOULD NOT BE OF THE TYPE WHICH WILL MELT AND FORM BURNING DROPLETS UNDER FIRE SITUATIONS; AND

(b) WHEN IT IS SHATTERED, IT DOES NOT FORM SHARPENING AND HARMFUL PIECES.

8. EVERY PART OF AN EXIT ROUTE SHOULD BE PROVIDED WITH ARTIFICIAL LIGHTING PROVIDING A HORIZONTAL ILLUMINANCE AT FLOOR LEVEL OF NOT LESS THAN 30 LUX (AND COMPLY WITH CoP FOR MIN. F.S. INSTALLATION AND EQUIPMENT.)

9. EVERY OPENING FORMED FOR DUCTS OR PIPES PASSING THROUGH FIRE BARRIERS WOULD COMPLY WITH (FSB 2011) CLAUSE C8.

10. ELEMENTS OF CONSTRUCTION OTHER THAN REINFORCED CONCRETE FOR SEPARATING COMPARTMENTS TO BE PROVIDED WITH STABILITY, INTEGRITY AND INSULATION AS STATED IN (FSB 2011) TABLE C2.

11. ONE LEAF OF A PAIR OF DOUBLE DOORS SHALL HAVE A CLEAR WIDTH OF NOT LESS THAN 800mm BETWEEN THE OPEN DOOR AND THE OTHER LEAF.

12. CAT LADDER AT PUBLIC ACCESSIBLE AREA WOULD BE PROVIDED WITH LOCKABLE PLATE.

13. DOORS OF ALL PROTECTED LOBBY SHOULD BE PROVIDED WITH SMOKE SEALS (FSB 2011) CLAUSE C16.5.

14. ALL LIFT WELLS & DUMB WAITER SHAFT SHOULD BE SEPARATED FROM THE REST OF THE BUILDING BY FIRE BARRIERS HAVING AN FRR OF NOT LESS THAN 120/120/120, AND ALL DOORS PROVIDED AT A LIFT LANDING SHOULD HAVE AN FRR OF NOT LESS THAN -/120/- IN ACCORDANCE WITH (FSB 2011) CLAUSE C9.1.

15. WHERE THE HEADROOM IS 2000mm OR LESS FROM THE FINISHED FLOOR LEVEL, A WARNING GUARDRAIL OR OTHER BARRIER SHALL BE PROVIDED FOR DETECTION. HAVING ITS LEADING EDGE AT OR BELOW 680mm ABOVE THE FINISHED FLOOR LEVEL (BFA 2008 CLAUSE 36).

16. ALL EXISTING DISABLED RAMP SHOULD COMPLY WITH BFA 2008.

FIRE SERVICES NOTES

THE FIRE SERVICE INSTALLATIONS ARE PROVIDED IN ACCORDANCE WITH THE REQUIREMENTS AND SPECIFICATIONS OF THE CURRENT EDITION OF THE CODES OF PRACTICE FOR MINIMUM FIRE SERVICE INSTALLATIONS AND EQUIPMENT AND INSPECTION, TESTING AND MAINTENANCE OF INSTALLATIONS AND EQUIPMENT AND THE CURRENT ISSUE OF THE FSD CIRCULAR LETTERS. THE PARTICULARS OF THE FIRE SERVICE INSTALLATIONS TO BE PROVIDED FOR THE BUILDING ARE AS FOLLOWS:-

1) AUTOMATIC FIXED INSTALLATIONS USING WATER

AUTOMATIC SPRINKLER SYSTEM DESIGNED TO OH(I) IN ACCORDANCE WITH "LPC RULES INCORPORATING BS EN 12845:2003 FOR AUTOMATIC SPRINKLER INSTALLATIONS" TO BE PROVIDED FOR ALL AREAS INCLUDING STAIRCASES, SEATING AREA, KITCHEN, PANTRY AND UNISEX TOILETS BUT EXCLUDE CONSUMER ELECTRICAL EQUIPMENT /MECHANICAL PLANT ROOM AS INDICATED ON THE DRAWINGS. SPRINKLER ANNUNCIATION PANEL TO BE PROVIDED AT G/F FIRE CONTROL CENTRE AS INDICATED ON THE DRAWINGS. ALARM SIGNAL TO BE TRANSMITTED TO F.S. COMMUNICATION CENTRE VIA DIRECT TELEPHONE LINK. WATER SUPPLY TO SPRINKLER TANK TO BE SINGLE END FEED. CAPACITY OF SPRINKLER TANK TO BE 37m3.

SPRINKLER SYSTEM WILL NOT BE PROVIDED FOR ALL EXTERNAL CANOPIES WHERE GOODS ARE NOT STORED OR HANDLED IN ACCORDANCE WITH FSD CIRCULAR NO.3/2006, LIST TWO ITEM 2.93.

2) EMERGENCY POWER SUPPLY

THE ELECTRICITY SUPPLIES TO ALL EMERGENCY ELECTRICAL EQUIPMENT TO BE FED FROM THE INCOMING POWER SUPPLY BY THE POWER COMPANY AT BOTH BEFORE AND AFTER THE MAIN SWITCH, AUTOMATIC CHANGE OVER DEVICE TO BE PROVIDED AND TO ENERGIZE IN CASE OF FAILURE OF THE MAIN POWER

3) EMERGENCY LIGHTING

TO BE PROVIDED THROUGHOUT THE ENTIRE BUILDING AND FOR ALL EXIT SIGNS AND BACKED UP BY SELF CONTAINED/SECONDARY BATTERY.

a. SUFFICIENT EXIT OF SELF CONTAINED BATTERY TYPE, TO BE PROVIDED AT LOCATIONS AS INDICATED ON THE DRAWINGS.

MANUALLY OPERATED FIRE ALARM SYSTEM COMPRISING MANUAL BREAK-GLASS AND ALARM BELL TO BE PROVIDED AT EACH HOSE REEL LOCATION AS

INDICATED ON THE DRAWINGS. THE SYSTEM TO BE LINKED TO THE AUTOMATIC FIRE ALARM SYSTEM AND FS COMMUNICATION CENTRE VIA DIRECT TELEPHONE VISUAL FIRE ALARM SYSTEM TO BE PROVIDED FOR THE AREA WHICH IS INTENDED TO BE ACCESSIBLE TO PUBLIC AS INDICATED ON THE DRAWINGS IN ACCORDANCE WITH FSD CIRCULAR LETTERS 2/2012 OF BS 5839-1:2002+A2:2008 AND BARRIER FREE ACCESS 2008 CODE, AND THE ALARM SIGNAL SHALL FORM

FIRE ALARM CONTROL PANEL TO BE PROVIDED AT LOCATION AS INDICATED ON THE DRAWINGS.

6) FIRE DETECTION SYSTEM

AUTOMATIC FIRE ALARM AND DETECTION SYSTEM IN ACCORDANCE WITH "RULES OF THE LOSS PREVENTION COUNCIL FOR AUTOMATIC FIRE DETECTION AND ALARM SYSTEMS FOR THE PROTECTION OF PROPERTY" (LPC RULES) AND BS 5839-1:2002+A2:2008 WITH MODIFICATIONS AS REQUIRED IN FSD CIRCULAR LETTER NO. 1/2002 & 2/2012 TO BE PROVIDED FOR AREAS NOT PROTECTED BY AUTOMATIC SPRINKLER SYSTEM. HEAT DETECTION SYSTEM TO BE PROVIDED FOR CONSUMER ELECTRICAL EQUIPMENT/MECHANICAL PLANT/TBE ROOM. AUTOMATIC FIRE ALARM PANEL TO BE PROVIDED AT G/F FIRE CONTROL CENTRE AS INDICATED ON THE DRAWINGS. ALARM SIGNAL TO BE TRANSMITTED TO F.S. COMMUNICATION CENTRE VIA DIRECT TELEPHONE LINK.

7) FIRE HYDRANT / HOSE REEL INSTALLATION

TO BE PROVIDED AT LOCATIONS AS INDICATED ON THE DRAWINGS. CAPACITY OF THE WATER TANK TO BE 27m³.

SINGLE OUTLET TYPE HYDRANTS TO BE PROVIDED. HOSE REEL TO BE PROVIDED THAT EVERY PART OF THE BUILDING CAN BE REACHED BY A LENGTH OF NOT

MORE THAN 30m HOSE REEL TUBING.

8) PORTABLE HAND OPERATED APPROVED APPLIANCES TO BE PROVIDED AT LOCATIONS AS INDICATED ON THE DRAWINGS.

9) VENTILATION/AIR-CONDITIONING CONTROL SYSTEM NOT TO BE PROVIDED FOR ALL BUILDINGS.

10) ADDITIONAL REQUIREMENTS

ALL LININGS FOR ACOUSTIC AND THERMAL INSULATION PURPOSES IN DUCTING AND CONCEALED LOCATIONS SHALL BE TESTED IN ACCORDANCE WITH CODE OF PRACTICE FOR FIRE SAFETY IN BUILDINGS 2011 (COP FOR F.S.B.) SUB SECTION E15.1.

ALL LININGS FOR ACOUSTIC, THERMAL INSULATION AND DECORATIVE PURPOSES WITHIN PROTECTED MEANS OF ESCAPE SHALL BE TESTED IN ACCORDANCE WITH CODE OF PRACTICE FOR FIRE SAFETY IN BUILDINGS 2011 (FSB 2011) SUB SECTION E13.2.

COLOUR INDICATION

CONCRETE SLAB (LIGHTER WASH) CONCRETE (PLAIN OR REINFORCED)

SOLID CONCRETE BLOCK

HOLLOW CONCRETE BLOCK

LIGHTWEIGHT PARTITION PLASTER OR CEMENT RENDERING

MOSAIC OR OTHER NON-ABSORBENT FLOOR / WALL TILES

METAL WORK OR STEEL

STONE FINISH

SANITARY FITTINGS PROVISION FOR THE DISABLED

EARTH (UNEXCAVATED) EXISTING STRUCTURE

EXISTING WOOD DECK

LEGEND AND ABBREVIATIONS:

1. GENERAL & ABBREVIATION

ABOVE FINISHED FLOOR LEVEL ABOVE STRUCTURAL FLOOR LEVEL

FINISHED FLOOR LEVEL STRUCTURAL FLOOR LEVEL

C.L. CAT LADDER METAL LOUVRE WINDOW OPENING

F.D. FLOOR DRAIN F.A.I. FRESH AIR INTAKE

P.D. PIPE DUCT MVAL MECHANICAL VENTILATION & ARTIFICIAL LIGHTING

AL ARTIFICIAL LIGHTING EΑ EXHAUST AIR

SUBMISSION BOUNDARY ____ — — SITE BOUNDARY

1500 x 1500 TEMPORARY REFUGE SPACES

1500 x1500 MANOEUVRING SPACE

800 x1500 MANOEUVRING SPACE

2. FITTINGS LEGENDS & ABBREVIATIONS

PLAN ELE.

WATER CLOSET

3. TACTILE TYPES

TACTILE WARNING STRIP

4. HANDRAIL TYPES

HL-1 40mm DIAMETER HAIRLINE S/S HANDRAILS (WALL MOUNT TYPE) WITH BARRIER FREE

REQUIREMENTS 40mm DIAMETER HAIRLINE S/S HANDRAILS (FLOOR MOUNT TYPE) WITH BARRIER FREE REQUIREMENTS

5. FIRE SERVICES

4.5kg CO₂ F.E. FIRE EXTINGUISHER F.H. FIRE HYDRANT


F.S.I. FIRE SERVICES INLET H.R. HOSE REEL EXIT SIGN EXIT

DIRECTIONAL SIGN (PROPRIETARY PRODUCT PROVIDED BY B.S.) DSR 🔂

ACCESSIBLE LIFT


DOOR WITH TRANSPARENT UPPER VIEW PANEL FRR -/60/60 SELF CLOSING DOOR

FRR -/60/60 SELF CLOSING DOOR WITH TRANSPARENT UPPER VIEW PANEL

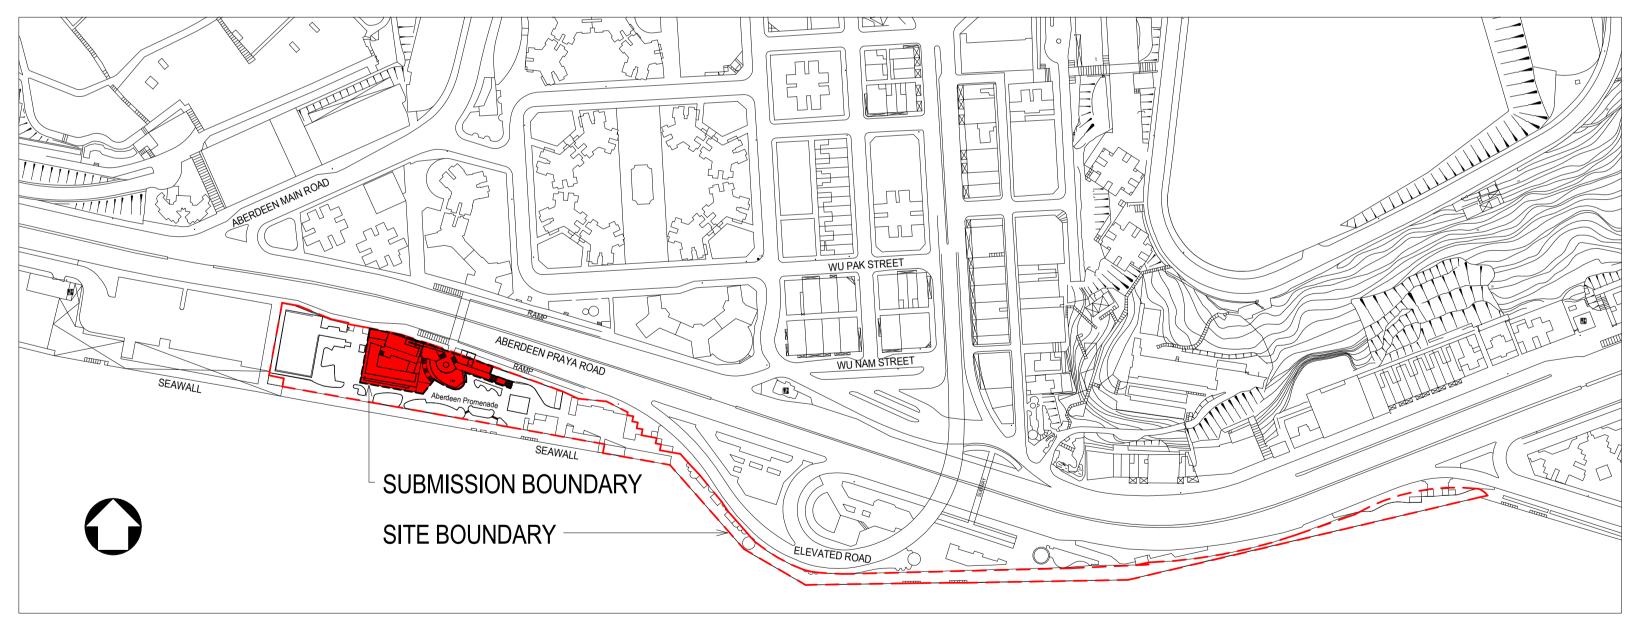



LOCATION PLAN SCALE 1:2000


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		drawn		LEGEND & LOCATION PLAN	-8282-G
		checked			nts/ADA
		approved	contract no.	scale As indicated	Occume
	no. date description initia	Chief Architect Senior Architect	file no.	drawing no.	s/Louis/l
	no. date description initial REVISION	Project Architect Signed date	project no. 263 Z	AB/8282/SC 001	C:\User

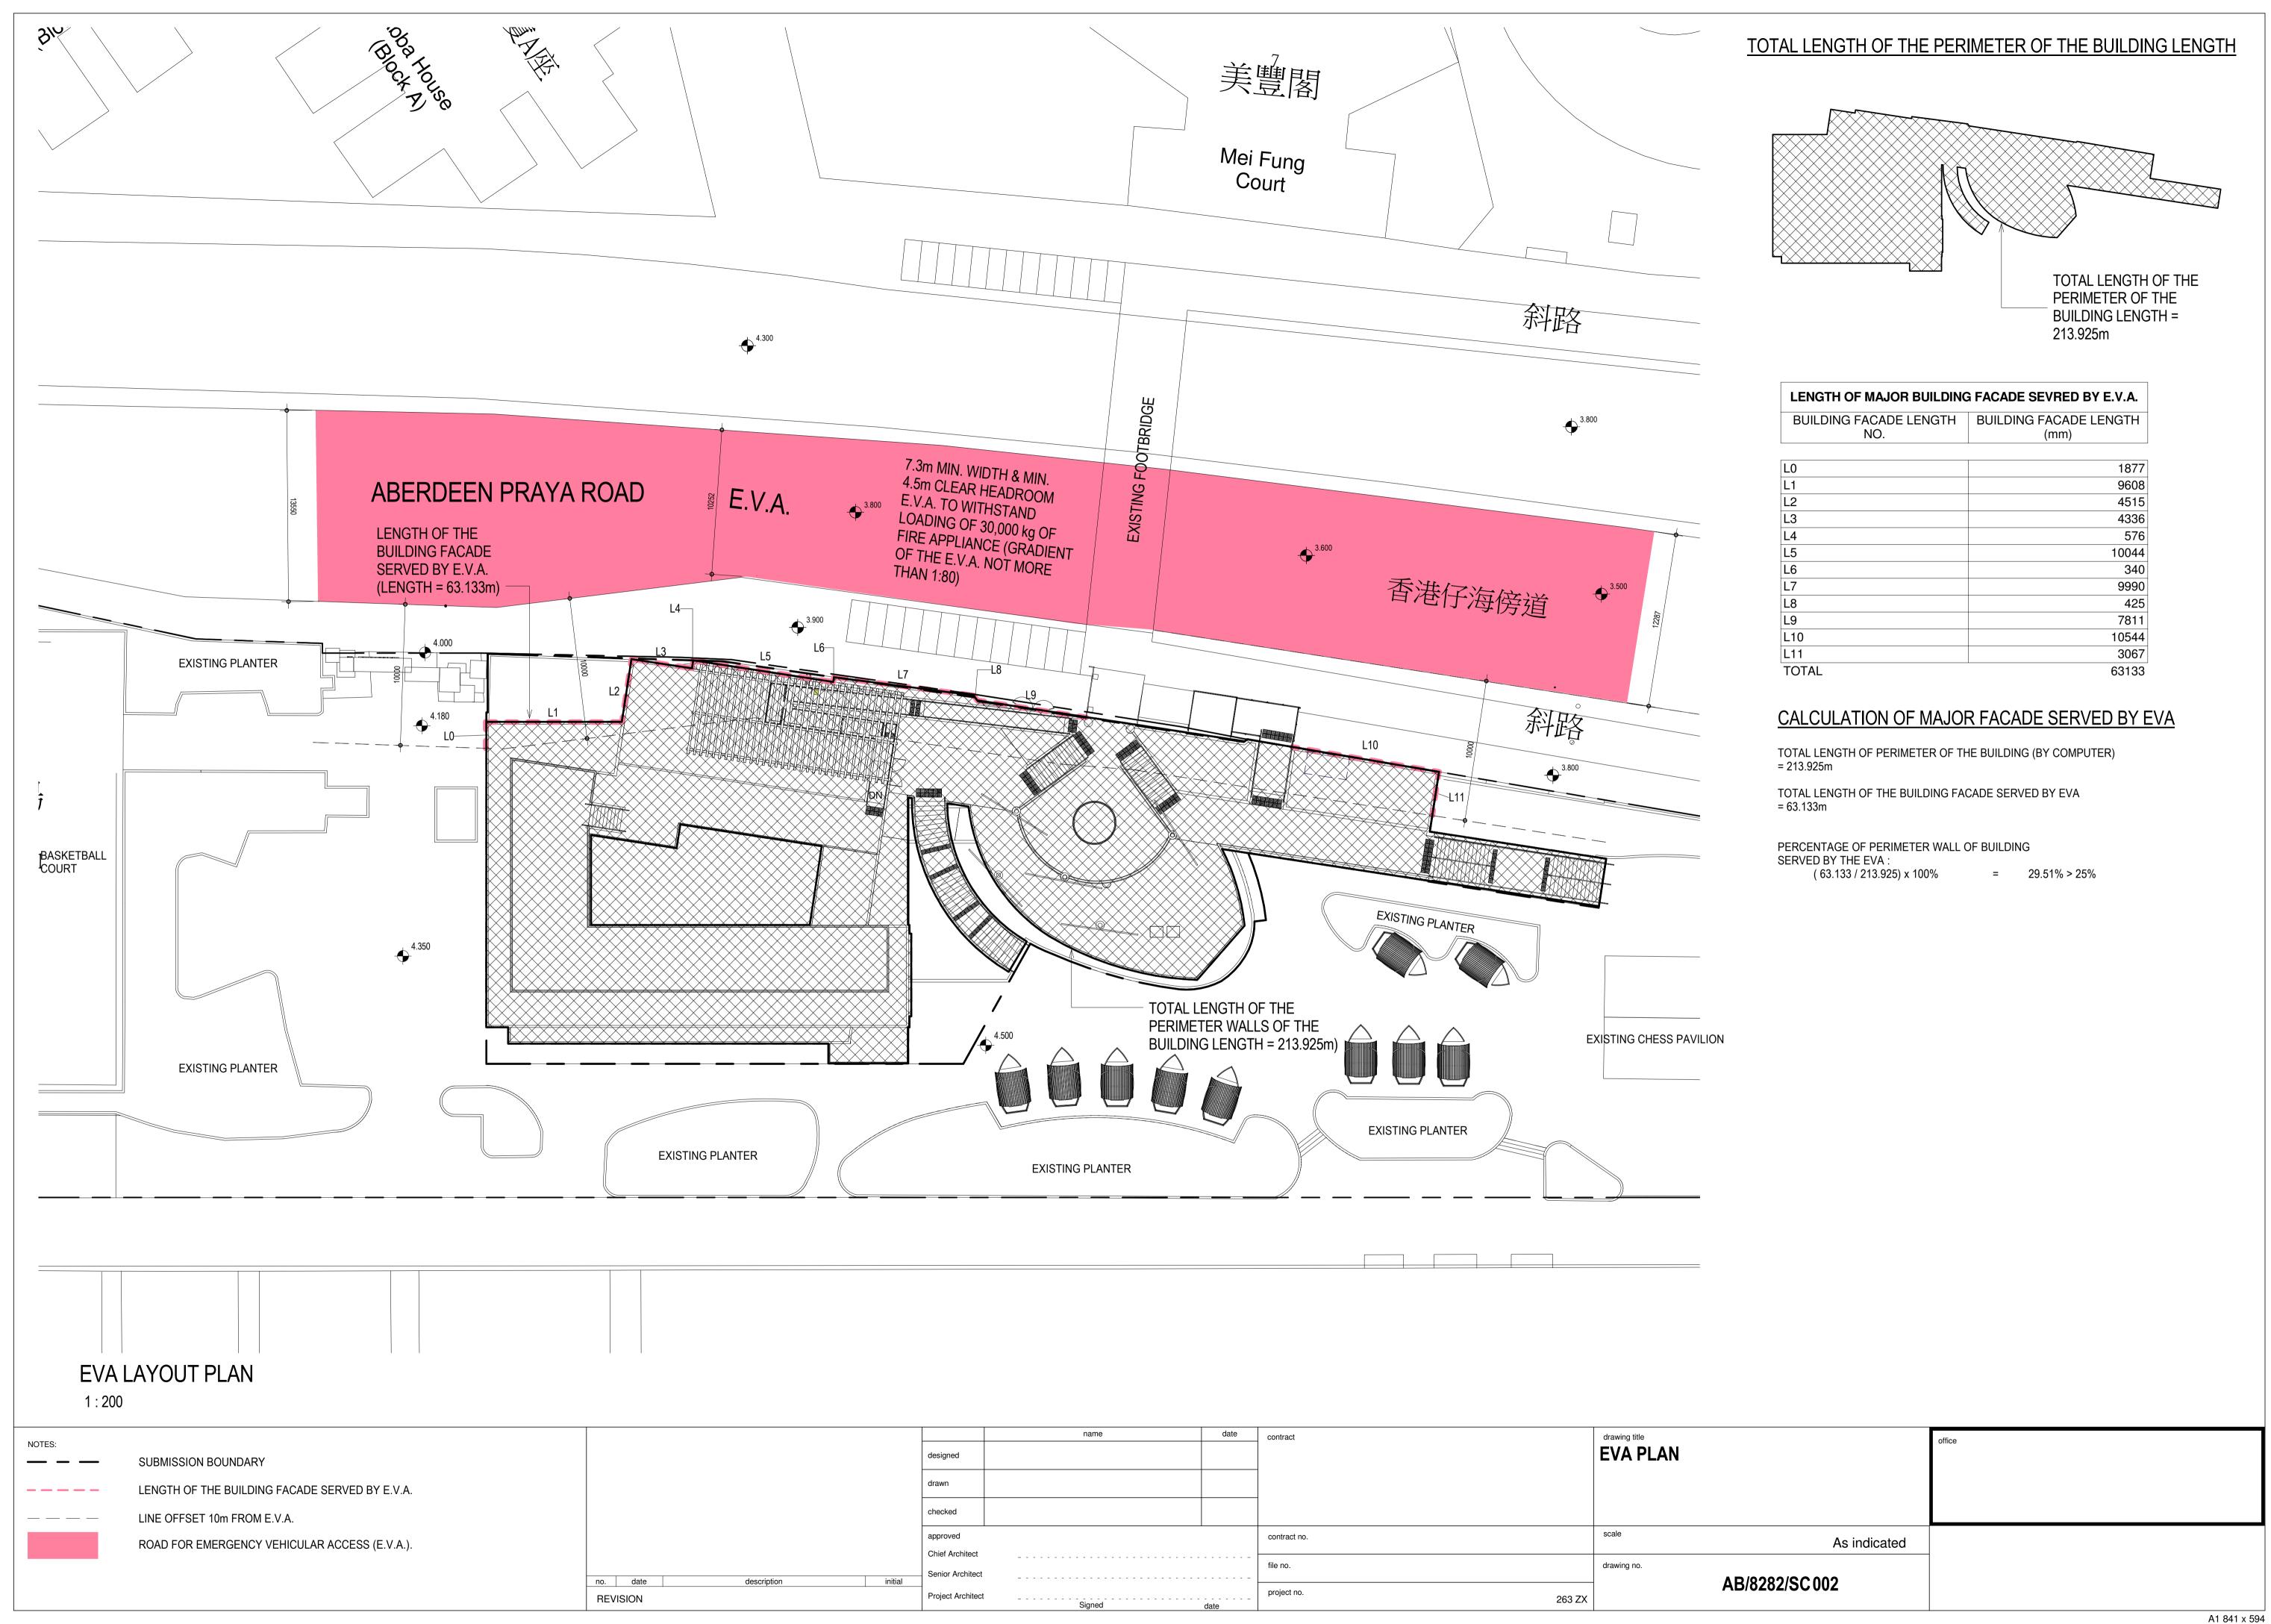





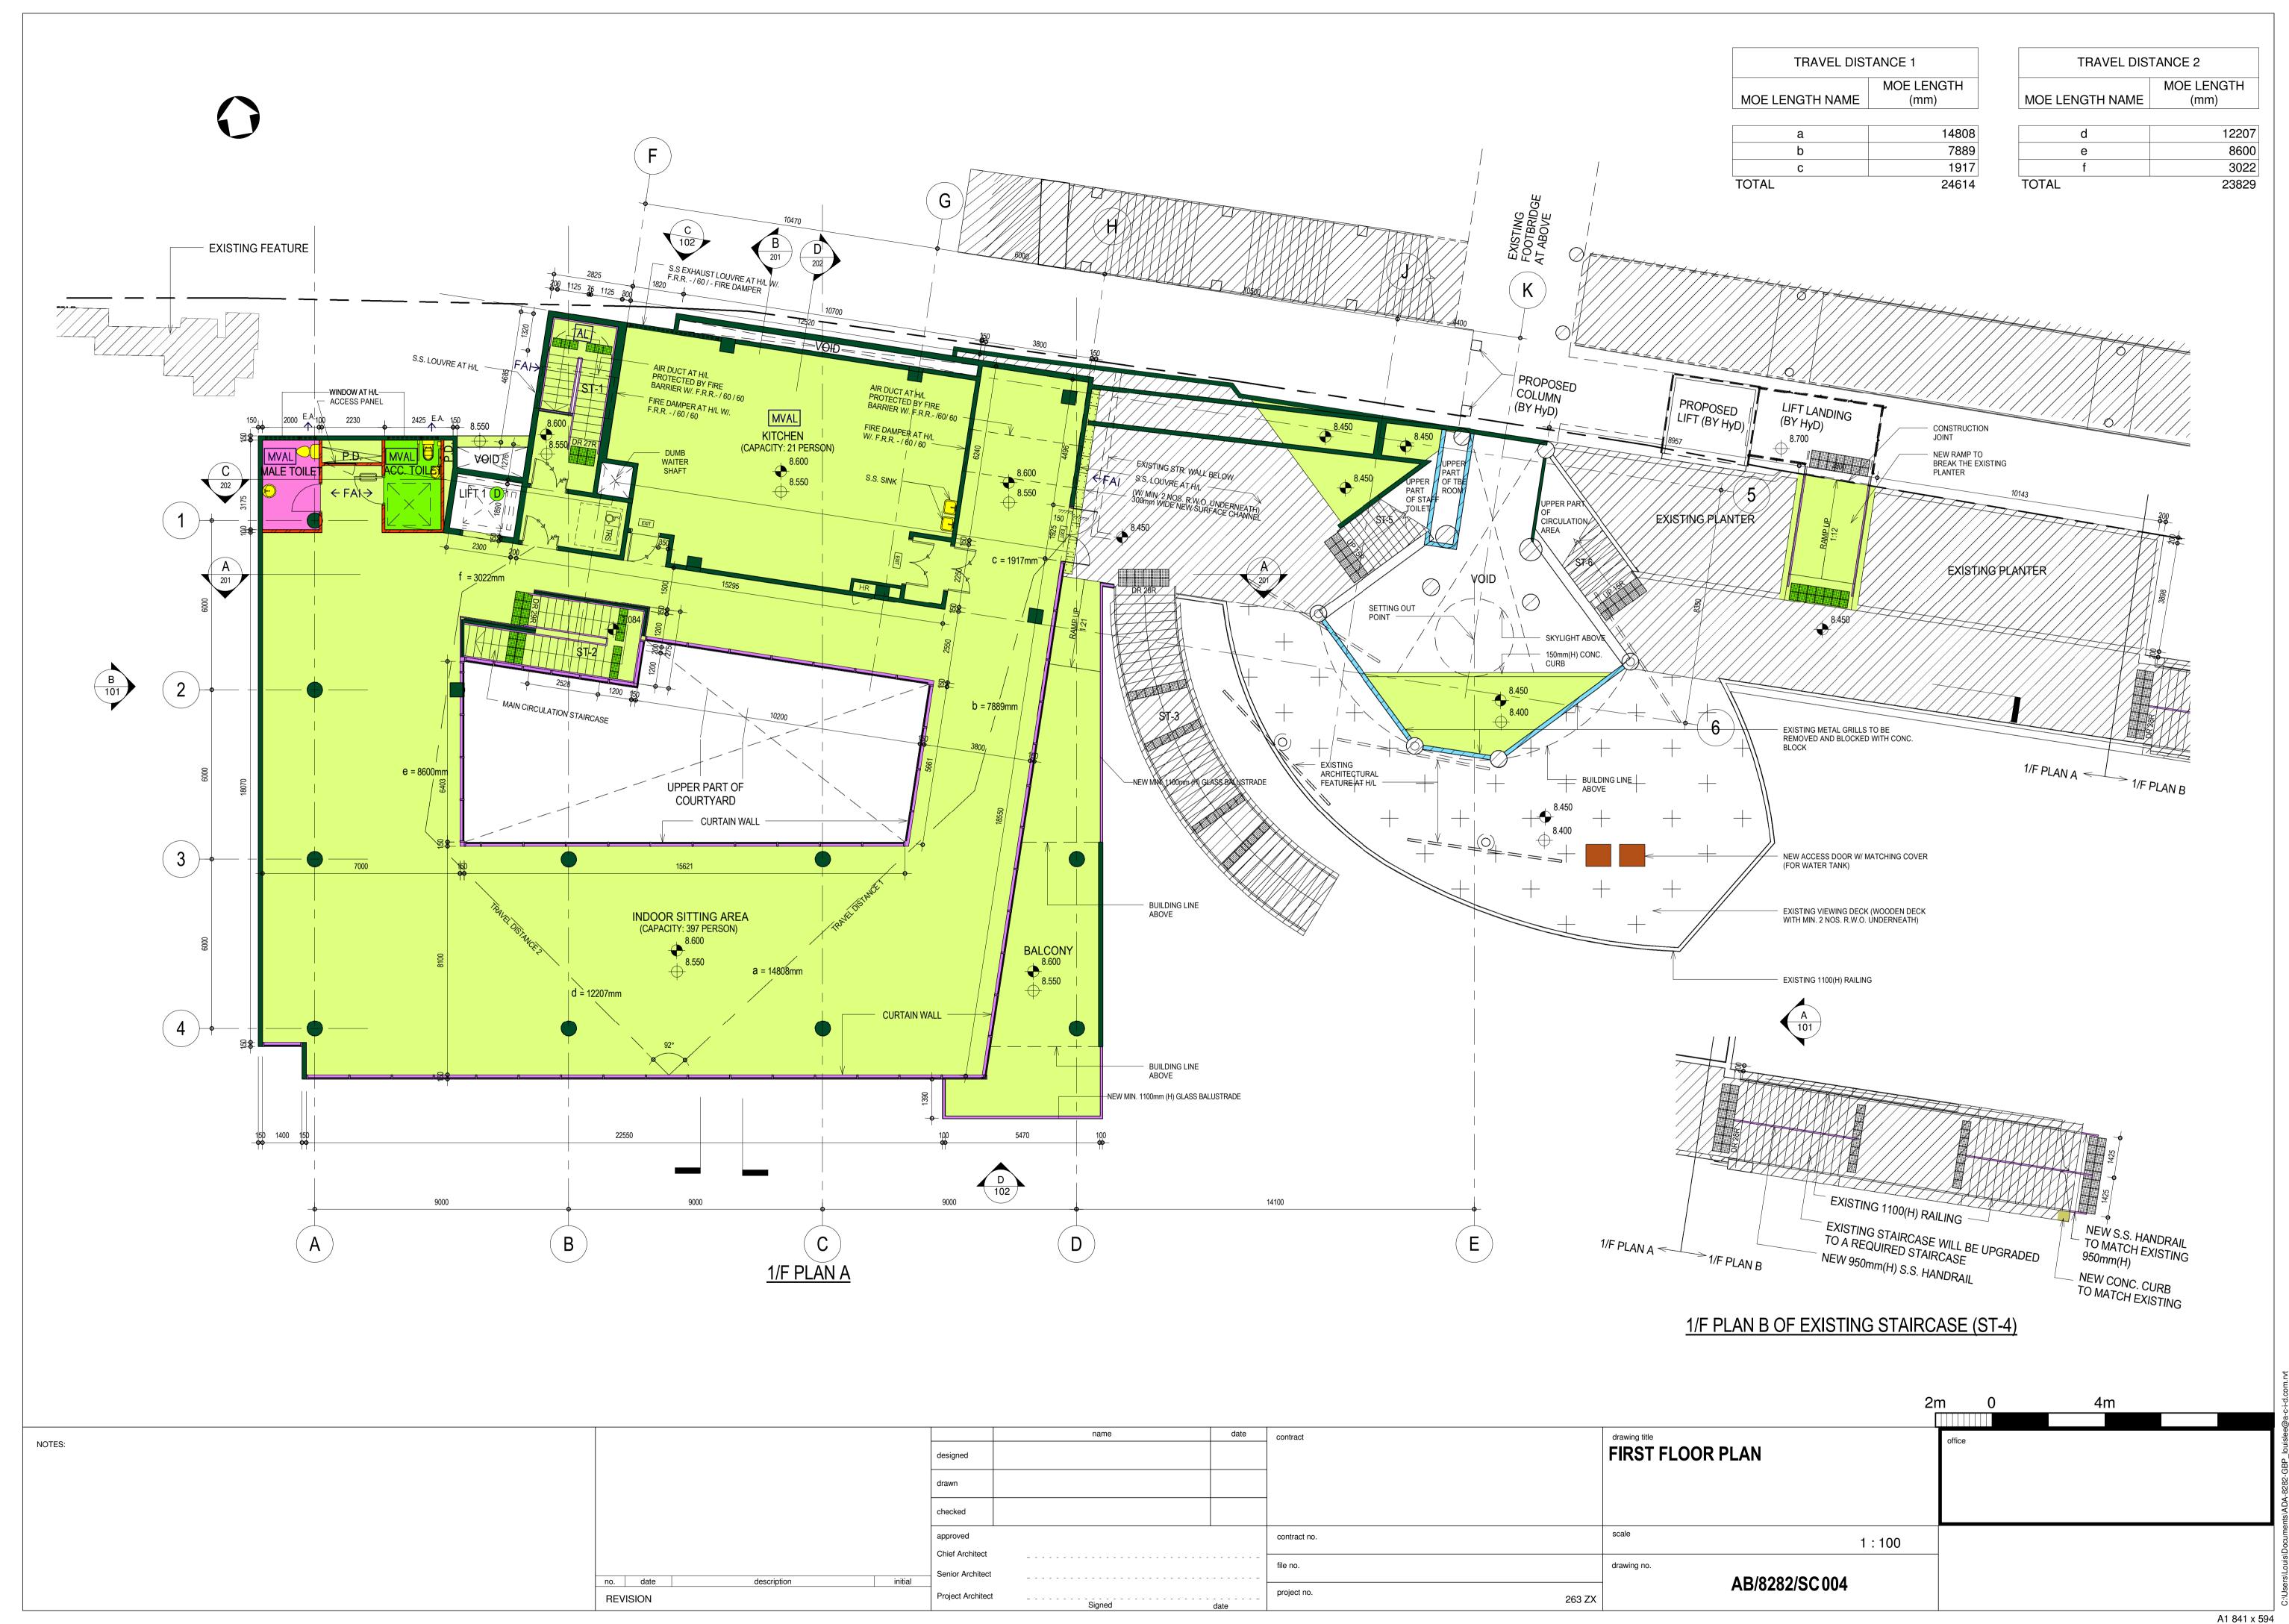


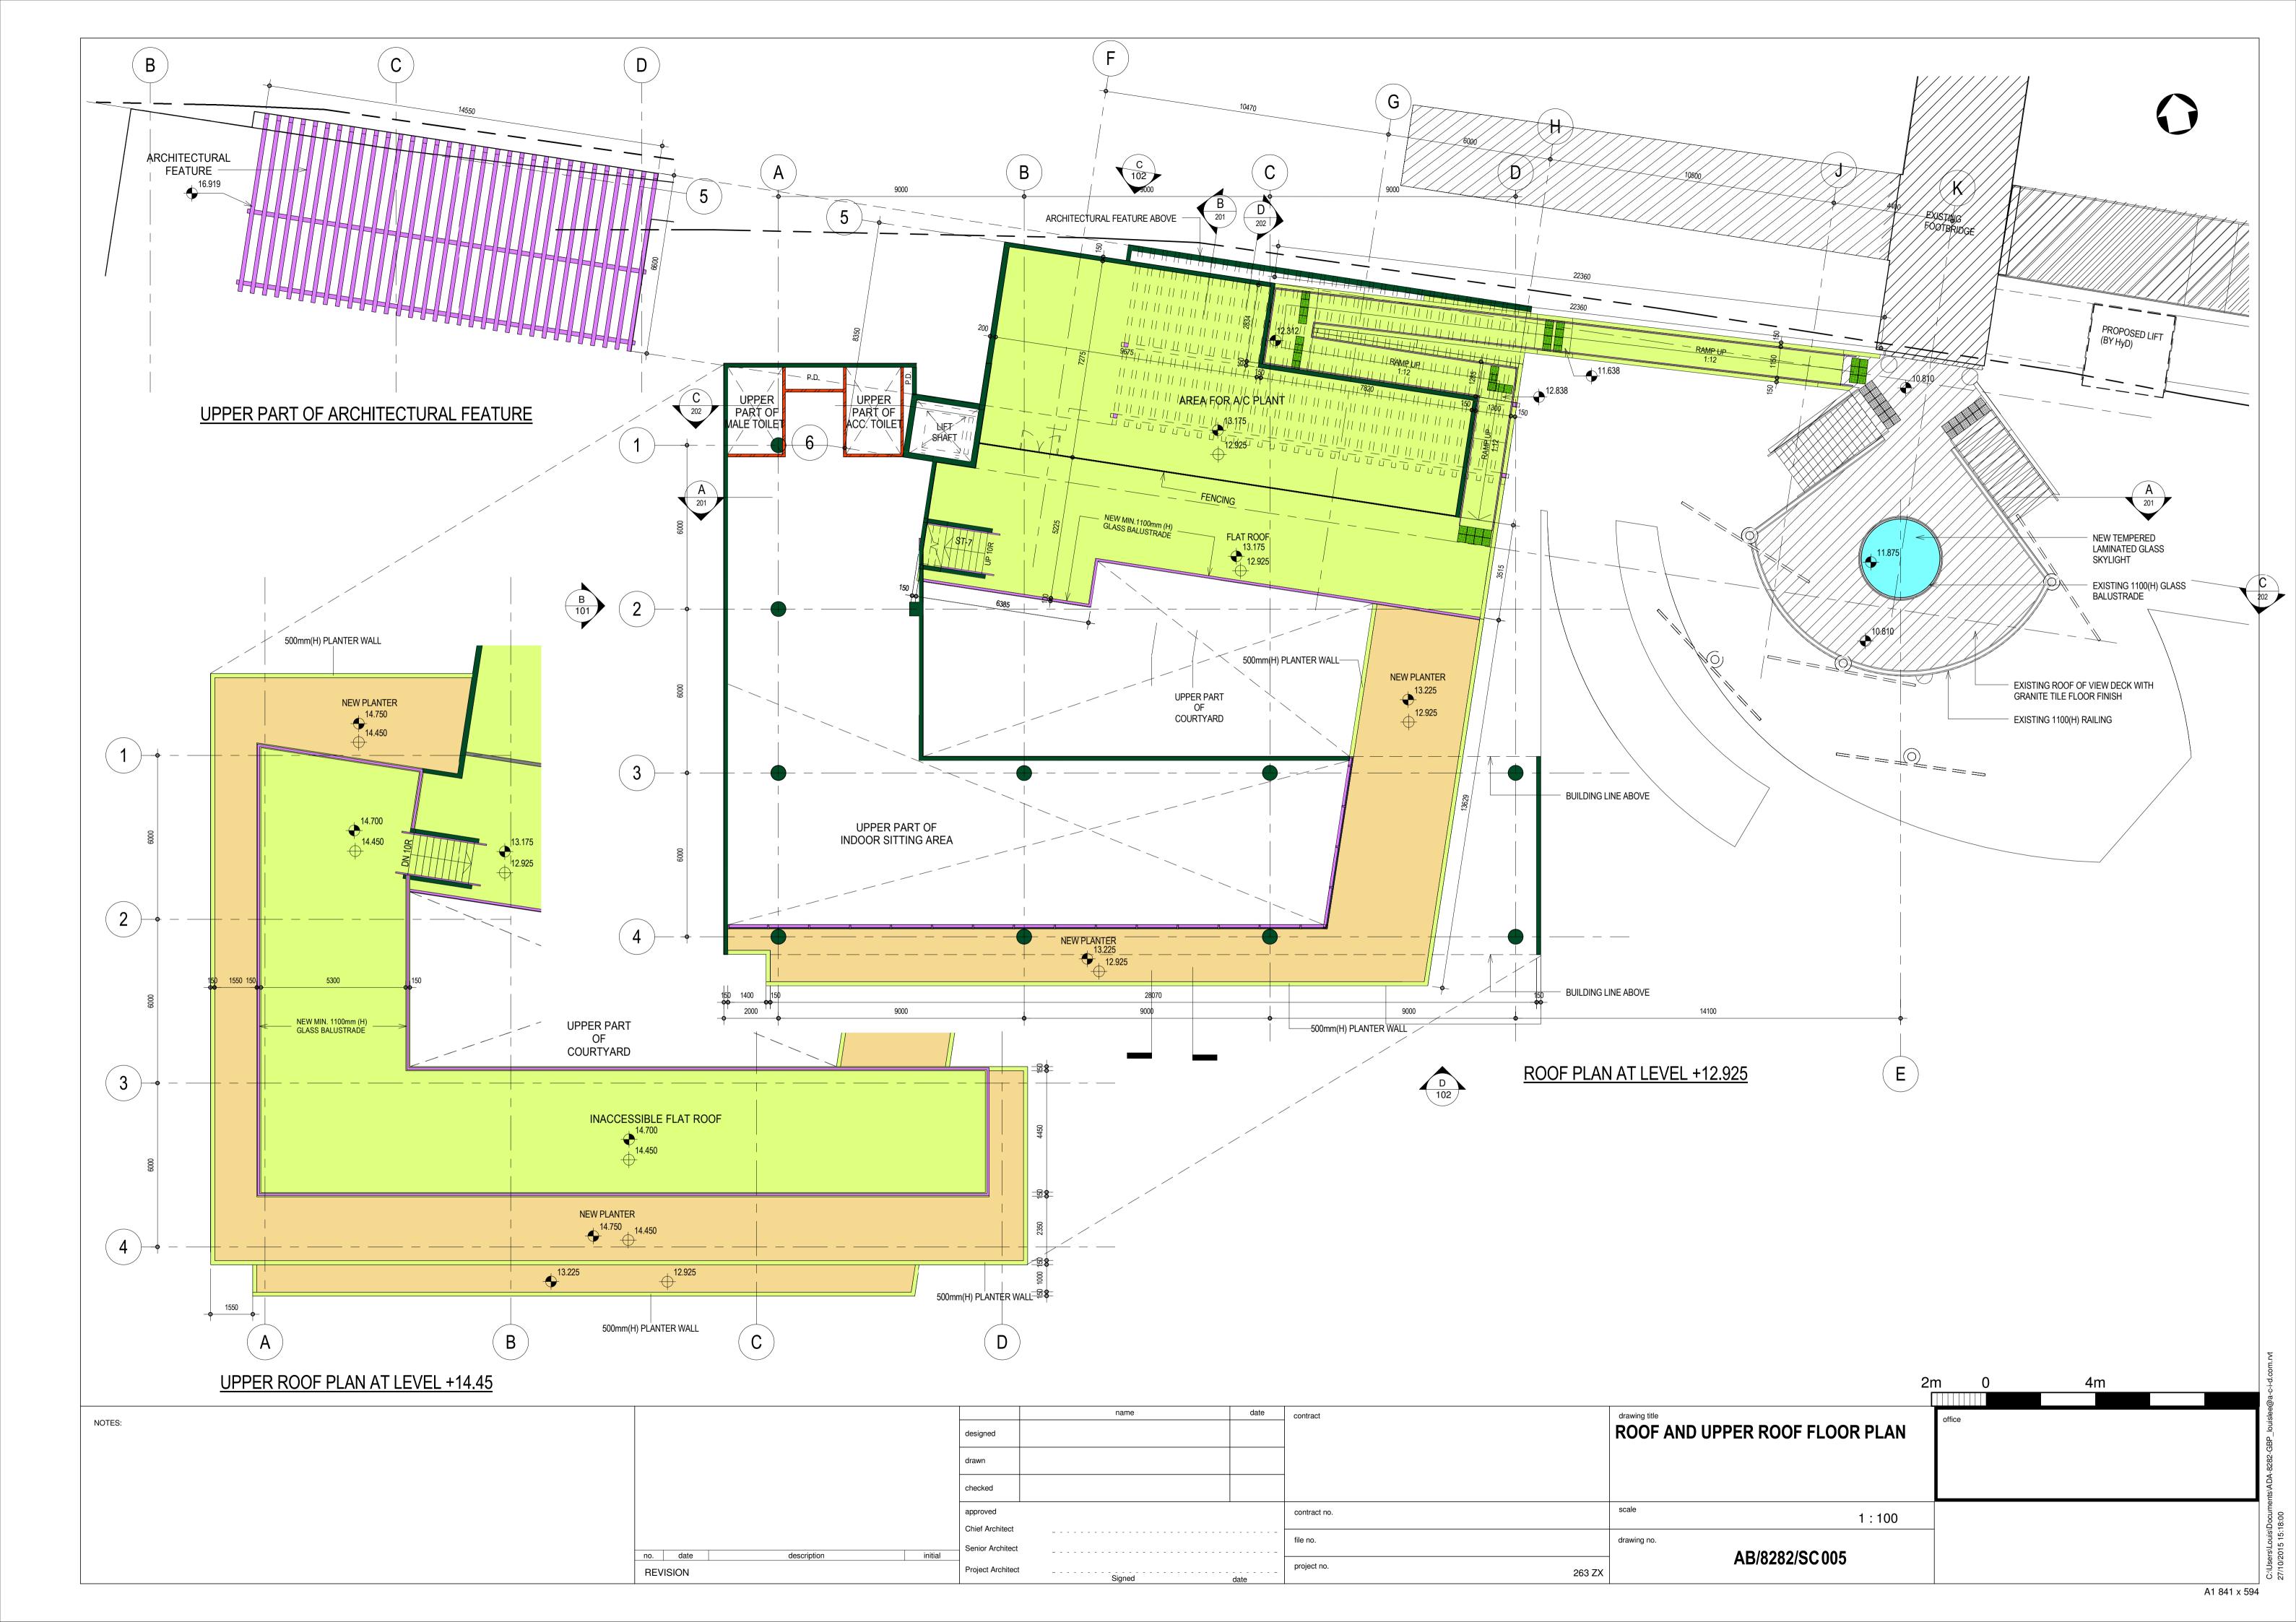

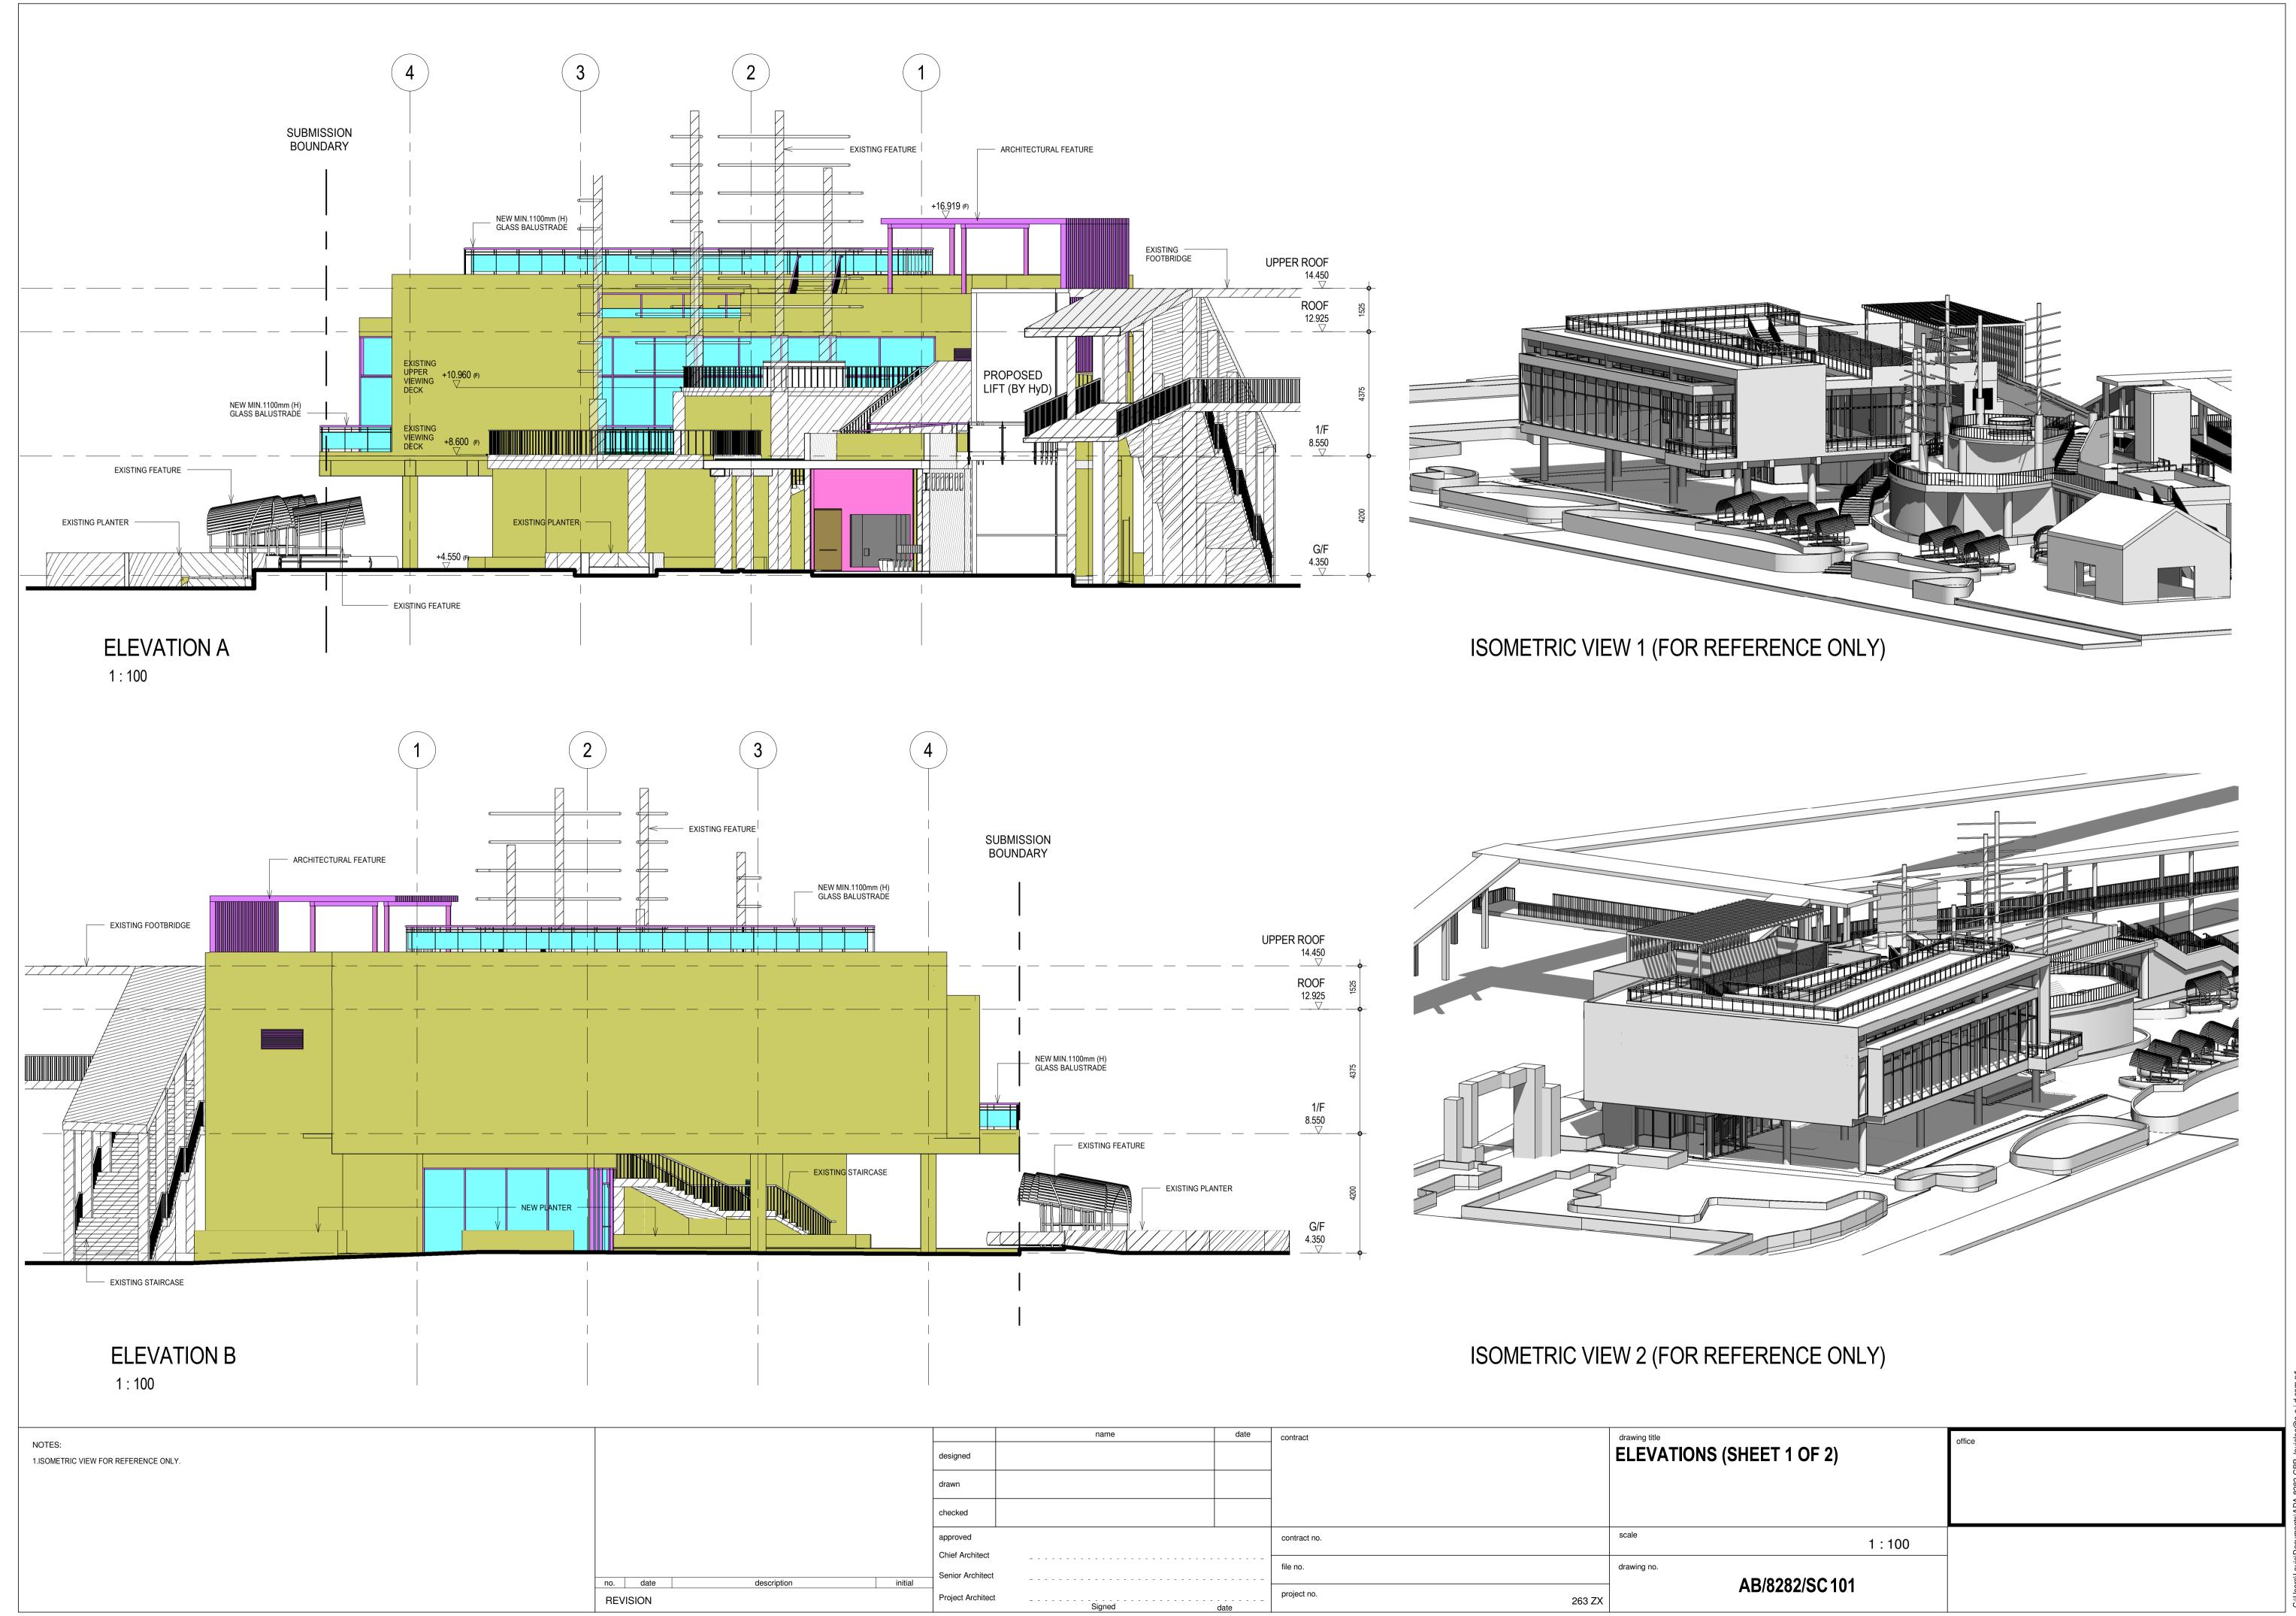

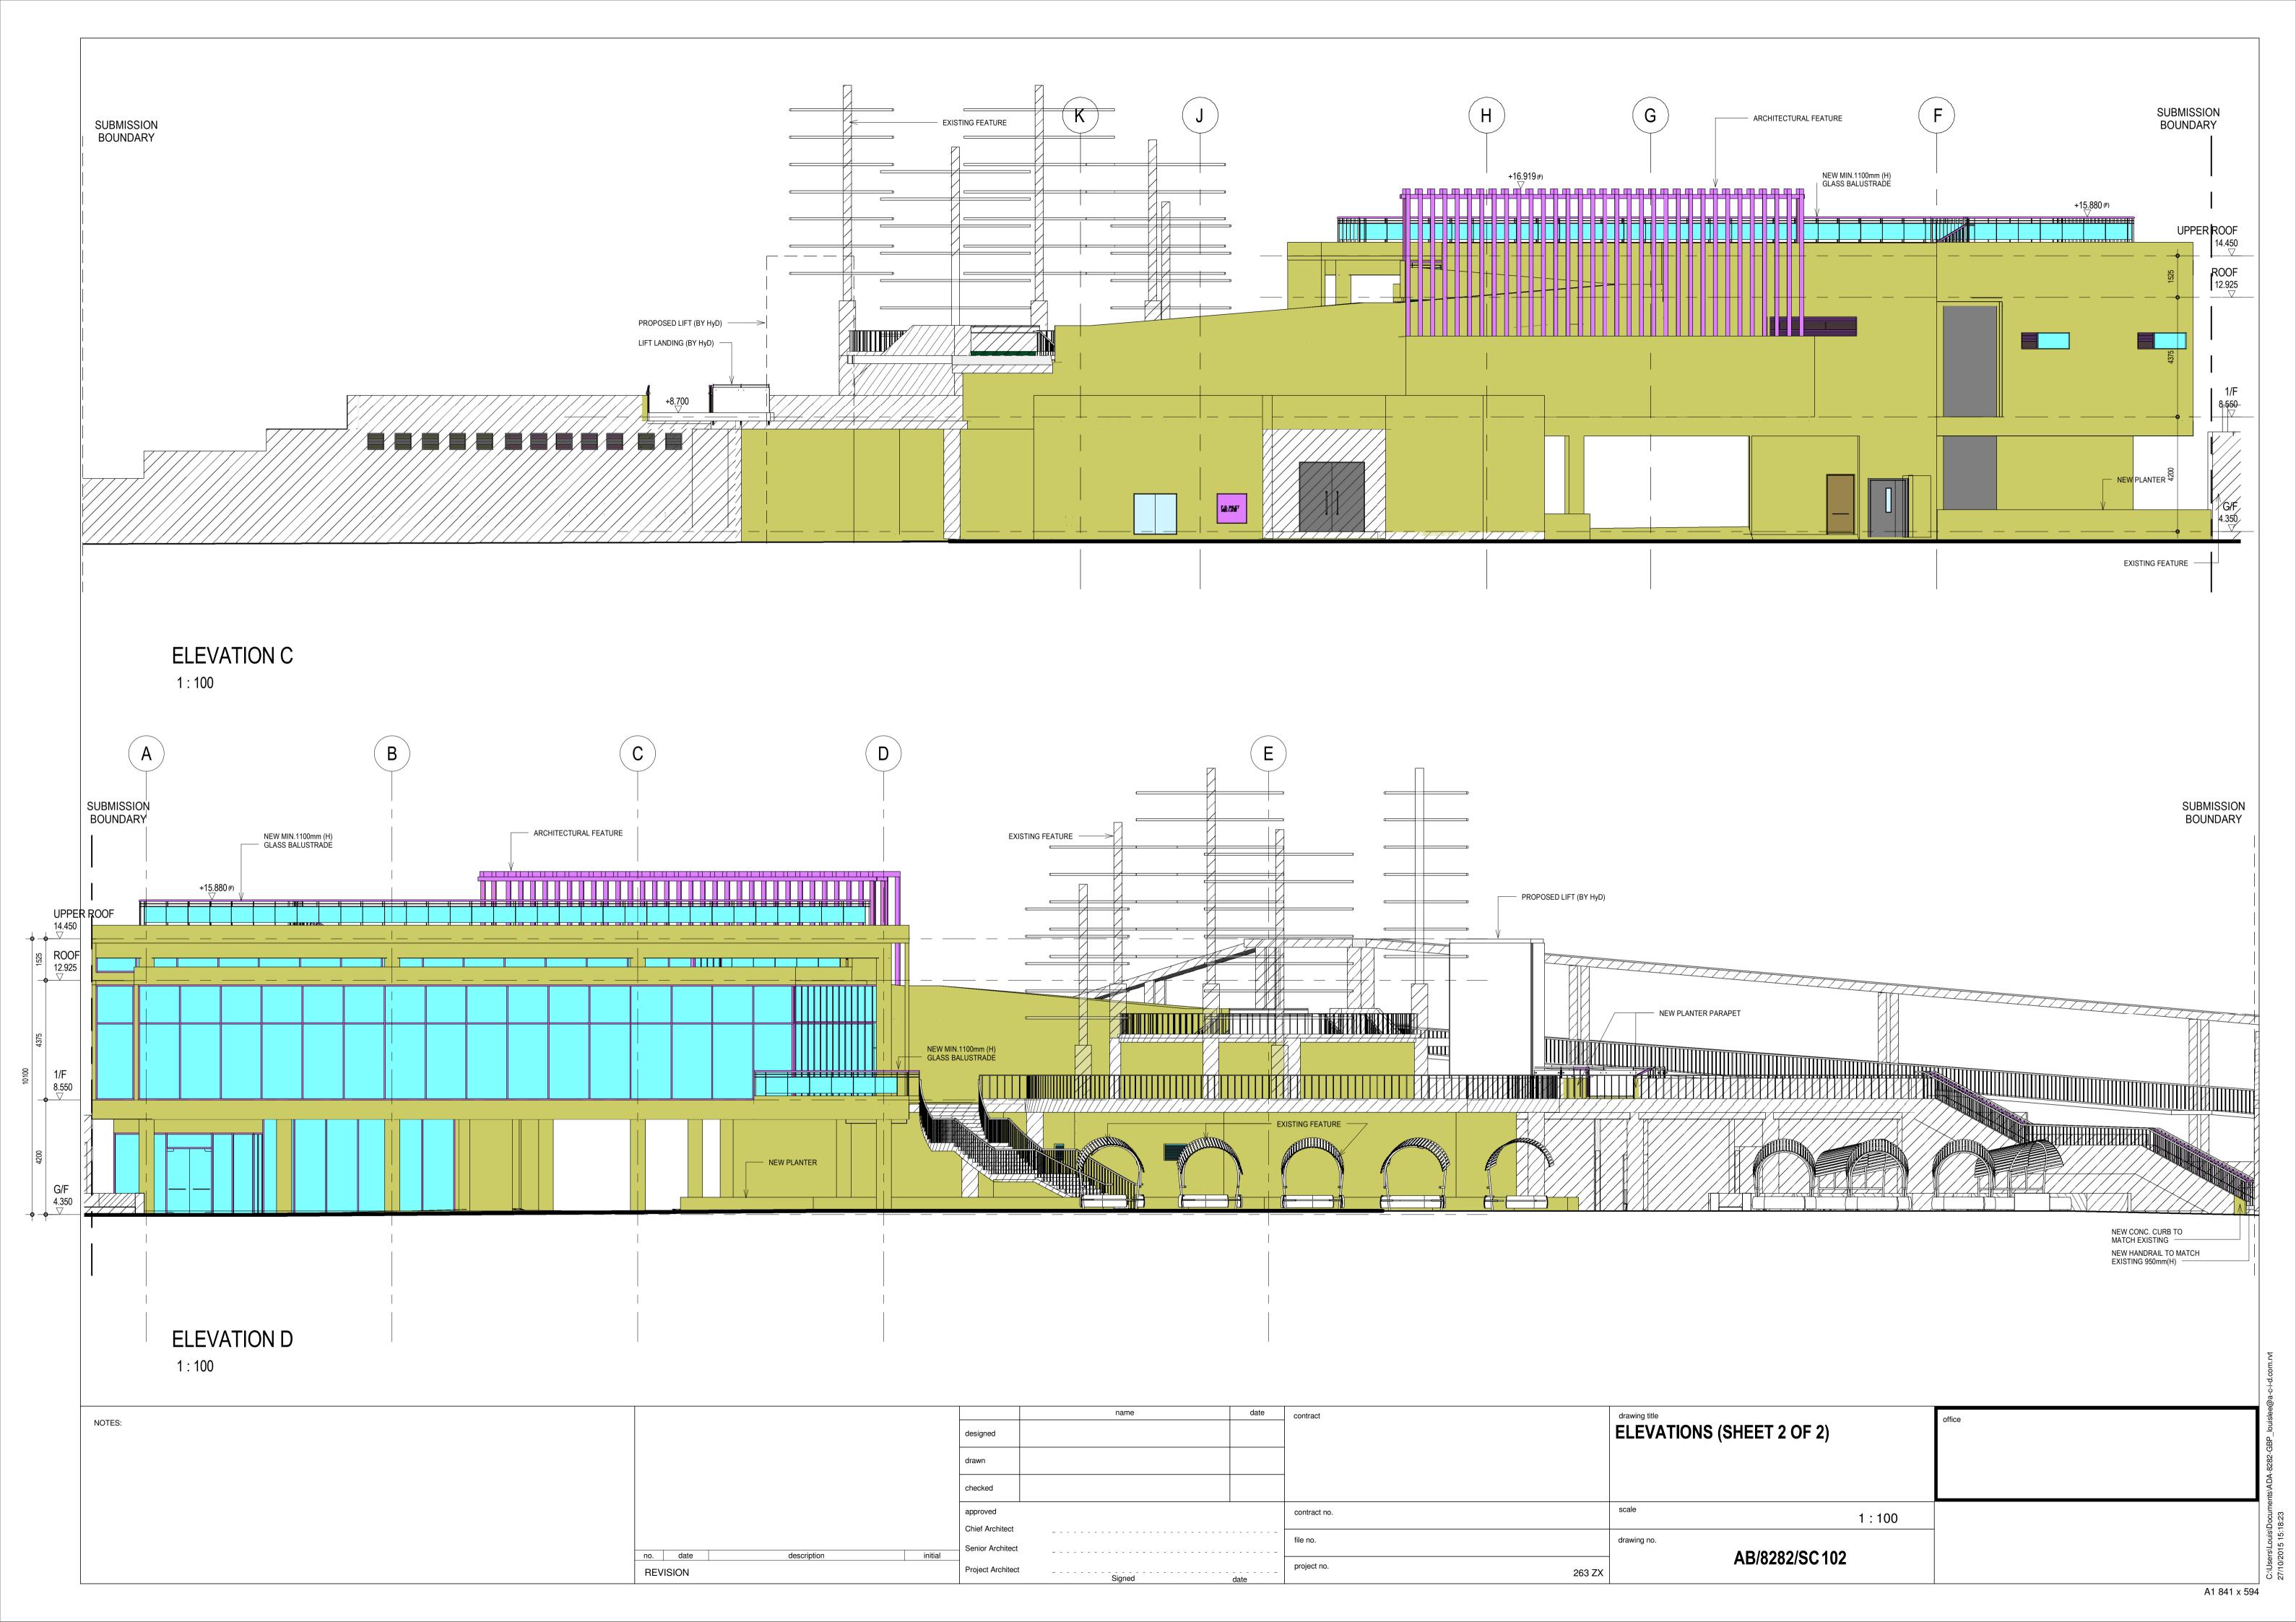

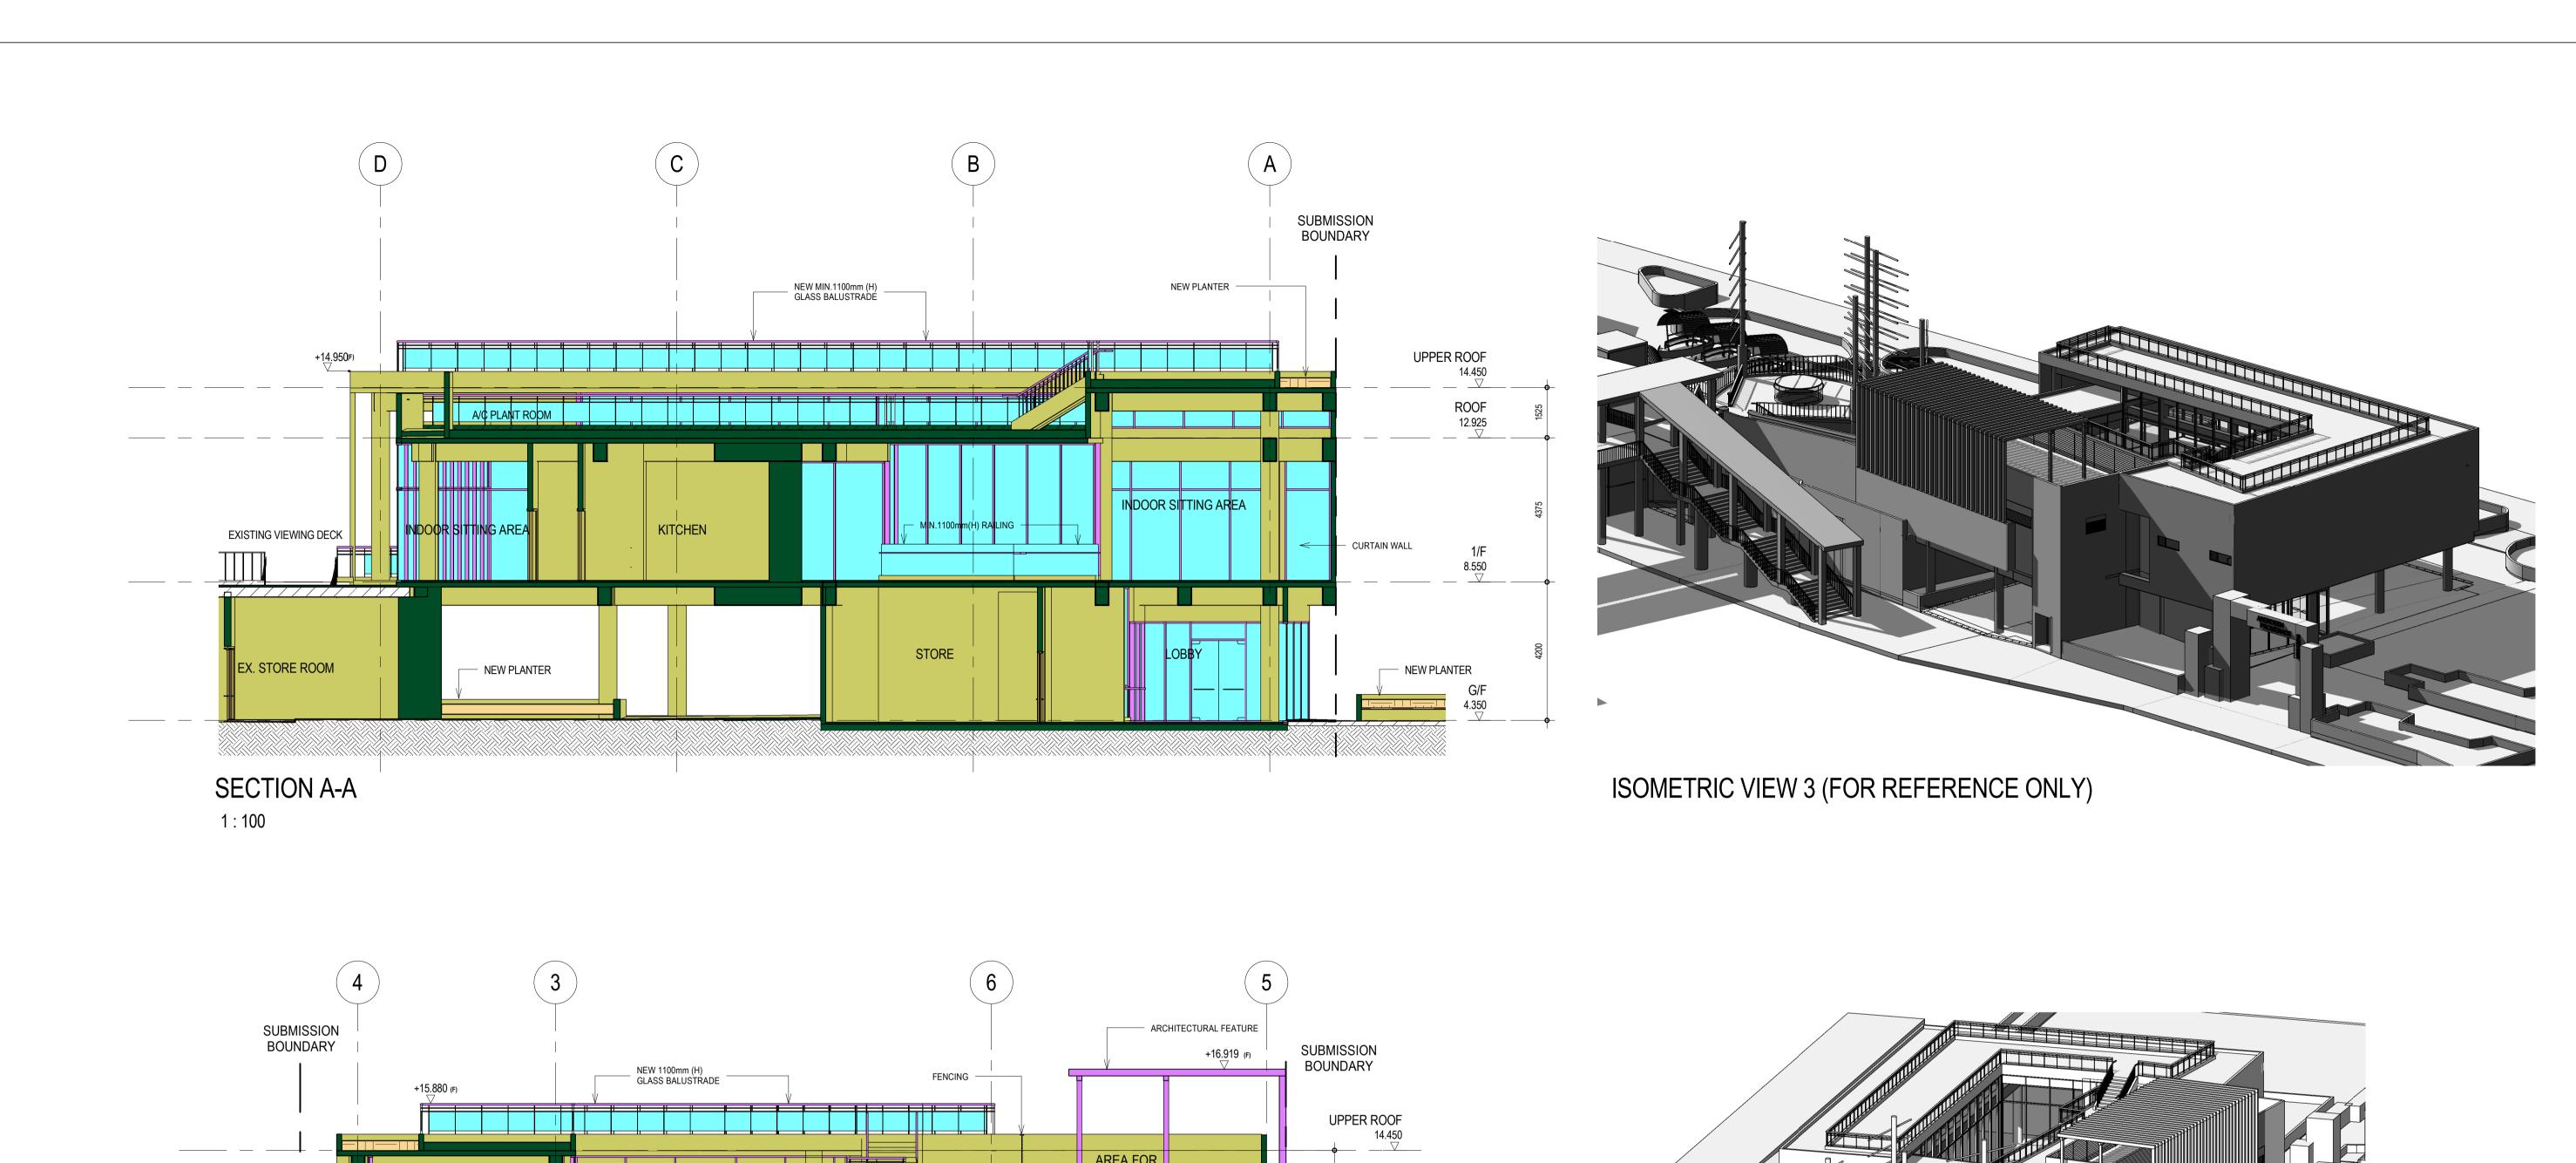

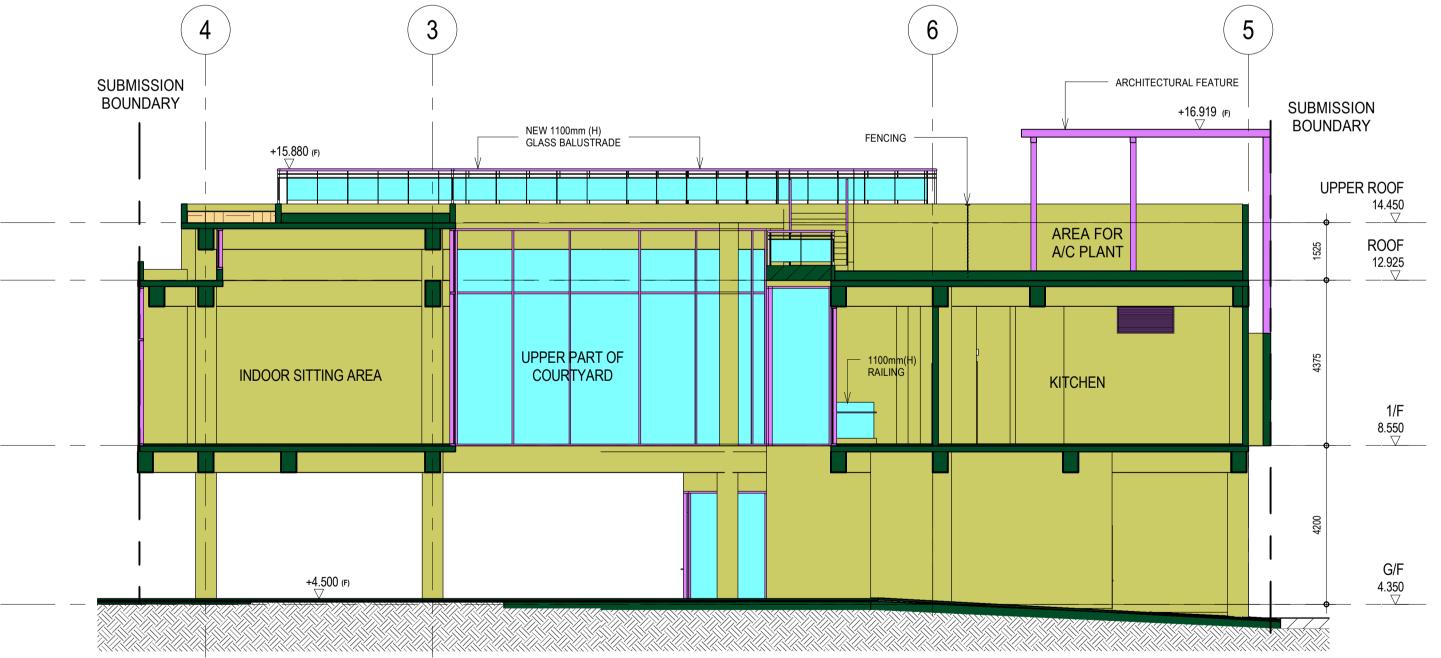





CROSS SECTION B-B 1:100

ISOMETRIC VIEW 4 (FOR REFERENCE ONLY)

<u></u>						(a)
NOTES:		name date	contract	drawing title	office	islee(
1.ISOMETRIC VIEW FOR REFERENCE ONLY.	designed			SECTIONS (SHEET 1 OF 2)		P_lou
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	drawn					-828
	checked					ADA
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	approved		contract no.	1:100		Docum 8:34
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no. date description initial	Senior Architect			AB/8282/SC201		sers\l
REVISION	Project Architect	Signed	project no. 263 ZX			_ C:\U! 27/10

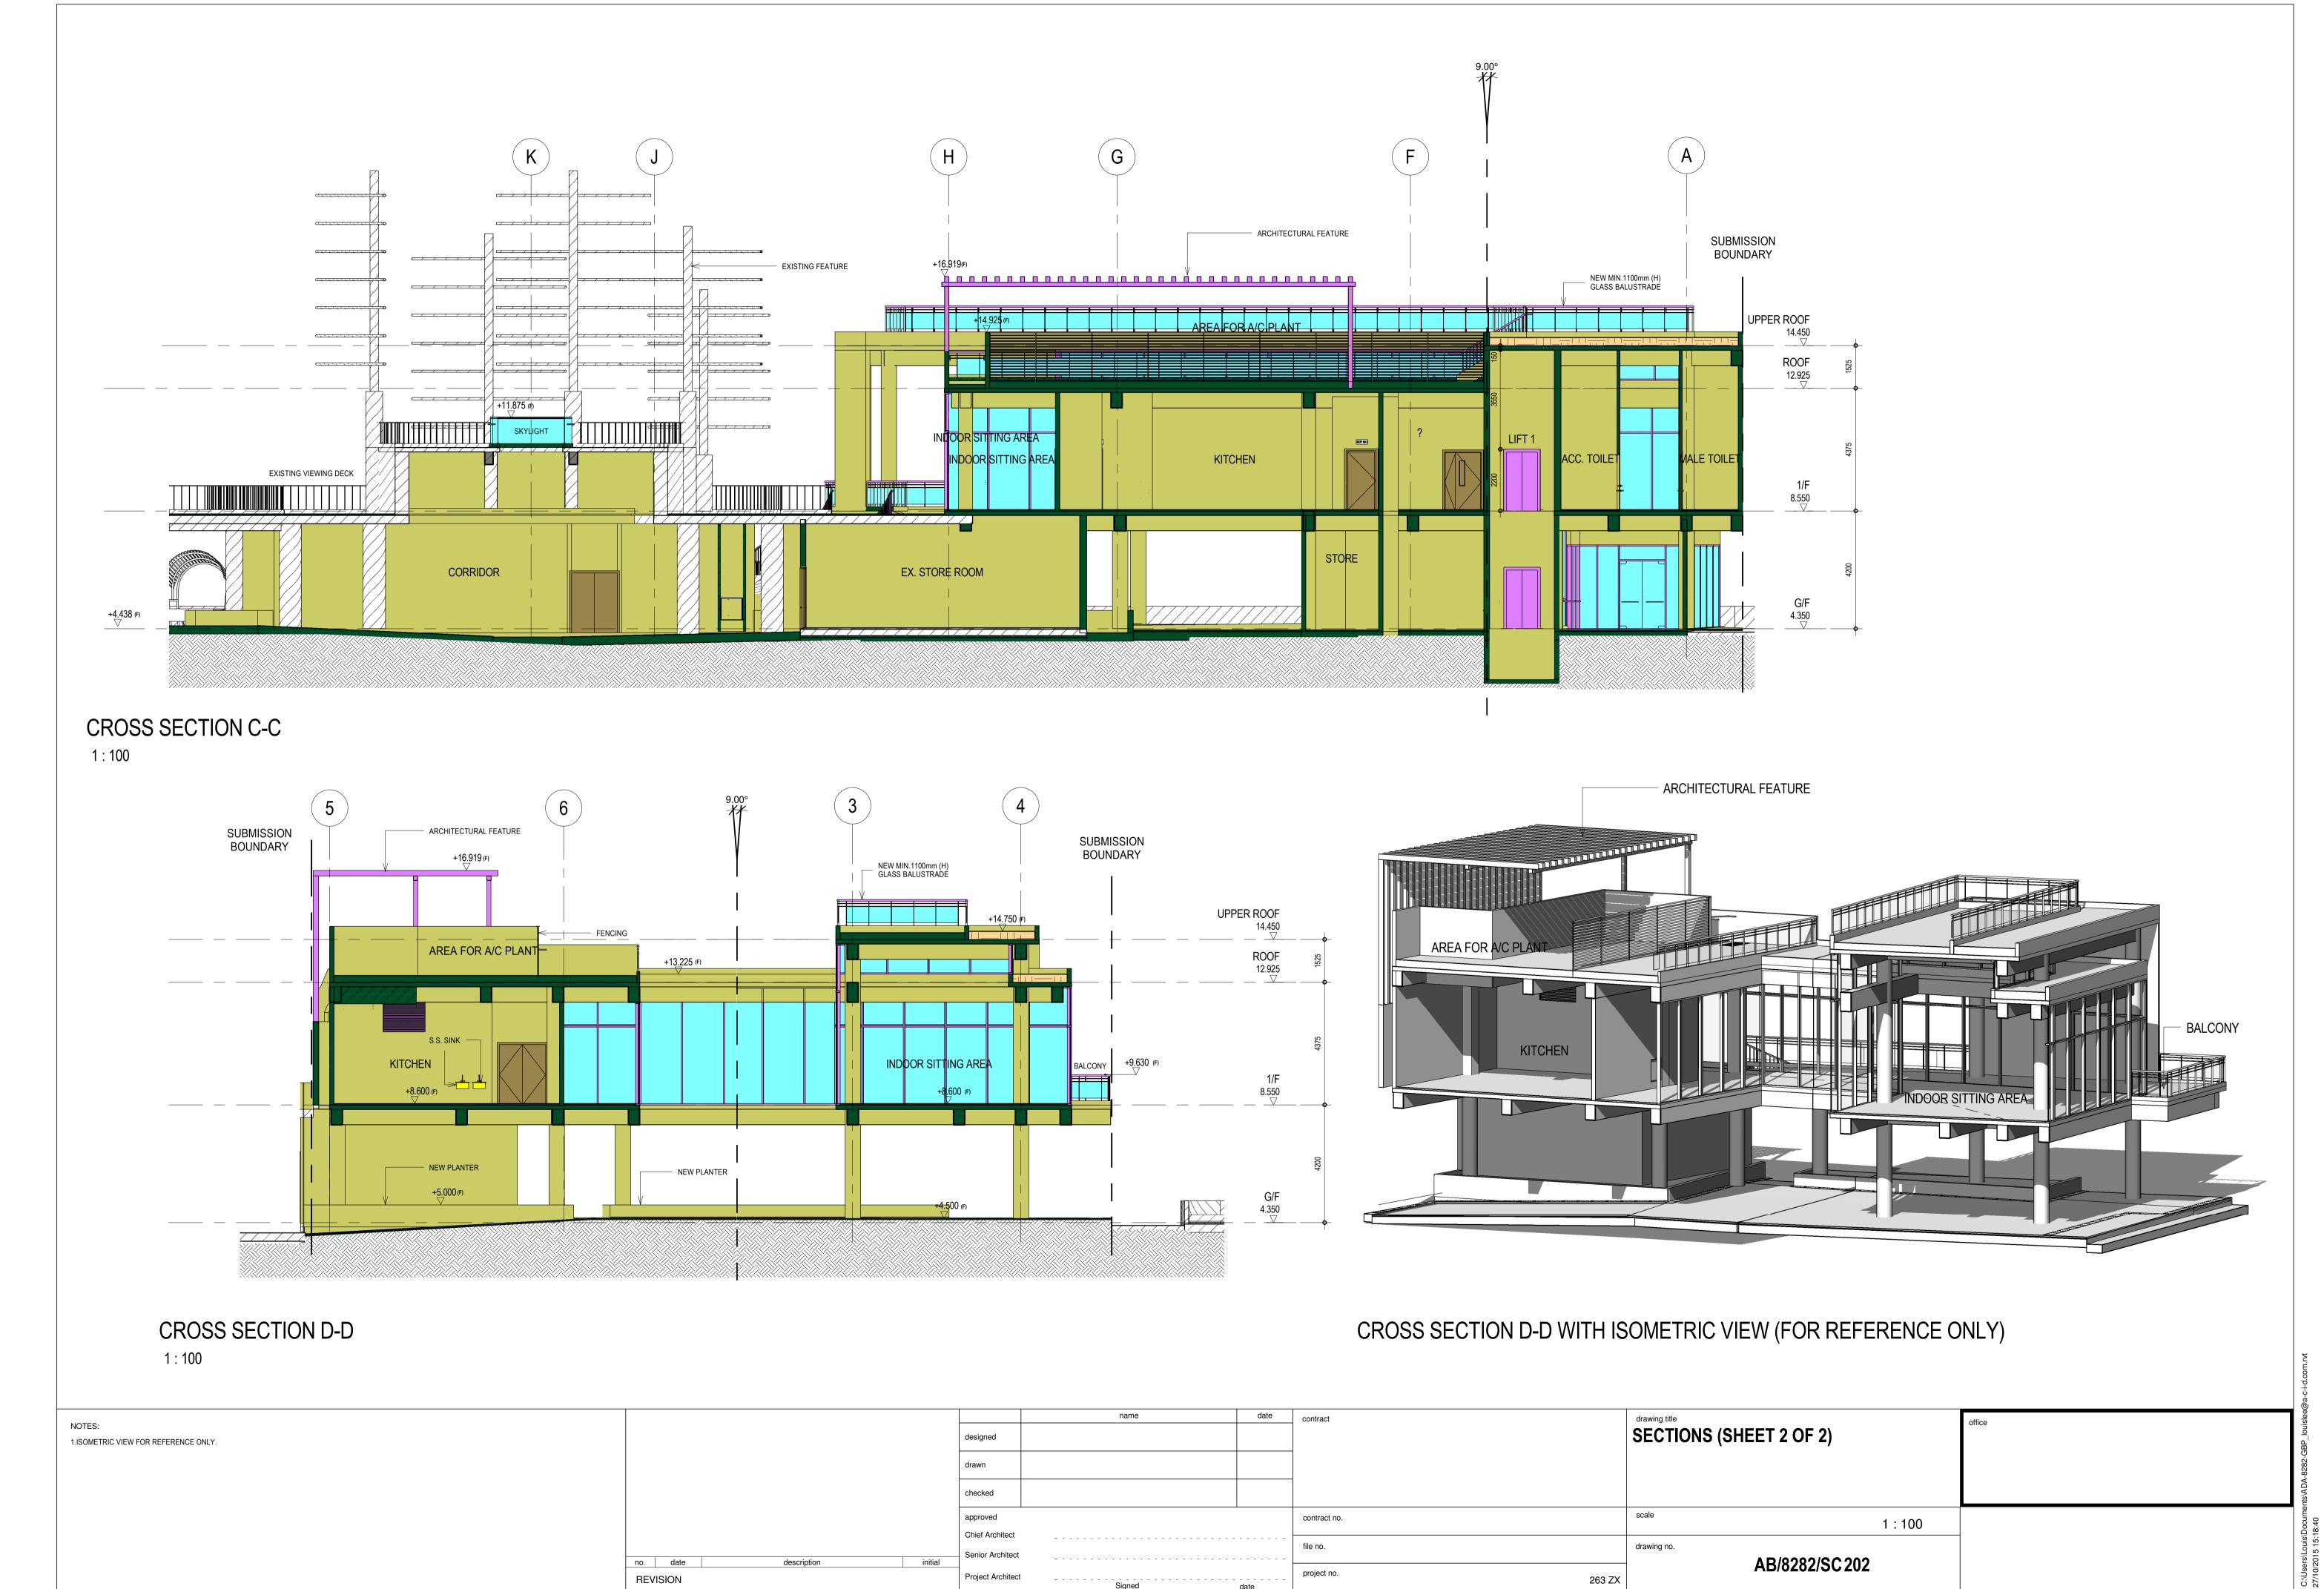

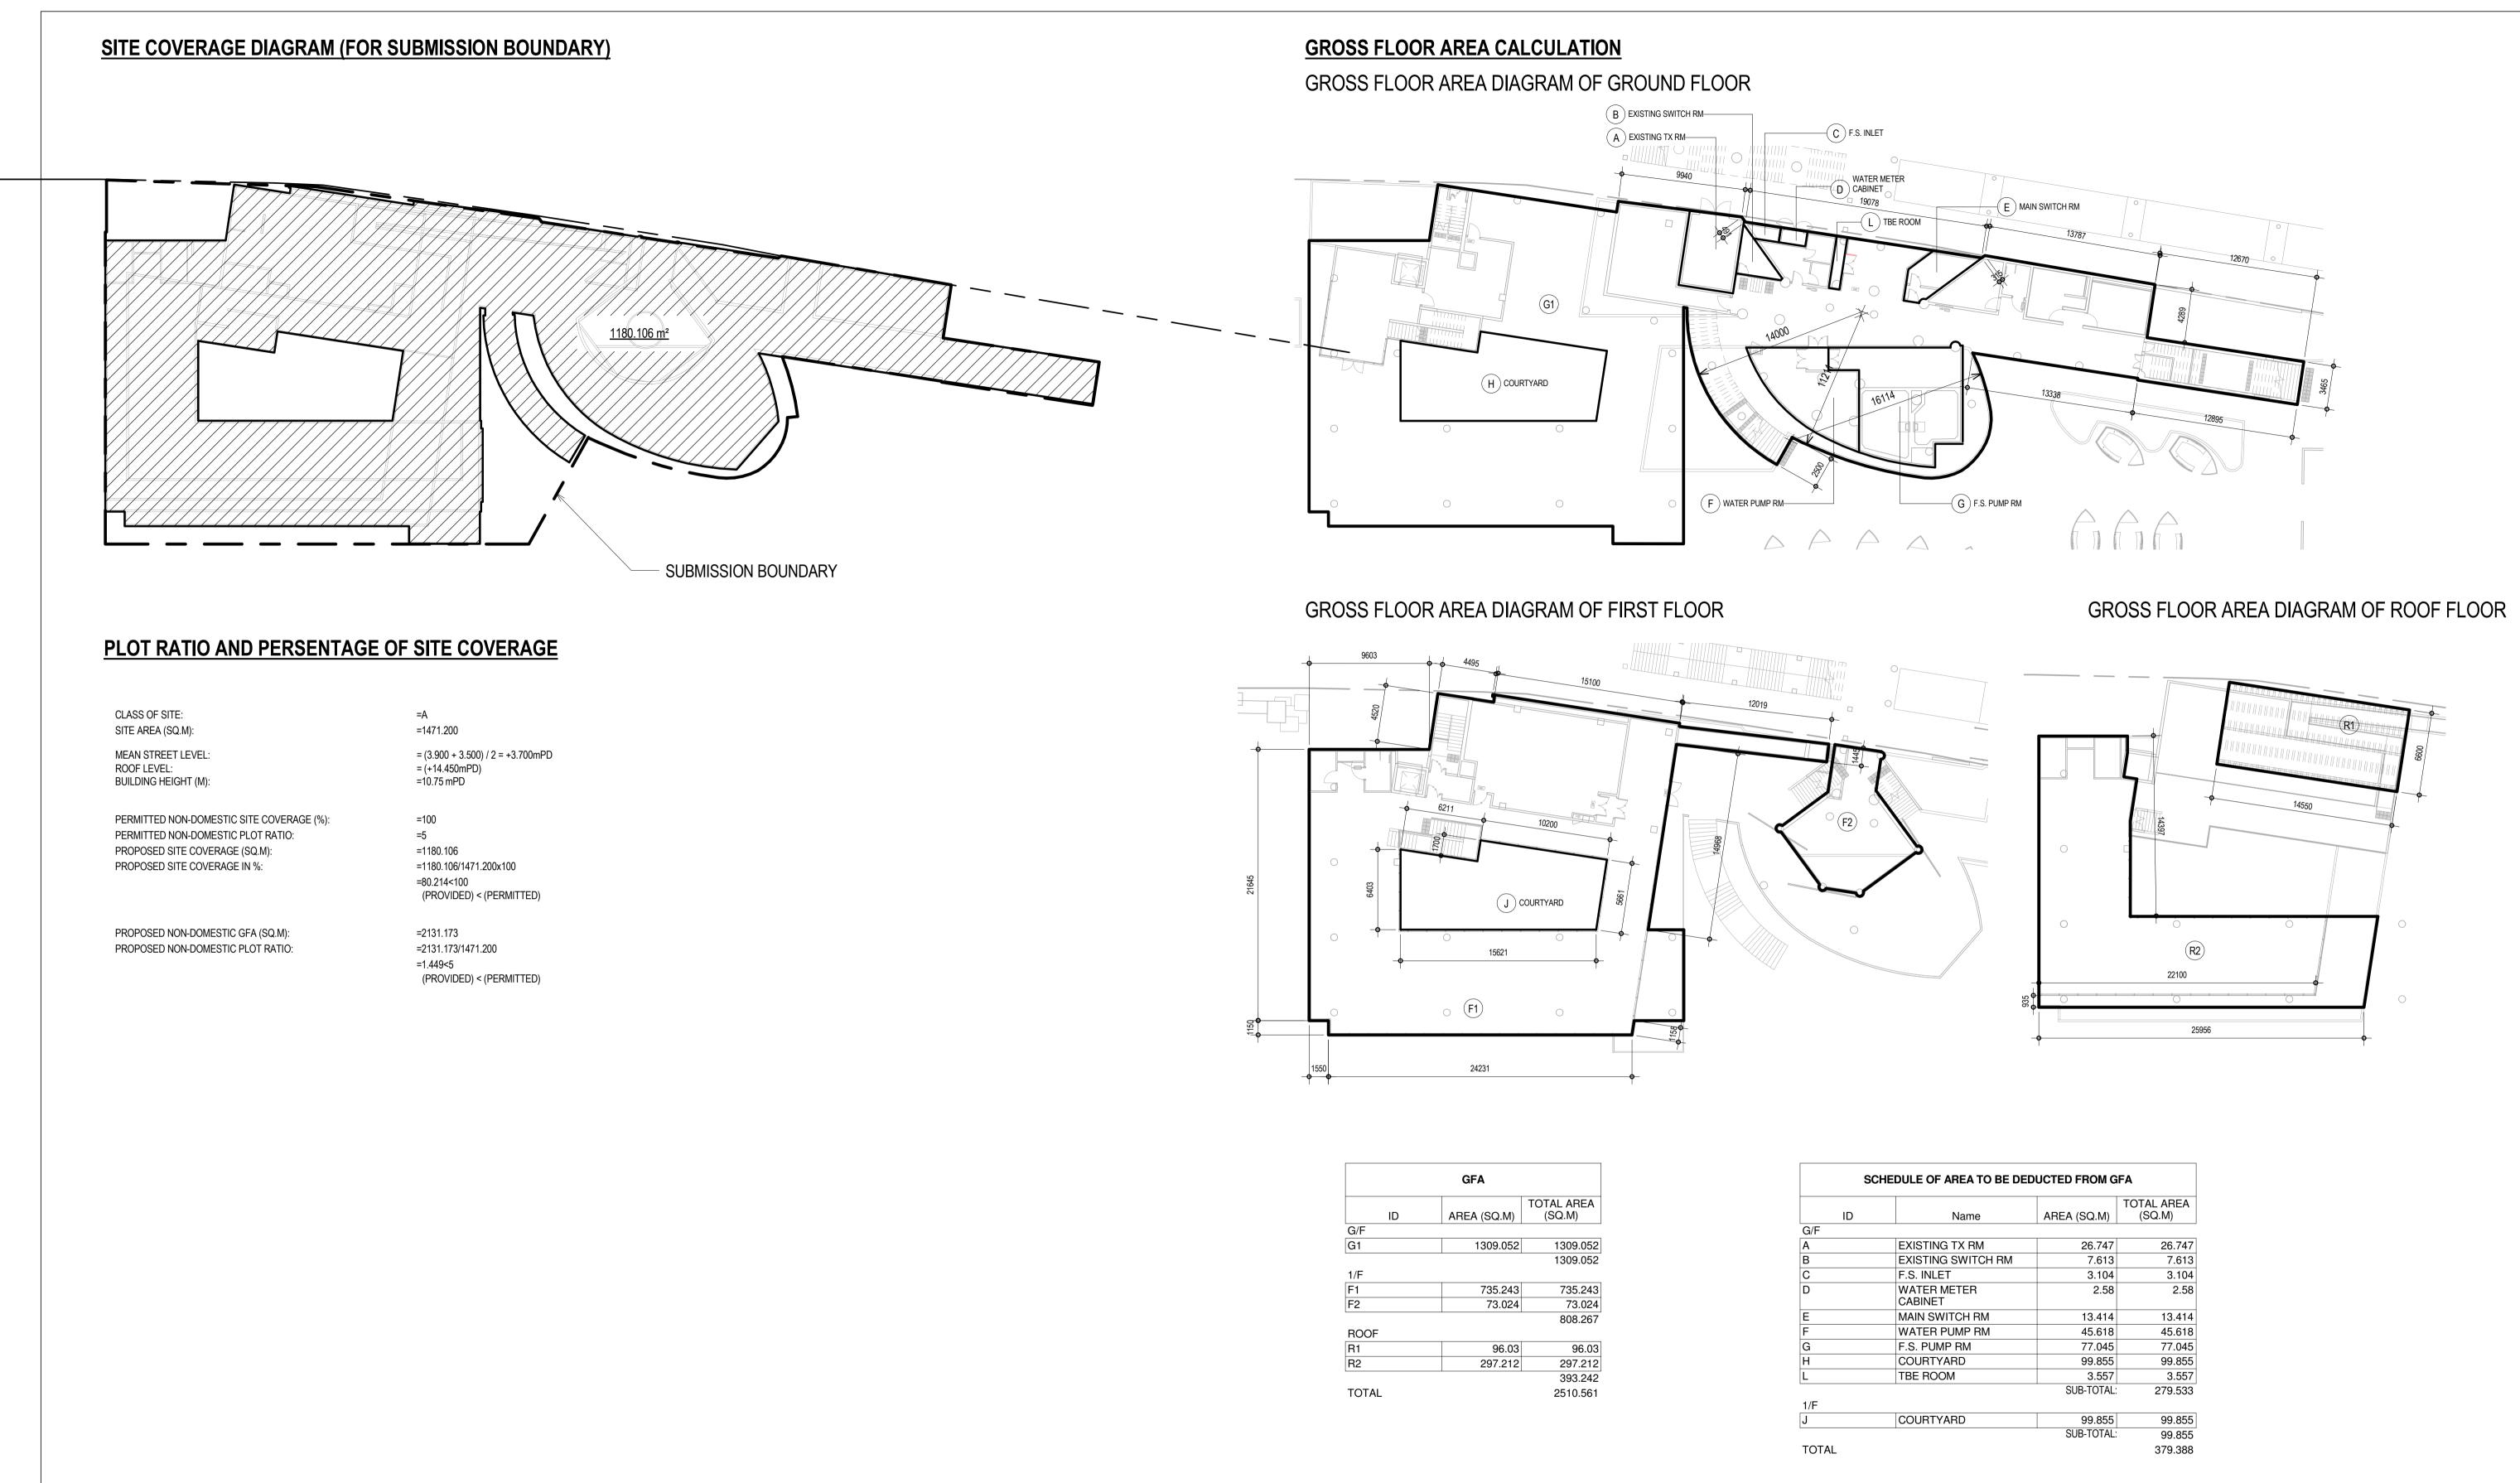


OPOSED	GFA = 2510.561 - 379.388
	= 2131.173(SQ.M)


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		Chief Architect Senior Architect		file no.	drawing no.	A D (0000)00004	
	no. date description initial REVISION	Project Architect		project no.	63 ZX	AB/8282/SC301	

U.F.A. CALCULATION FOR EXIT DOORS & EXIT ROUTES

G/F UFA DIAGRAM

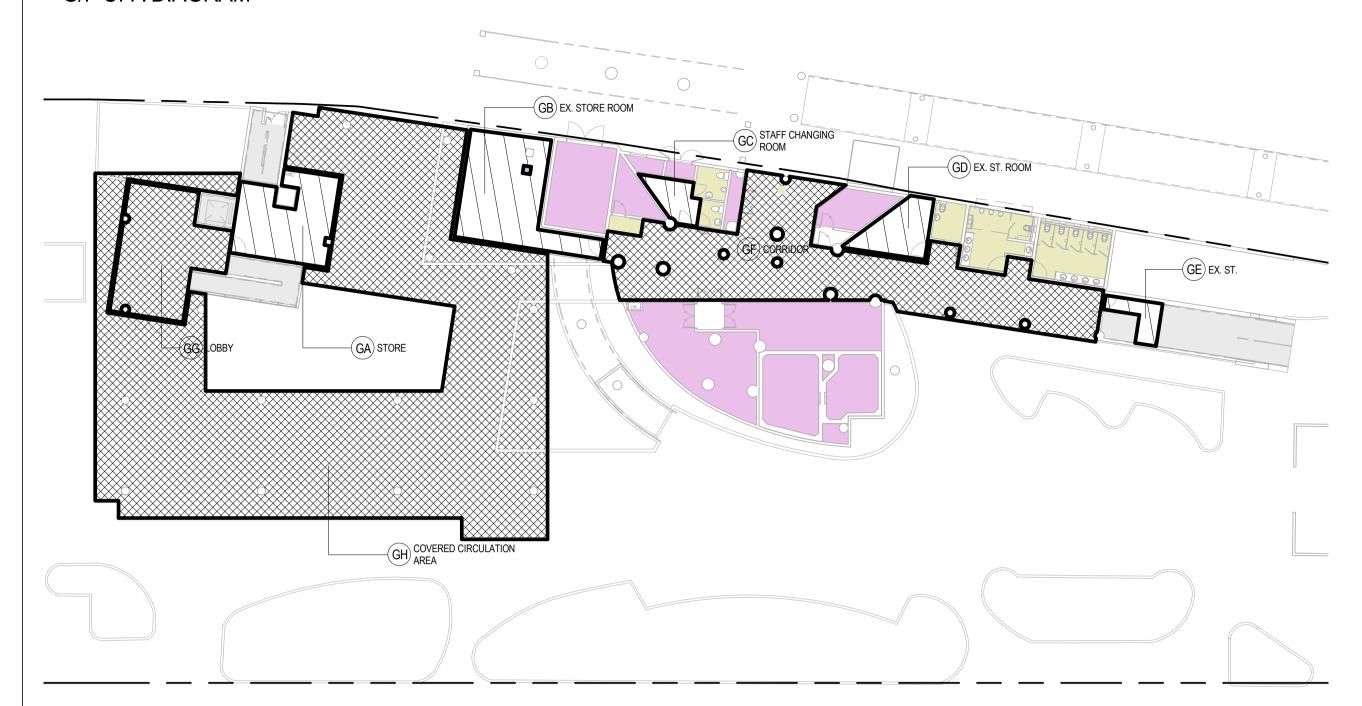

1/F UFA DIAGRAM

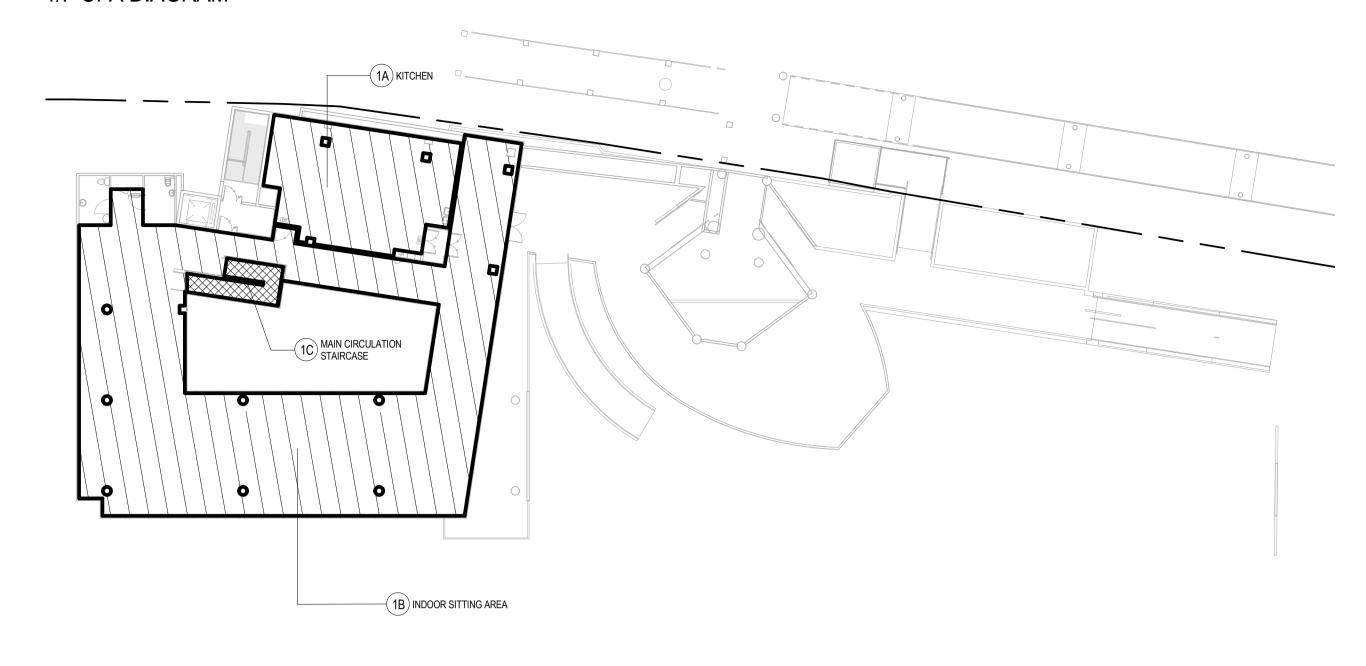

UFA

COUNTABLE UFA

U.F.A. CALCULATION FOR GROUND AND FIRST FLOOR

	SCHEDULE OF UFA											
ID	ROOM NAME	AREA (SQ.M)										
GA	STORE	32.910										
GB	EX. STORE ROOM	44.188										
GC	STAFF CHANGING ROOM	7.693										
GD	EX. ST. ROOM	14.499										
GE	EX. ST.	6.229										
	SUB-TOTAL:	105.519										
1A	KITCHEN	90.505										
1B	INDOOR SITTING AREA	396.831										
	SUB-TOTAL:	487.336										
TOTAL		592.855										

U.F.S. CALCULATION FOR GROUND AND FIRST FLOOR

SCHEDULE OF UFS													
ID	ROOM NAME	AREA (SQ.M)											
0.4	ОТОРБ	20.04											
GA	STORE	32.91											
GB	EX. STORE ROOM	44.188											
GC	STAFF CHANGING ROOM	7.693											
GD	EX. ST. ROOM	14.499											
GE	EX. ST.	6.229											
GF	CORRIDOR	147.28											
GG	LOBBY	48.145											
GH	COVERED CIRCULATION AREA	485.536											
	SUB-TOTAL	786.48											
1A	KITCHEN	90.505											
1B	INDOOR SITTING AREA	396.831											
1C	MAIN CIRCULATION STAIRCASE	13.834											
	SUB-TOTAL	501.17											
TOTAL		1287.65											

THE TOTAL AREA OF U.F.S. IS 1287.827 SQ.M LESS THAN 3960 SQ.M FOR NON-DOMESTIC BUILDING. HENCE, THE REFUSE CHAMBER CAN BE UNPROVIDED.

	SCHEDULE OF EXIT DOORS AND EXIT ROUTES														
		USABLE		OCCUPANCY		O. OF EXIT S / DOORS		MIN. TOTAL (r	mm) WIDTH OF			NCH			
		FLOOR AREA	OCCUPANCY	CAPACITY OF			EXIT D	OORS	EXIT F	ROUTES	EXIT D	OOR	EXIT ROUTE		
ID	LOCATION (ROOM / AREA)	(SQ.M)	DENSITY	ROOM / STOREY	REQ'D	PRO'D	REQ'D	PRO'D	REQ'D	REQ'D PRO'D		PRO'D	REQ'D	PRO'D	
G/F							<u> </u>	'	'				'		
GA	STORE	32.91	30	2	1	1	-	900	-	TO OPEN SPACE	-	900	-	TO OPEN SPACE	
3B	EX. STORE ROOM	44.188	30	2	1	1	-	900	-	TO OPEN SPACE	-	900	-	TO OPEN SPACE	
GC	STAFF CHANGING ROOM	7.693	9	1	1	1	-	900	-	TO OPEN SPACE	-	900	-	TO OPEN SPACE	
GD.	EX. ST. ROOM	14.499	30	1	1	1	-	900	-	TO OPEN SPACE	-	900	-	TO OPEN SPACE	
GE .	EX. ST.	6.229	30	1	1	1	-	900	-	TO OPEN SPACE	-	900	-	TO OPEN SPACE	
	SUB-TOTAL:	105.519		7				'	'		'		,		
I/F															
Α	KITCHEN	90.505	4.5	21	1	2	-	2550	-	2550	750	1050 / 1575	1050	STAIR NO.3 - 1050mm WIDE	
IB	INDOOR SITTING AREA	396.831	1	397	2	2 2	3000	3000	3000	3000	1050	1200 / 1800	1050	STAIR NO.4 - 1575mm WIDE	
	SUB-TOTAL:	487.336		418		<u>'</u>		'	'				'		
TOTAL		502 855		125											

	SCHEDULE OF	DISCHARGE V	ALUE
	DISCHARGE VALI	UE OF STAIRCA BUILDING	SE IN A SPRINKLERED
STAIR NO.	WIDTH OF STAIRCASE (mm)	PERMITTED	TOTAL NO. OF FLOOR SERVED ABOVE G/F
ST-1	1125	420	1
ST-4	1688	640	1

TOTAL PERMITTED DISCHARGE VALUE = 420 + 640 = 1060 = 425 TOTAL ACTUAL DISCHARGE VALUE

					SCHEDUI	LE OF SANITAR	Y FITMENTS PRO	VISION	IS FOR	PUBLIC / FOR S	STAFF								
							CAPAC	CITY		V	V.C.			BA	SIN		URII	NAL	
					MALE /		CAPACITY OF			M.		F.	ı	M.	F				ACCESSIBLE
		USE OF	AREA		FEMALE	Capacity of	ROOM												UNISEX
LOCATION	ROOM / AREA	CLASSIFICATION	(SQ.M)	FACTOR	RATIO	Room (Person)	(PERSON)	M.	F.	REQ'D PRO'D	REQ'D	PRO'D	REQ'D	PRO'D	REQ'D	PRO'D	REQ'D	PRO'D	TOILET
1/F	INDOOR SITTING	Class 4b	396.831	1.5	1:1	265	400	200	200	2 2	4	6	4	5	4	5	4	5	
	AREA	restaurants																	
1/F	KITCHEN	Class 4b	90.505	4.5	1:1	21	61	31	30	1 1	2	0	1	1	1	0	1	0	
		restaurants																	
TOTAL										3	1	6	,	6		5		5	

NOTES:		name	date	contract	drawing title	office
		designed			UFA FOR EXITS CALCULATION, PLOT	
		drawn			RATIO, SITE COVERAGE & SCHEUDEL OF	
		checked			EXIT DOORS & ROUTES & SANITARY FITMENTS	
		approved		contract no.	scale 1:250	
		Chief Architect Senior Architect		file no.	drawing no.	
	no. date description initial			project no.	AB/8282/SC302	
	REVISION	Project Architect Signed da	ate	263 ZX		

FIRE COMPARTMENT AREA DIAGRAM OF GROUND FLOOR FIRE COMPARTMENT AREA DIAGRAM OF GROUND FLOOR (2) EXISTING TRACALL SWITCHROOM (3) 1679 SMITCHROOM (3) 1679 SMITCHROOM FIRE COMPARTMENT LEGEND

		F	IRE RESISTA	NCE REQUIR	EMENT FOR	ELEMENTS OF	CONSTRUCT	TON						
					R.C. WAI	L => 1% V.R.	R.C.	BEAM	R.C. 0	COLUMN	R.C	. SLAB	R.C.	STAIR
COMPARTMENT				FRR REQ'D		CONCRETE		CONCRETE		CONCRETE		CONCRETE		CONCRETE
(GROUP)	NAME	CLASS	AREA (m²)	(mins)	THK.(mm)	COVER (mm)	THK.(mm)	COVER (mm)	THK.(mm)	COVER (mm)	THK.(mm)	COVER (mm)	THK.(mm)	COVER (mm)
A														
A	LOBBY, COVERED AREA, EXISTING AREA AND INDOOR SITTING AREA	4b (Commercial - Mercantile facilities)	1370.89	60	75	15	200	30	200	25	100	20	95	20
			1370.89	< 2500	•							•		•
В														
В	KITCHEN	4b (Commercial - Mercantile facilities)	98.141	60	75	15	200	30	200	25	100	20	95	20
			98.141											
TOTAL			1469.031											

NOTE: 1) R.C. SLAB, WALL, COLUMN & BEAM:

* REINFORCEMENT CONSISTING OF EXPANDED METAL LATH OR A WIRE FABRIC NOT LIGHTER THAN 0.5 kg/sq.m W/. 2 mm DIAMETER WIRE AT NOT MORE

THAN 100mm CENTRES OR A CONTINUOUS

ARRANGEMENT OF LINKS AT NOT MORE THAN 200mm CENTRES SHOULD BE INCORPORATED IN THE CONCRETE COVER AT A DISTANCE NOT EXCEEDING

20mm FROM THE FACE.

FOR WALL: SOLID CONSTRUCTION OF REINFORCED CONCRETE WALL IS CONTAINING NOT LESS THAN 1% OF VERTICAL REINFORCEMENT.

** FINISHED WITH 13mm GYPSUM PLASTER ON EACH SIDE, THE THICKNESS MAY BE REDUCED TO 100mm.
2) SWITCH ROOMS OTHER THAN MAIN SWITCH ROOM AT G/F ARE NOT IDENTIFIED AS SPECIAL HAZARDS AREA.

3) IF THE SPECIAL HAZARD AREA IS CONNECTED DIRECTLY TO A PROTECTED EXIT OR REQUIRED STAIRCASE, THE FIRE BARRIERS SHOULD HAVE AN FRR

4) ALL STEEL COLUMNS AND ALL STEEL BEAMS TO BE PAINTED WITH RECOMMENDED FINISHING COAT ON INTUMESCENT COATING ON RECOMMENDED PRIMER, TO PROVIDE AN FRR OF 60/-/-

5) FOR AREAS OF SPECIAL HAZARD SHALL BE SEPARATED FROM THE REST OF THE BUILDING BY FIRE BARRIERS HAVING AN F.R.R. OF NOT LESS THAN -/120/120.

												DIMENSIO	ONS FOR	LIFT INST	ALLATION	IS [#]										
																			OVERALL							
LIFT	RATED LOAD	NO. OF	RATED SPEED	WIDTH	l (mm)	DEPTH	H (mm)	MAX AR	EA (sq.m)	HEIGH	Γ (mm)	m) WIDTH DEPTH WIDTH (mm) HEIGHT (mm)						(11111)				10111 41101	OW	HEADROOM		
NO.	(kg)	PASSENGERS		REQUIRED	PROVIDED	REQUIRED	PROVIDE	REQUIRED	PROVIDED	REQUIRED	PROVIDED	REQUIRED	PROVIDED	REQUIRED	PROVIDED	REQUIRED	PROVIDED	REQUIRED PROVI	DED REQUIRE	ED PROVIDEI	D REQUIRED	PROVIDED	AREA	WIDTH DE	PTH HEIGHT	
1	800	10	1.5	1400	1400	1350	1350	2	1.890 m²	2300	2300	1900	1950	2300	2300	800	1100	2100 210	1700	1800	4650	5600	#	#	#	# #

"MACHINE-ROOM-LESS" DESIGN

NOTE:

1. THE INSTALLATIONS CAN BE ACCOMMODATED IN THE PROPOSED LIFTWELLS AND MACHINE ROOMS:

2. ANY FUTURE MAINTENANCE, REPAIR, MAJOR ALTERATION, REPLACEMENT, EXAMINATION AND TESTING OF THE LIFTS CAN BE CARRIED OUT IN THE PROPOSED LIFT WELLS SAFELY AND WITHOUT DIFFICULTY;
3. THE LIFT INSTALLATIONS ARE IN FULL COMPLIANCE WITH THE CODE OF PRACTICE ON THE DESIGN AND CONSTRUCTION OF LIFTS ANDESCALATORS (COPLE) ISSUED UNDER THE LIFTS AND ESCALATORS (SAFETY)

ORDINANCE.

(B) KITCHEN	
LOBBY, COVERED AREA, EXISTING AREA AND INDOOR SITTING AREA	

FIRE COMPARTMENT LEGEND


FIRE COMPARTMENT AREA DIAGRAM OF FIRST FLOOR

SPECIAL HAZARDS

В

NOTES:

	name	date contract	drawing title	
	designed		FIRE COMPARTMENT CALCULATION,	
	drawn		SCHEDULE OF FIRE RESISTANCE REQ'T	
	checked		FOR ELEMENTS OF CONSTRUCTION	
	approved	contract no.	scale 1:250	
	Senior Architect	file no.	drawing no.	
no. date description REVISION	Initial	project no.	AB/8282/SC 303	

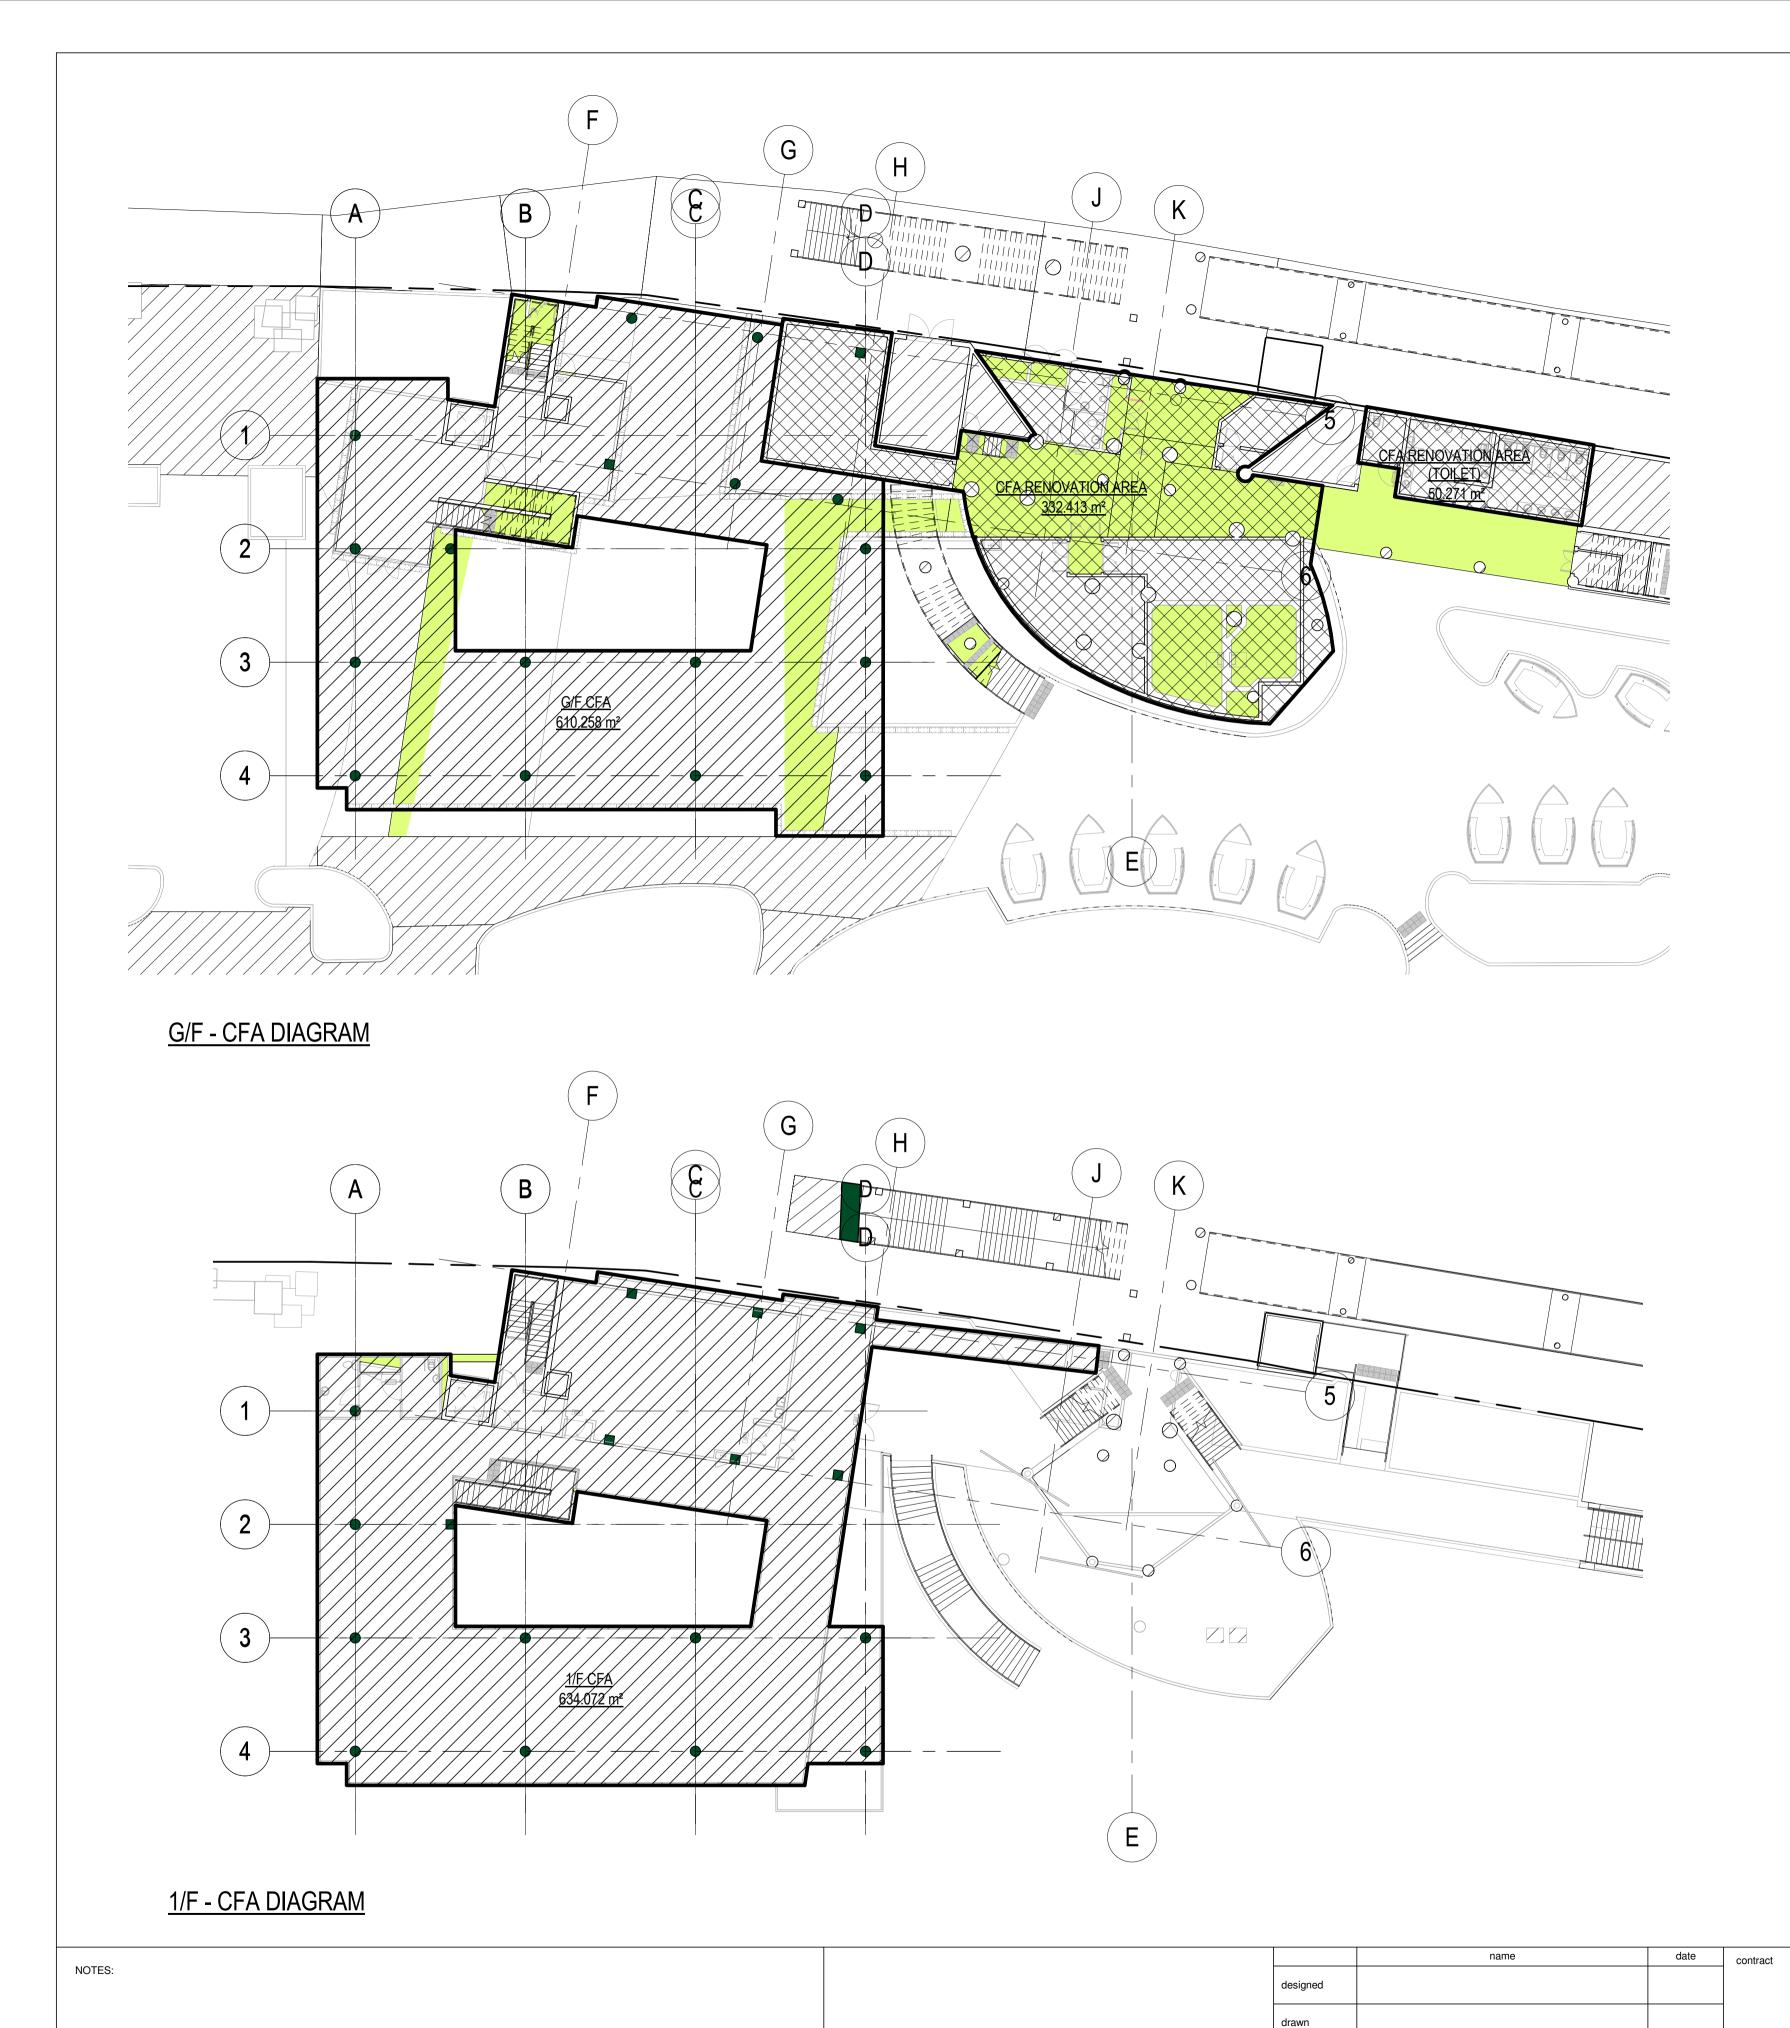

no. date

REVISION

Project Architect

	CFA SCHEDULE	
LEVEL	AREA NAME	AREA
G/F	G/F CFA	610.258 m ²
G/F	CFA RENOVATION AREA	332.413 m ²
G/F	CFA RENOVATION AREA (TOILET)	50.271 m ²
G/F: 3		992.942 m ²
1/F	1/F CFA	634.072 m ²
1/F: 1		634.072 m ²
Grand total: 4		1627.014 m ²

263 ZX

cFA CALCULATION

scale

1:200

drawing no.

AB/8282/SC SK01



	GFA Schedule (SECTION 16)	
Level	**General_Area_ID	Area
G/F	RENOVATION AREA	281.919 m ²
G/F	GF	553.345 m ²
1/F	1F	632.208 m ²
		1467.472 m ²

| NOTES: | NOTES: | NOTES: | NOTES | N