
- ARCHITECTURAL, STRUCTURAL AND E&M DRAWINGS. AIR DUCT CLEANING POINTS SHALL BE PROVIDED FOR ALL TYPES OF AIR DUCTS, INCLUDING SUPPLY, RETURN, EXHAUST AND TRANSFER DUCTS. AIR DUCT CLEANING POINTS SHALL BE AT APPROX. 4m APART, BUT WITH AT LEAST ONE
- POINT AT EACH MAIN OR BRANCH DUCT UNDER ALL CIRCUMSTANCES. ALL FINAL FRESH AIR DUCT CONNECTED TO VRV/DX INDOOR UNITS SHALL NOT BE LESS THAN 150x150mm U.O.S.
- ALL CONDENSATE DRAIN PIPE TO BE INSULATED PIPES OF THE APPROPRIATE SIZES. THE INSULATION SHALL BE IN FULL COMPLIANCE WITH THE CODE OF PRACTICE FOR ENERGY EFFICIENCY OF BUILDING SERVICES INSTALLATION 2018 EDITION AND SUBMIT TO THE SUPERVISING OFFICER FOR APPROVAL
- THE THERMOSTATS FOR VRV/DX INDOOR UNITS SHALL BE INSTALLED CLOSE TO THEIR CORRESPONDING AIR RETURN LOCATION. EXACT LOCATIONS SHALL BE PROPOSED BY THE AC SUB-CONTRACTOR AND APPROVED BY THE SUPERVISING OFFICER.
- THE DESIGN, SIZING AND PERFORMANCE OF THE AIR DIFFUSERS/ LOUVRES SHALL BE CAPABLE OF HANDLING AT LEAST THE FLOW RATES AS INDICATED WITH THE BEST PERFORMANCE AND WITH NO PERCEPTIBLE NOISE OR VIBRATION. THIS SUB-CONTRACTOR SHALL NOTE THIS AND SIZE THE DIFFUSERS TO SATISFACTORILY HANDLE THE REQUIRED AIR FLOW RANGES.
- THE EXTERNAL STATIC RESSURE FOR EACH VRV INDOOR UNIT SHALL BE ADEQUATE TO CATER FOR THE LENGTH OF AIR DUCT AND SIZE/SHAPE OF DIFFUSERS/GRILLES, SO AS TO PROVIDE THE BEST PERFORMANCE WITH NO
- ALL AIR DUCTS TO BE COMPLETE WITH VCD AT EACH BRANCH OFF AND
- TURNING VANES AT EACH BEND. ALL LABELS ON CONTROL/INDICATION PANELS ETC. SHALL BE IN BOTH ENGLISH AND THE EQUIVALENT CHINESE.
- ALL LINEAR AIR DIFFUSER/GRILLE C(W INSULATED AIR PLENUM SHALL BE PRICED IN NUMBER OF THE SIZE AS SHOWN AND THE DIFFUSER/GRILLE & INSULATED
- AIR PLENUM SHALL BE PROPRIETARY MADE. ALL DIFFUSER/GRILLES/REGISTERS SHALL BE CONSTRUCTED BY ALUMINUM, U.O.S. ALL DUMMY DIFFUSER/GRILLE SHALL BE C/W ALUMINUM COVERING PLATE
- ALL FRESH AIR INTAKE LOUVRE PROVIDED BY BUILDER'S WORK SHALL BE WEATHERPROOF TYPE C/W ALUMINIUM WASHABLE FILTER REFERRING ARCHITECTURAL DRAWINGS. ALL EXTERNAL LQUVRE FOR EXHAUST/INTAKE AIR SHALL BE WEATHERPROOF TYPE AND SHALL BE INCLUDED IN BUILDING WORKS OF THE MAIN CONTRACT.
- ALL INTAKE/ EXHAUST EXTERNAL LOUVRES SHALL BE C/W 10MM GALVANISED MESH BIRDWIRES BY THE AC SUB-CONTRACTOR. ALL MOUNTING BRACKET / SUPPORTS SHALL BE HOT DIP GALVANISD TO BS EN
- THE MINIMUM SIZE OF THE CONTROL CABLE SHALL BE 1.5 sq mm AND LSOH
- U.O.S., ALL M.C.B./M.C.C.B. BOARDS/ISOLATOR FOR ACMV EQUIPMENT ARE LOCATED ADJACENT TO THE EQUIPMENT SHALL BE INCLUDED IN ELECTRICAL WORK BUT THE WIRING WORK FOR THE CONNECTION TO THE ACMV EQUIPMENT. SHALL BE INCLUDED IN ACMV WORK.
- ALL CABLES CONNECTED TO OUTDOOR EQUIPMENT TO BE 4/C XLPE/SWA/LSOH CABLES.

LEGEND

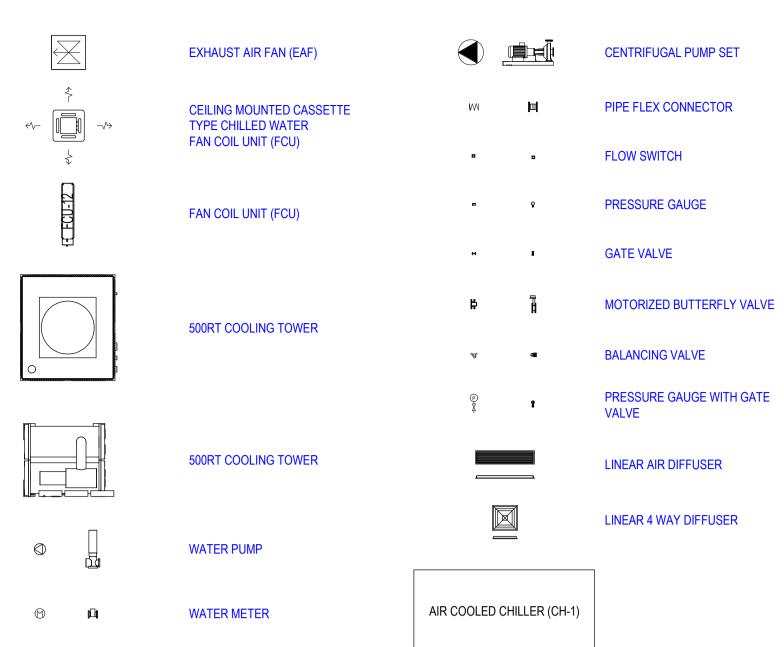

AIR COOLED CHILLER

REFERENCE ONLY

FOR REFERENCE ONLY

WALL MOUNT


EXHAUST PROPELLER FAN


A/C SWITCHBOARD FOR


SYMBOLS LINE


EXHAUST AIR DUCT (EAD) CHILLED WATER RETURN (CWR) CHILLED WATER SUPPLY (CWS)

RETURN AIR DUCT (RAD)
SUPPLY AIR DUCT (SAD)
FRESH AIR DUCT (FAD)
PRIMARY AIR DUCT (PAD)
FAN COIL UNIT (FCU)
CONDENSATE DRAIN PIPE (CDP)
FEED EXPANSION PIPE (F&E)
CHILLER WATER SUPPLY (CHWS)
CHILLER WATER RETURN (CHWR)
MAKE-UP WATER PIPE (MWP)
BLEED-OFF PIPE (BOP)
BALANCING PIPE (BLP)

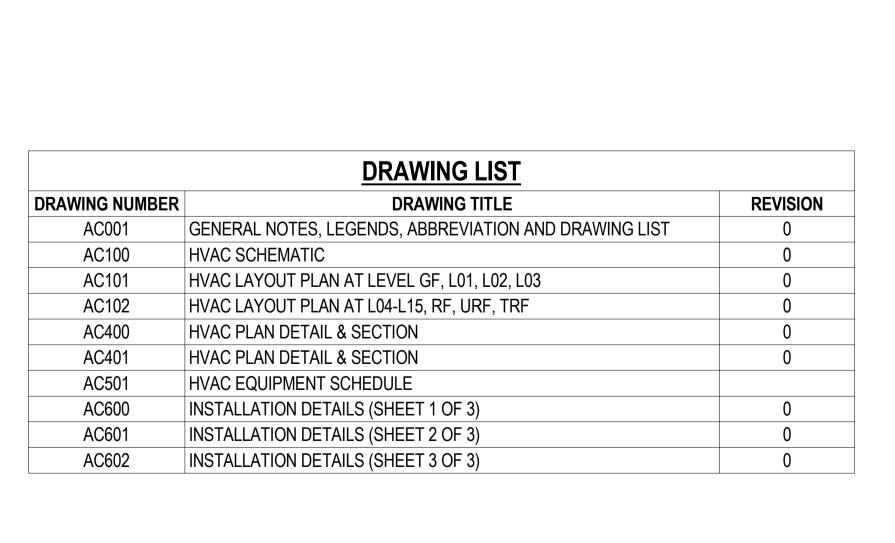

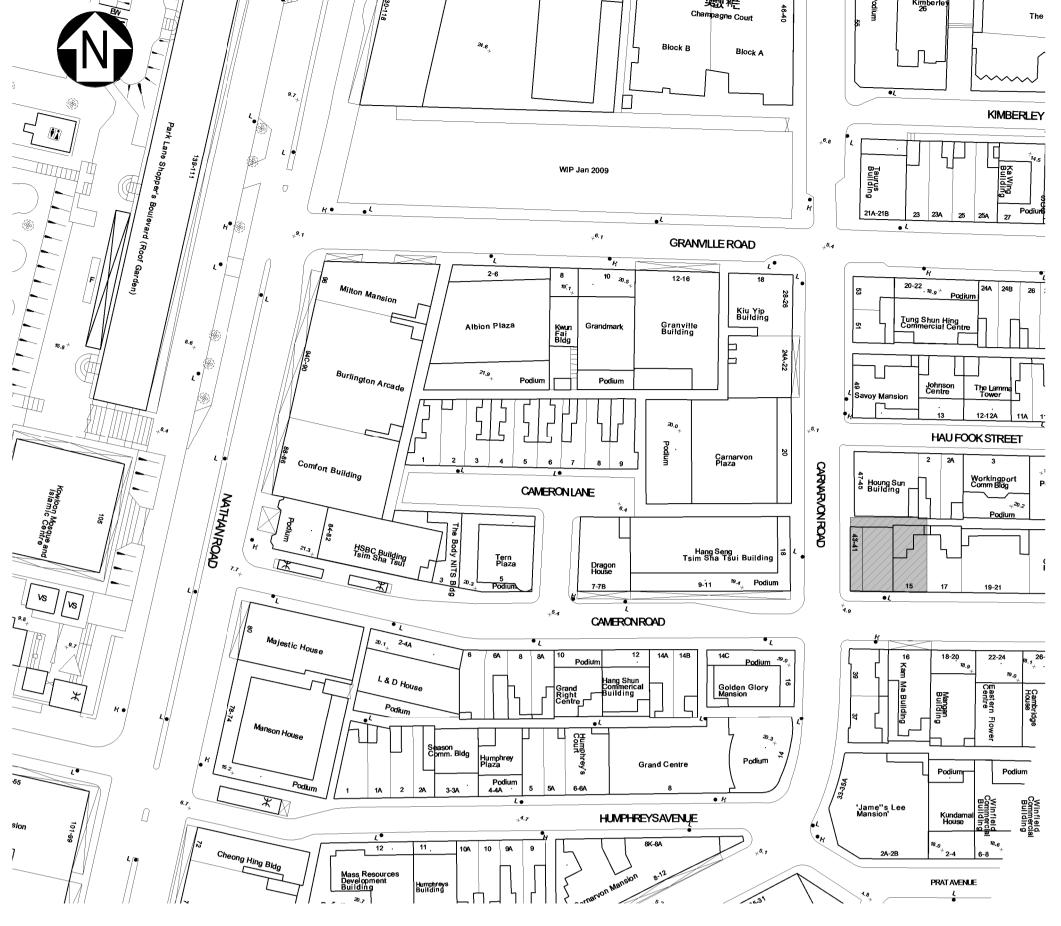

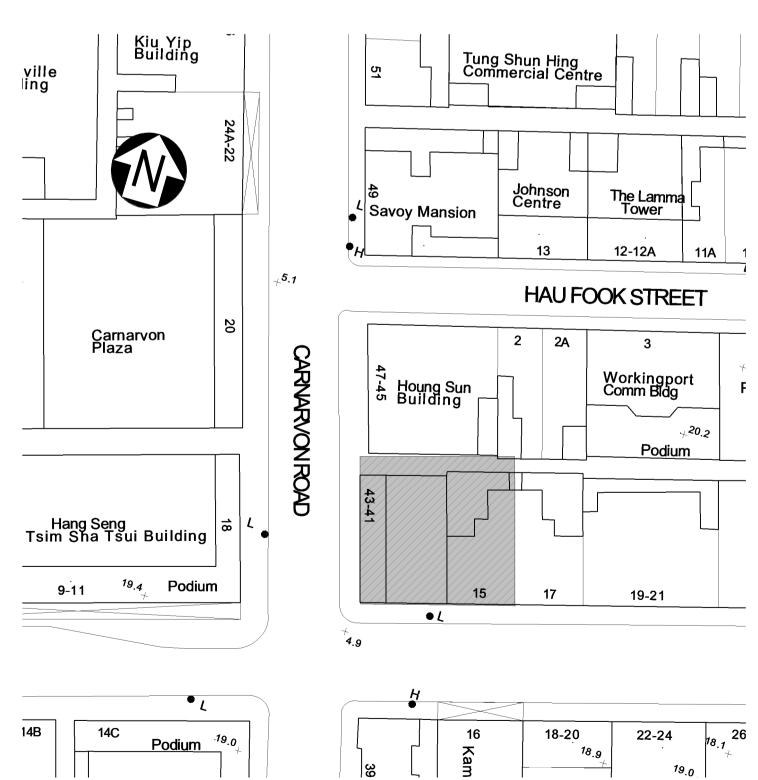

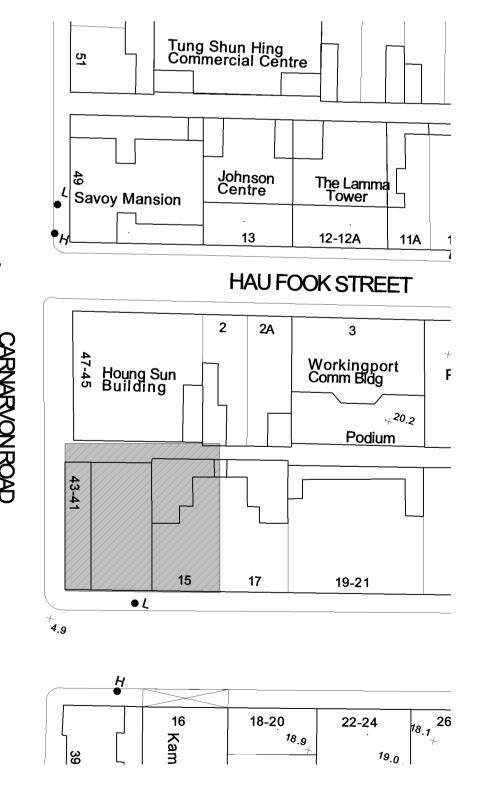

2 SITE PLAN 1:500

LOCATION PLAN

B.D.REFERENCE F.S.D.REFERENCE W.W.O.REFERENCE

DO NOT SCALE DRAWINGS. ALL DIMENSIONS SHALL BE VERIFIED ON SITE.

This is a simulated project aiming to include as many different MEP systems and provisions as possible within one sample building project so that MEP drawings can be produced to illustrate the various drawing requirements and techniques.

It shall be noted that professional MEP designs complying to prevailing regulations or design criteria are NOT the purpose of this drawing set and thus the provisions illustrated may appear to be over provided or unreasonably located. Please do not take the system designs as reference.

Blue colour stands for "Not directly generated by BIM system but by manual input"

QR Code on drawing is an innovative idea to bridge between 2D drawings and 3D BIM model/2D BIM presentations when a Cloud Platform such as CDE is available.





INDUSTRY COUNCIL 建造業議會

DO NOT SCALE DRAWINGS. ALL DIMENSIONS SHALL BE VERIFIED ON SITE APPOINTING PARTY / CLIENT REVIEW & ACCEPT T - ACCEPTED (TIME) A - REVIEWED & ACCEPTED B - REVIEWED & ACCEPTED WITH COMMENTS C - DO NOT USE

LEAD CONSULTANT / LEAD CONTRACTOR REVIEW & AUTHORISATION A - REVIEWED & AUTHORISED

B - REVIEWED & AUTHORISED WITH COMMENTS C - DO NOT USE DATE

08-03-2021 1ST SUBMISSION DATE DESCRIPTION NAME AND DESIGNATION DATE APPROVED DD/MM/YYYY APPROVER


CHECKED CHECKER DD/MM/YYYY DESIGNED DESIGNER DD/MM/YYYY DRAWN **BIM MODELLER** DD/MM/YYYY


CIC SAMPLE PROJECT

GENERAL NOTES, LEGENDS, ABBREVIATION AND DRAWING LIST

PURPOSE OF ISSUE
PLANNING SUBMISSION As indicated A1 DRAWING NO.

PXXXXX/AC001

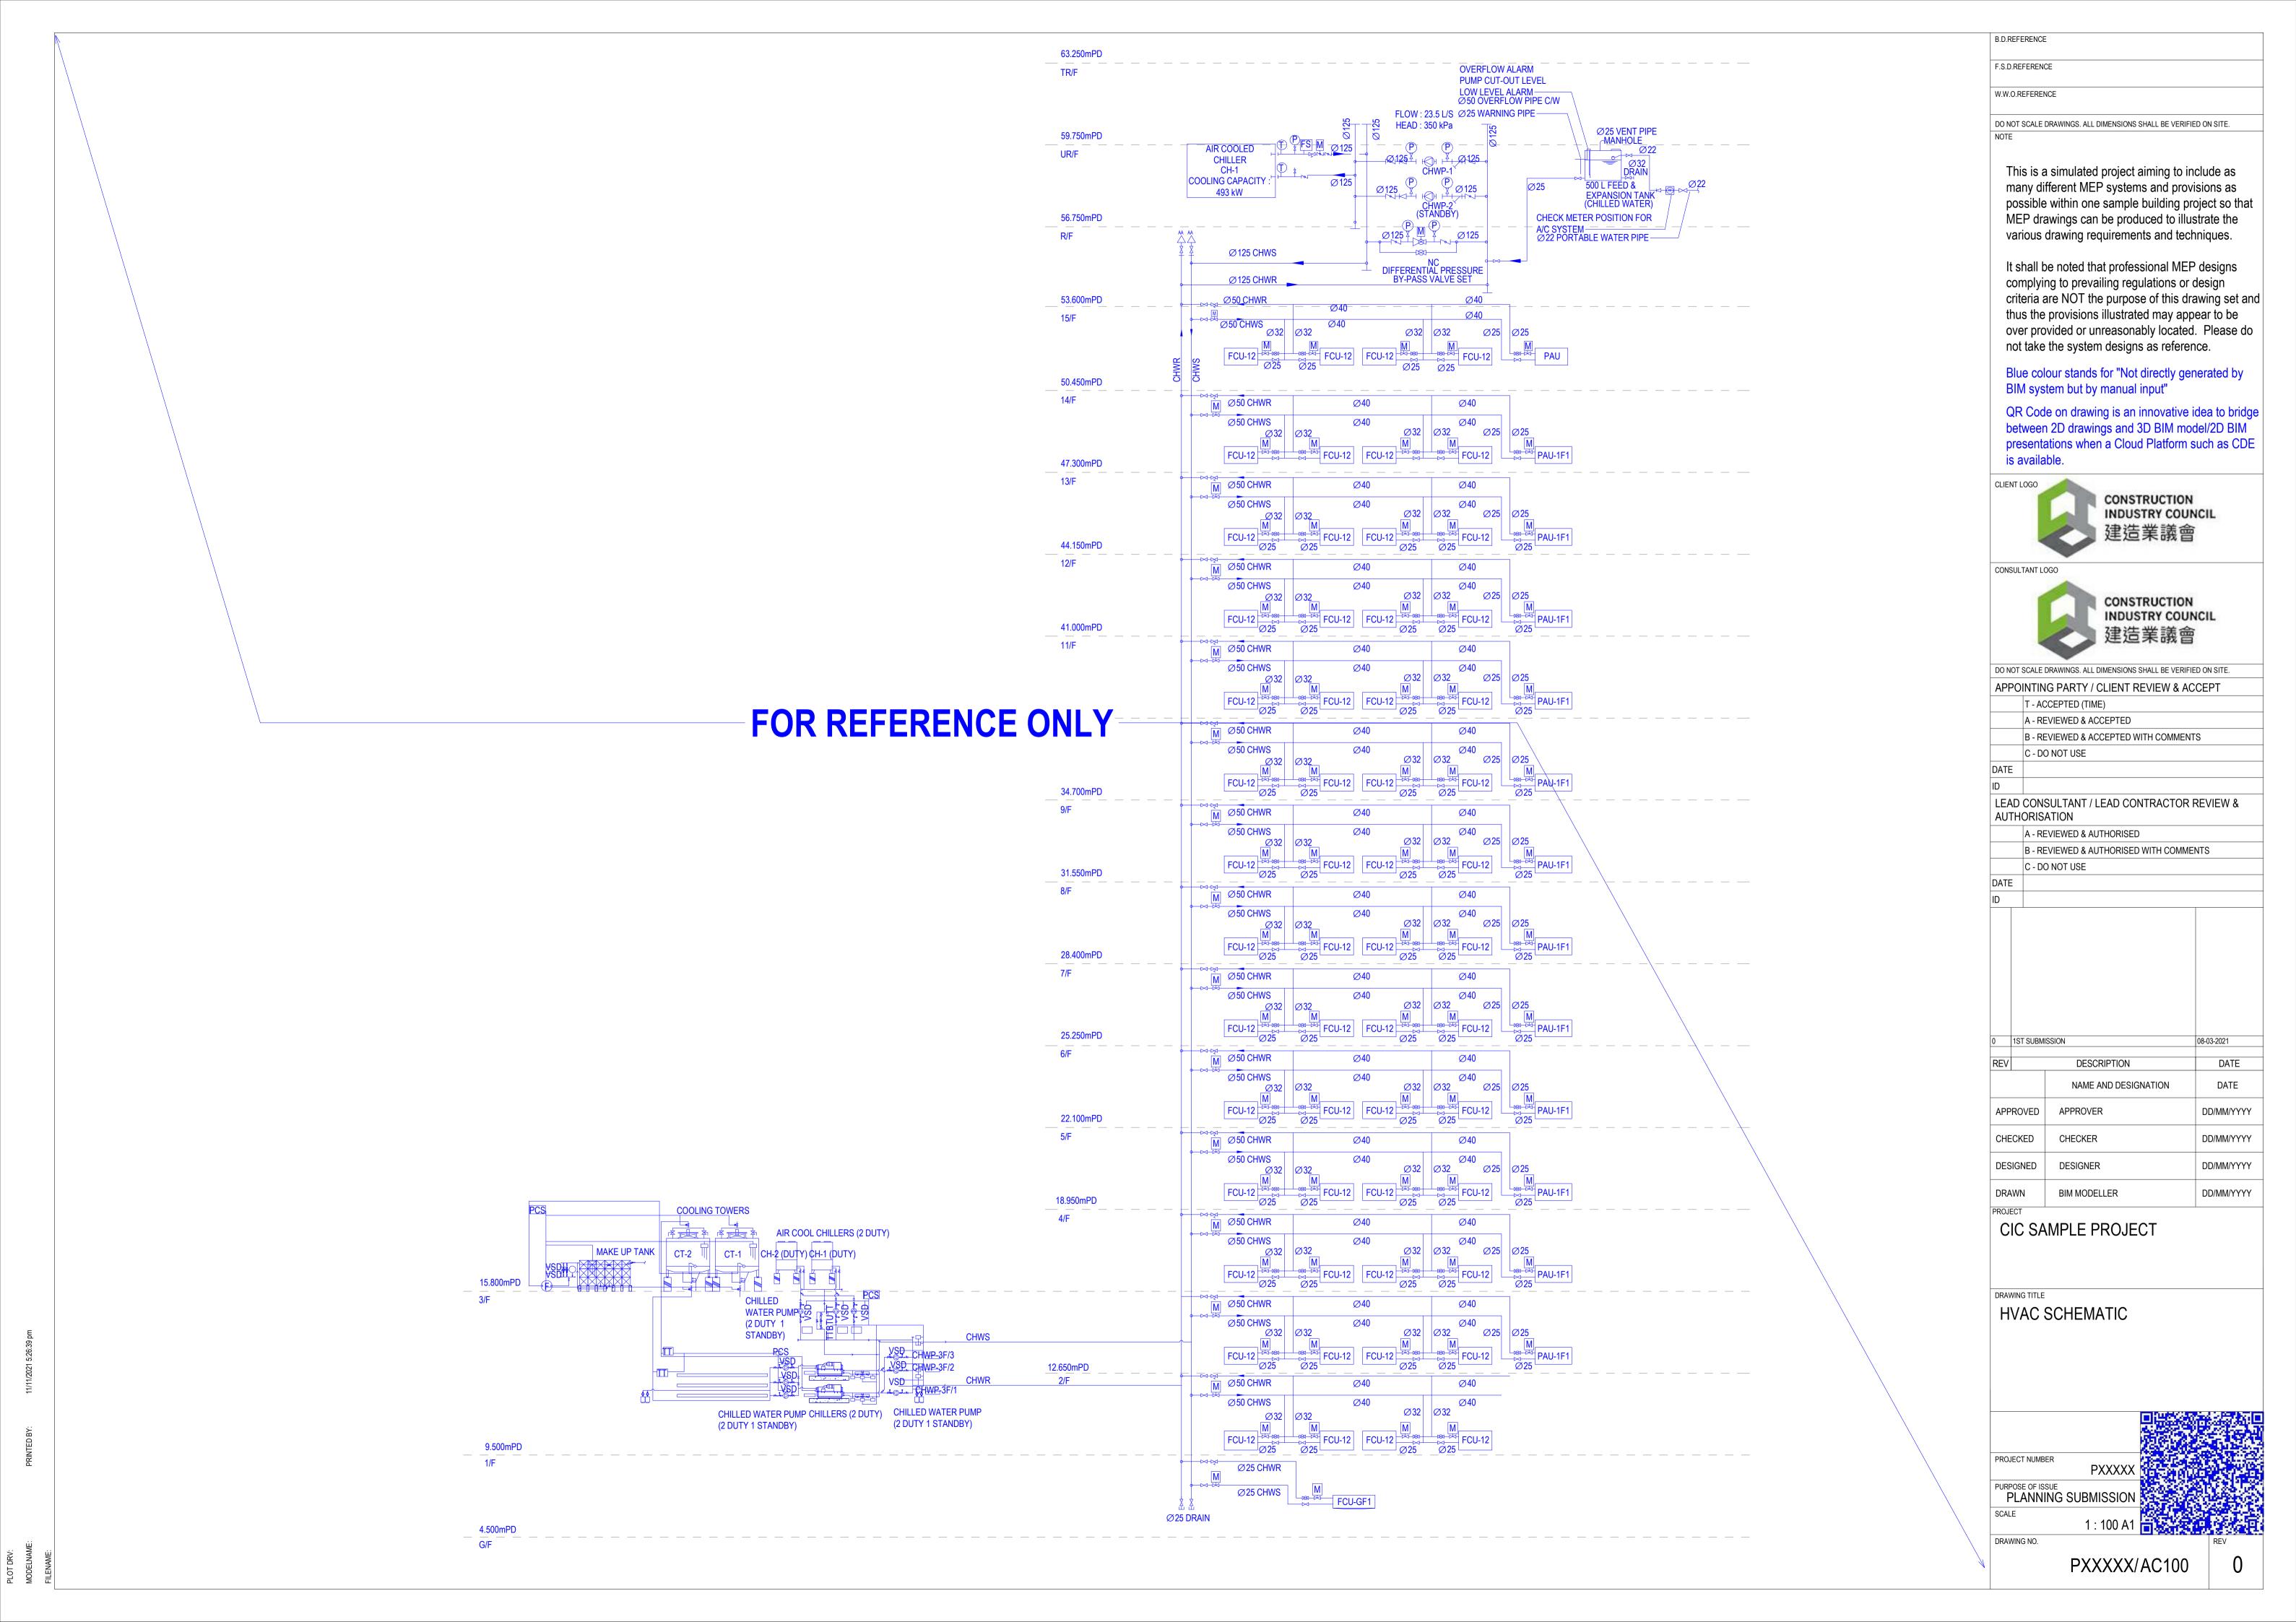

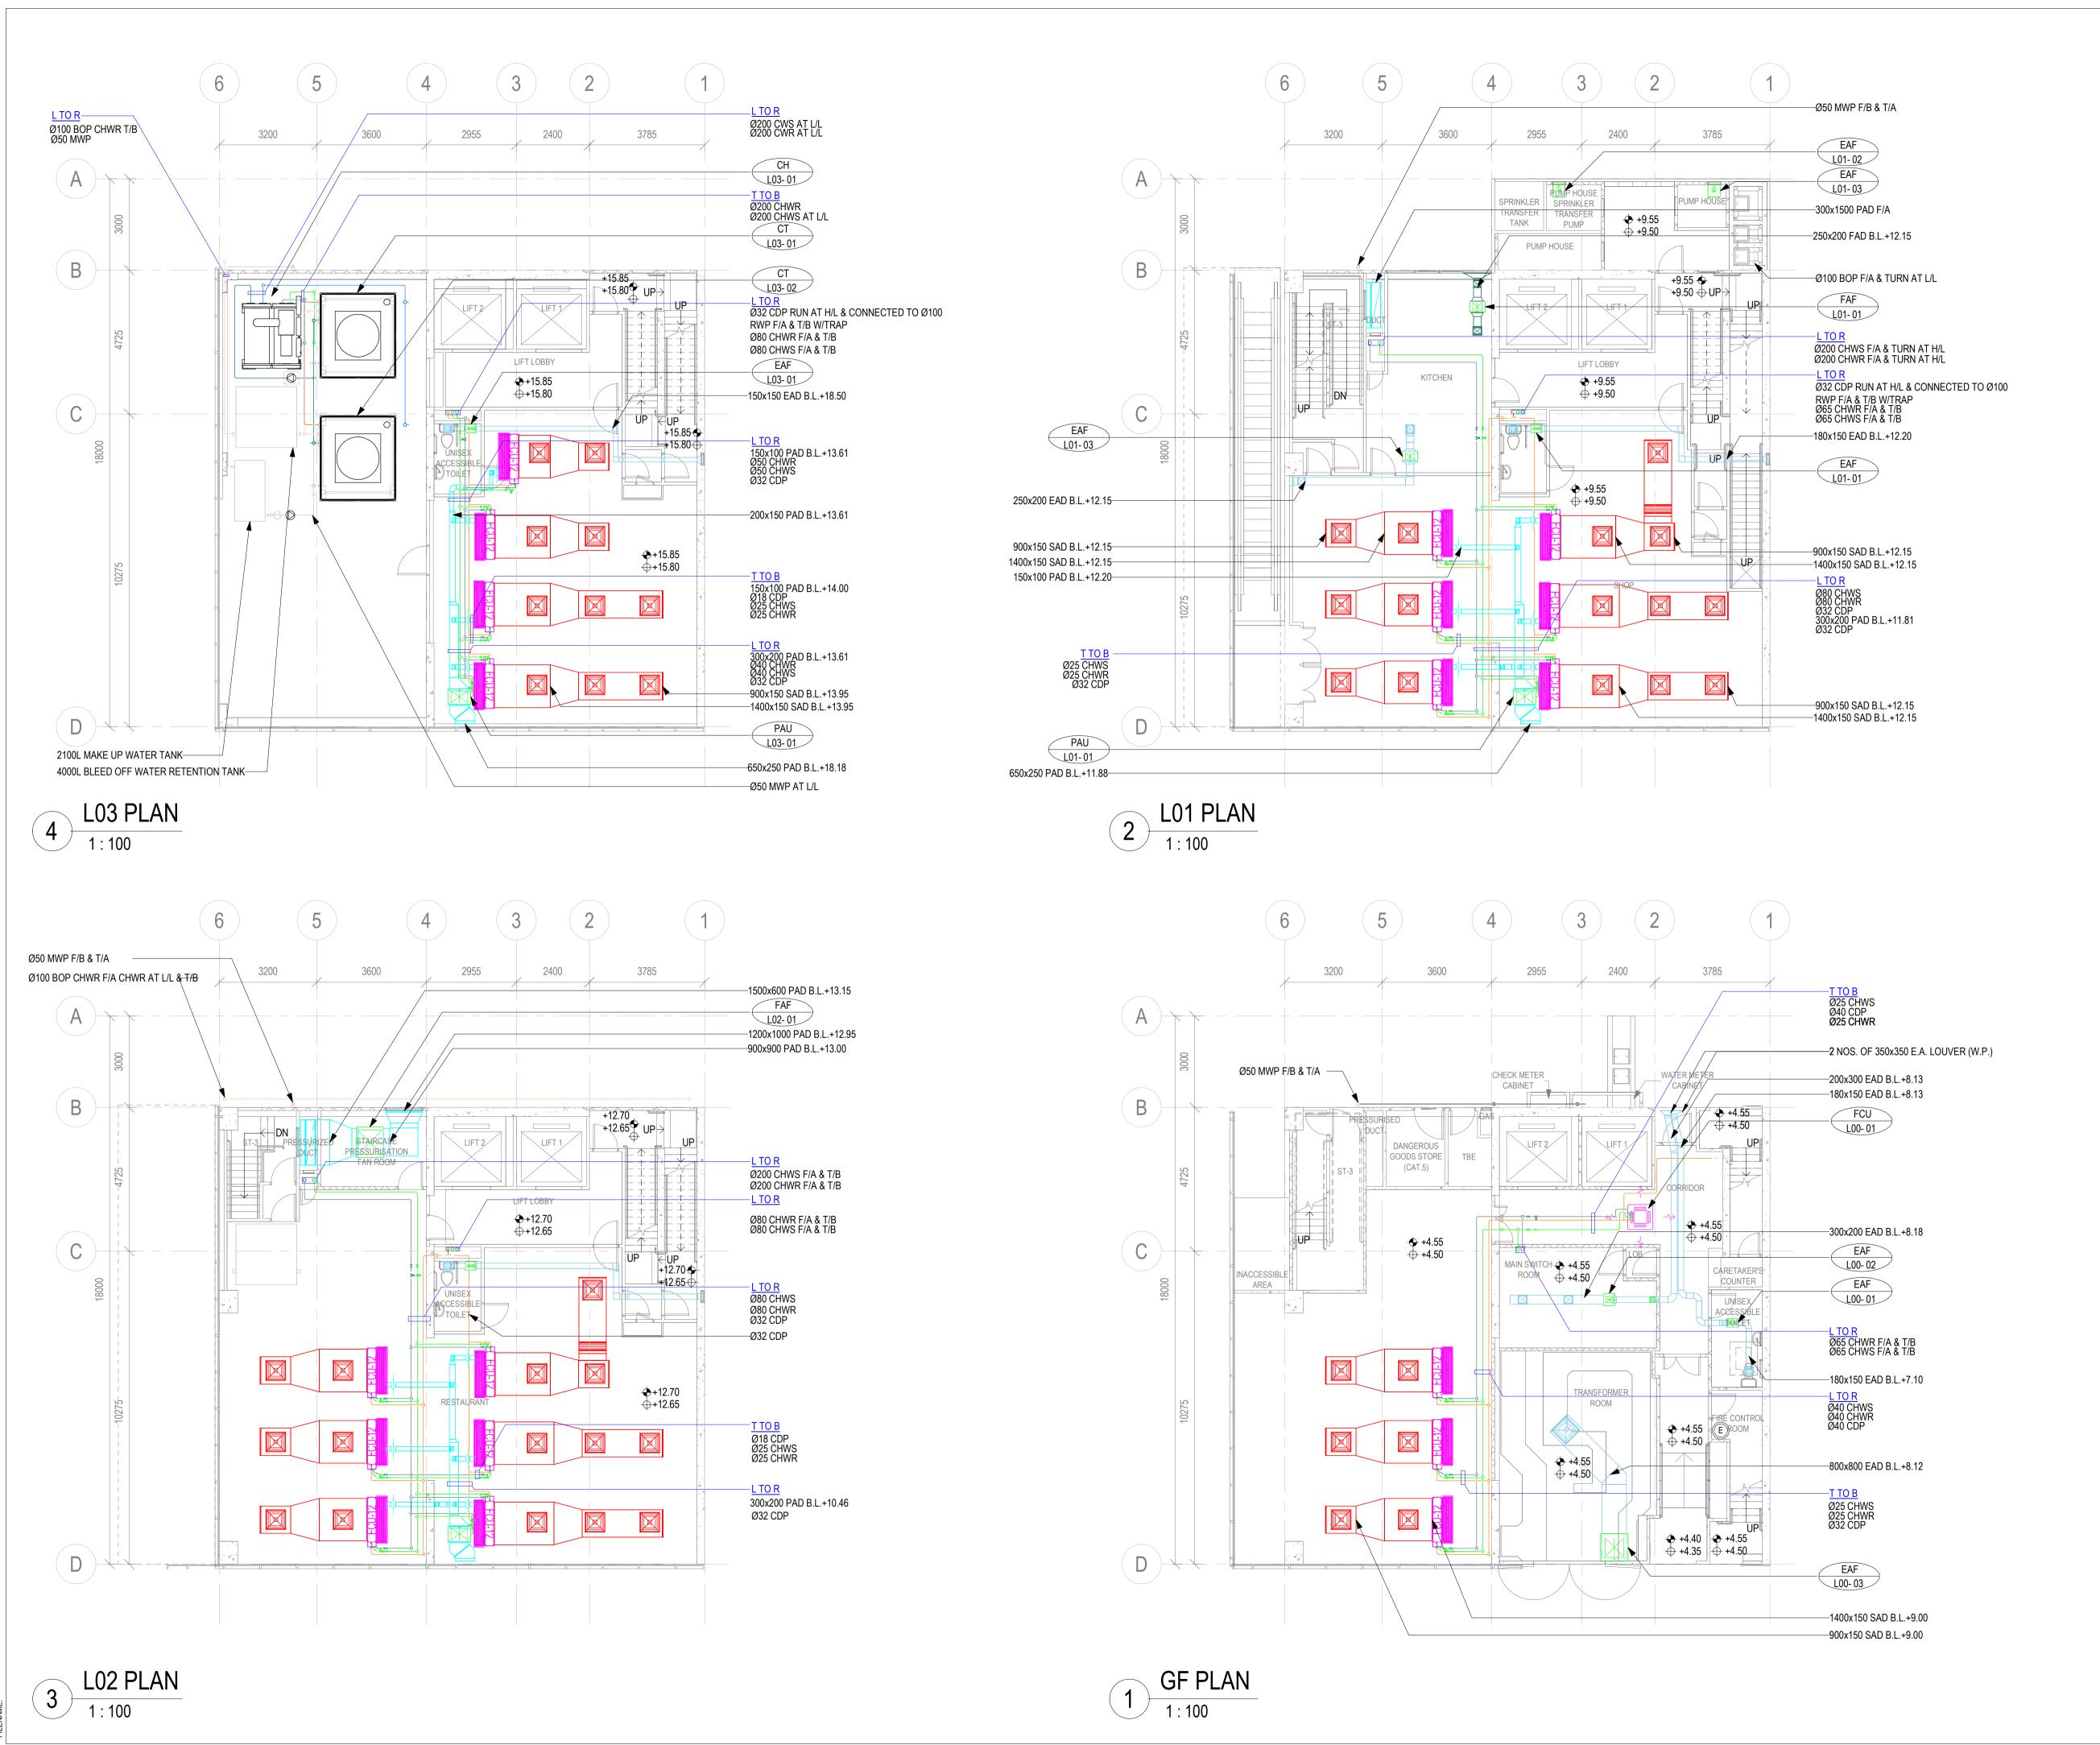

B.D.REFERENCE F.S.D.REFERENCE W.W.O.REFERENCE DO NOT SCALE DRAWINGS. ALL DIMENSIONS SHALL BE VERIFIED ON SITE. This is a simulated project aiming to include as many different MEP systems and provisions as possible within one sample building project so that MEP drawings can be produced to illustrate the various drawing requirements and techniques. It shall be noted that professional MEP designs complying to prevailing regulations or design criteria are NOT the purpose of this drawing set and thus the provisions illustrated may appear to be over provided or unreasonably located. Please do not take the system designs as reference. Blue colour stands for "Not directly generated by BIM system but by manual input" QR Code on drawing is an innovative idea to bridge between 2D drawings and 3D BIM model/2D BIM presentations when a Cloud Platform such as CDE is available. CLIENT LOGO CONSTRUCTION INDUSTRY COUNCIL

建造業議會 CONSULTANT LOGO

CONSTRUCTION INDUSTRY COUNCIL 建造業議會

DO NOT SCALE DRAWINGS. ALL DIMENSIONS SHALL BE VERIFIED ON SITE APPOINTING PARTY / CLIENT REVIEW & ACCEPT T - ACCEPTED (TIME)

A - REVIEWED & ACCEPTED B - REVIEWED & ACCEPTED WITH COMMENTS

LEAD CONSULTANT / LEAD CONTRACTOR REVIEW & AUTHORISATION

A - REVIEWED & AUTHORISED

B - REVIEWED & AUTHORISED WITH COMMENTS

C - DO NOT USE

C - DO NOT USE

DATE ID

1ST SUBMISSION 08-03-2021 DESCRIPTION DATE NAME AND DESIGNATION DATE

APPROVED DD/MM/YYYY APPROVER CHECKED DD/MM/YYYY CHECKER

DD/MM/YYYY

DD/MM/YYYY

DRAWN **BIM MODELLER**

CIC SAMPLE PROJECT

DESIGNER

DESIGNED


HVAC LAYOUT PLAN AT LEVEL GF. L01, L02, L03

PXXXXX PURPOSE OF ISSUE PLANNING SUBMISSION

DRAWING NO.

PXXXXX/AC101



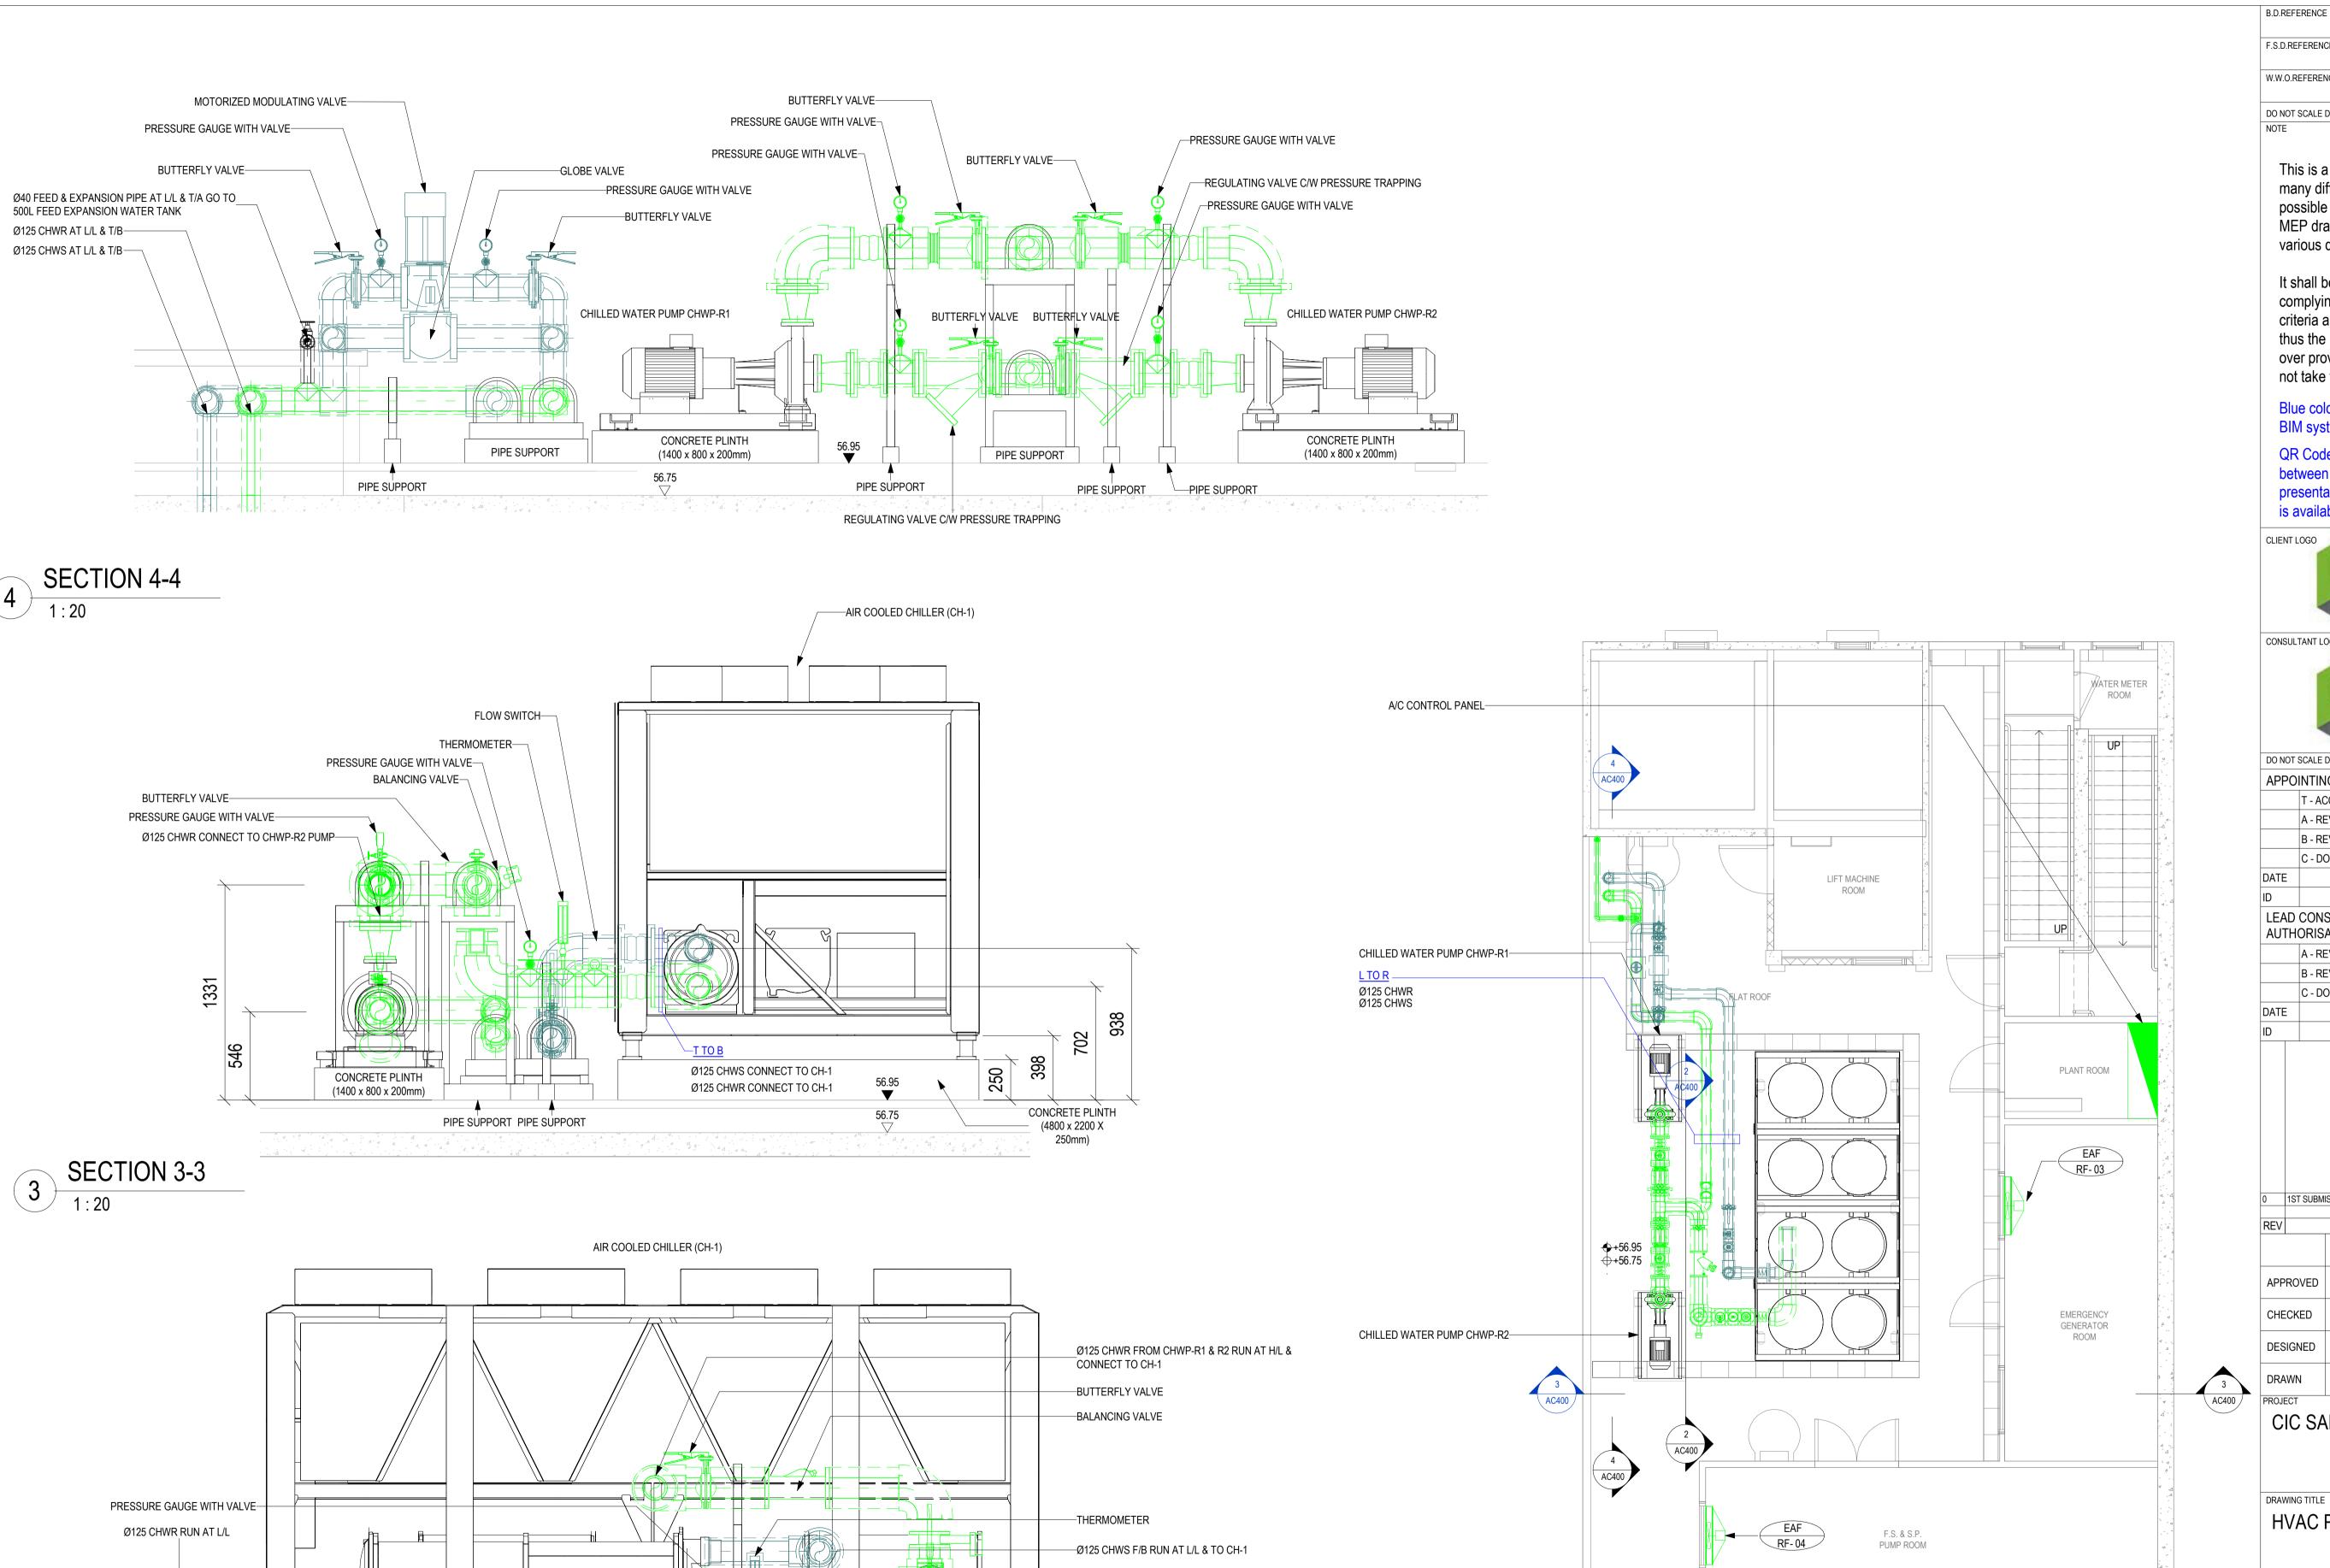

CONCRETE PLINTH (4800 x 2200 X

—PIPE SUPP∳RT

1 AIR CONDITIONING PLANT LAYOUT
1:50

F.S.D.REFERENCE W.W.O.REFERENCE DO NOT SCALE DRAWINGS. ALL DIMENSIONS SHALL BE VERIFIED ON SITE. This is a simulated project aiming to include as many different MEP systems and provisions as possible within one sample building project so that MEP drawings can be produced to illustrate the various drawing requirements and techniques. It shall be noted that professional MEP designs complying to prevailing regulations or design criteria are NOT the purpose of this drawing set and thus the provisions illustrated may appear to be over provided or unreasonably located. Please do not take the system designs as reference. Blue colour stands for "Not directly generated by BIM system but by manual input" QR Code on drawing is an innovative idea to bridge between 2D drawings and 3D BIM model/2D BIM presentations when a Cloud Platform such as CDE is available. CLIENT LOGO CONSTRUCTION INDUSTRY COUNCIL 建造業議會 CONSULTANT LOGO CONSTRUCTION INDUSTRY COUNCIL 建造業議會 DO NOT SCALE DRAWINGS. ALL DIMENSIONS SHALL BE VERIFIED ON SITE APPOINTING PARTY / CLIENT REVIEW & ACCEPT T - ACCEPTED (TIME) A - REVIEWED & ACCEPTED B - REVIEWED & ACCEPTED WITH COMMENTS C - DO NOT USE LEAD CONSULTANT / LEAD CONTRACTOR REVIEW & AUTHORISATION A - REVIEWED & AUTHORISED B - REVIEWED & AUTHORISED WITH COMMENTS C - DO NOT USE 08-03-2021 1ST SUBMISSION

DATE DESCRIPTION NAME AND DESIGNATION DATE DD/MM/YYYY APPROVED DD/MM/YYYY CHECKED DD/MM/YYYY DESIGNED DESIGNER DD/MM/YYYY

CIC SAMPLE PROJECT

HVAC PLAN DETAIL & SECTION

PURPOSE OF ISSUE PLANNING SUBMISSION DRAWING NO.

PXXXXX/AC400


Ø125 CHWS RUN AT L/L

PIPE SUPPORT →

PIPE SUPPORT—►

PIPE SUPPORT-►

☐ PIPE SUPPORT

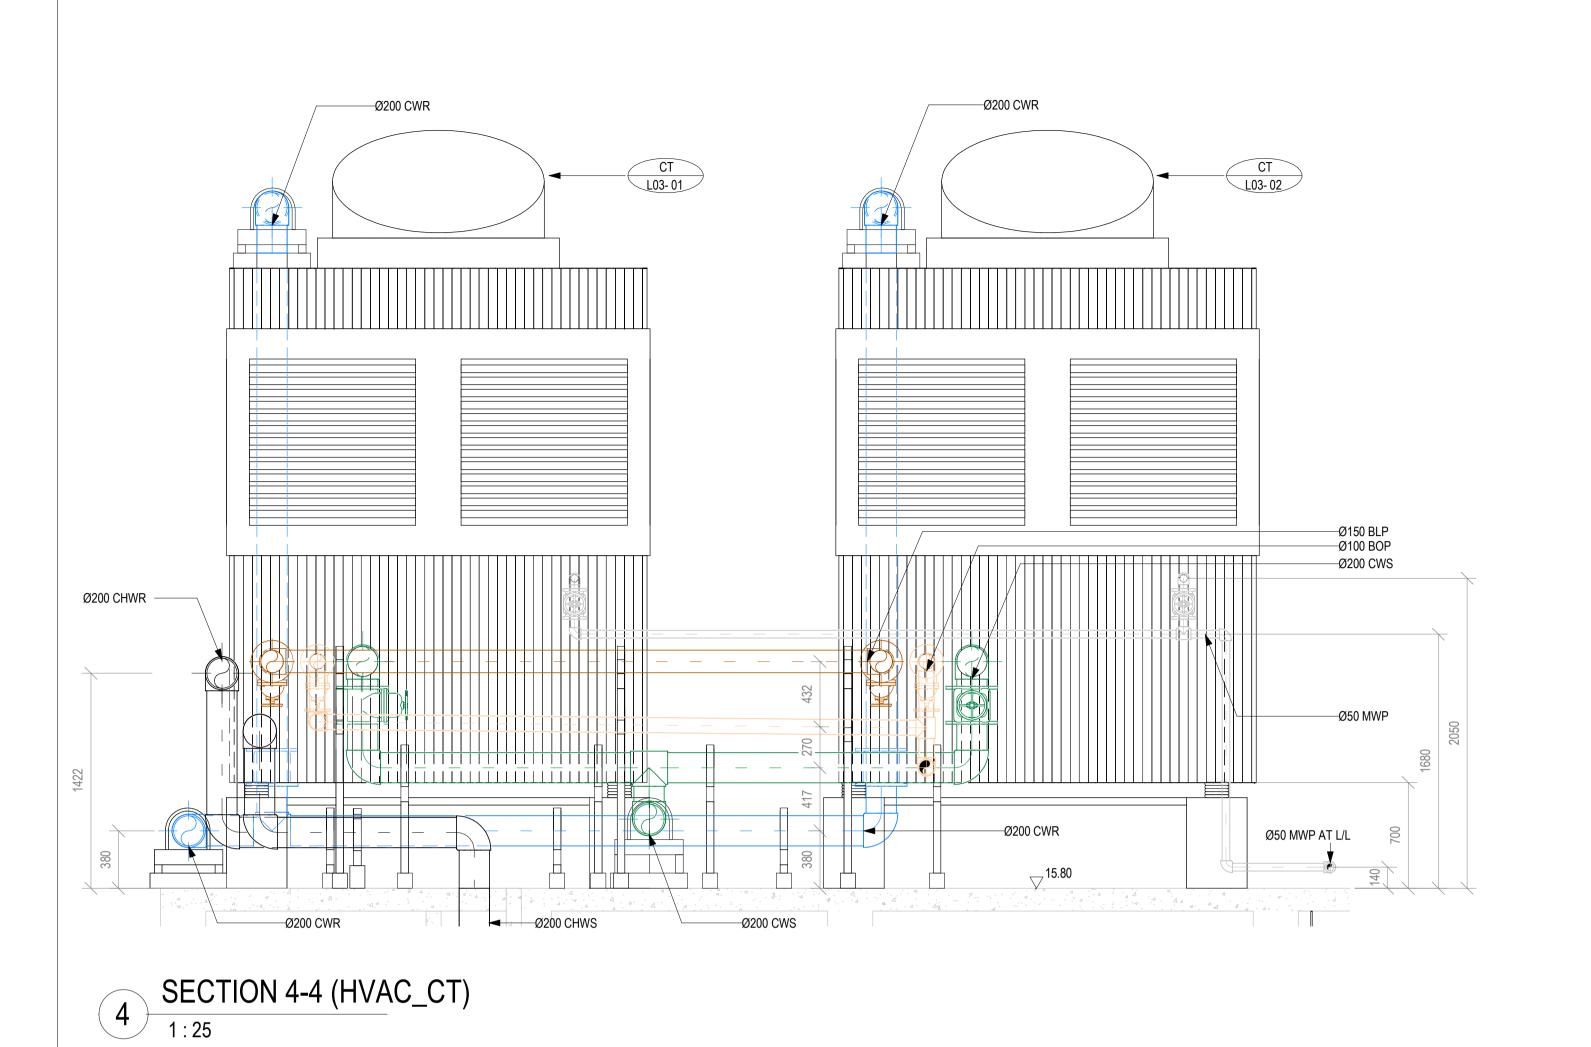

CH L03- 01

--Ø100 BOP

--Ø150 BLP

CONDENSING WATER PUMP

Ø200 CWS

Ø200 CHWS

Ø50 MWP TO MAKE UP WATER TANK-


Ø100 BOP CHWR AT L/L & T/B


-4000L BLEED OFF WATER RETENTION TANK

--Ø150 BLP


–Ø200 CHWR

2 SECTION 2-2 1:25

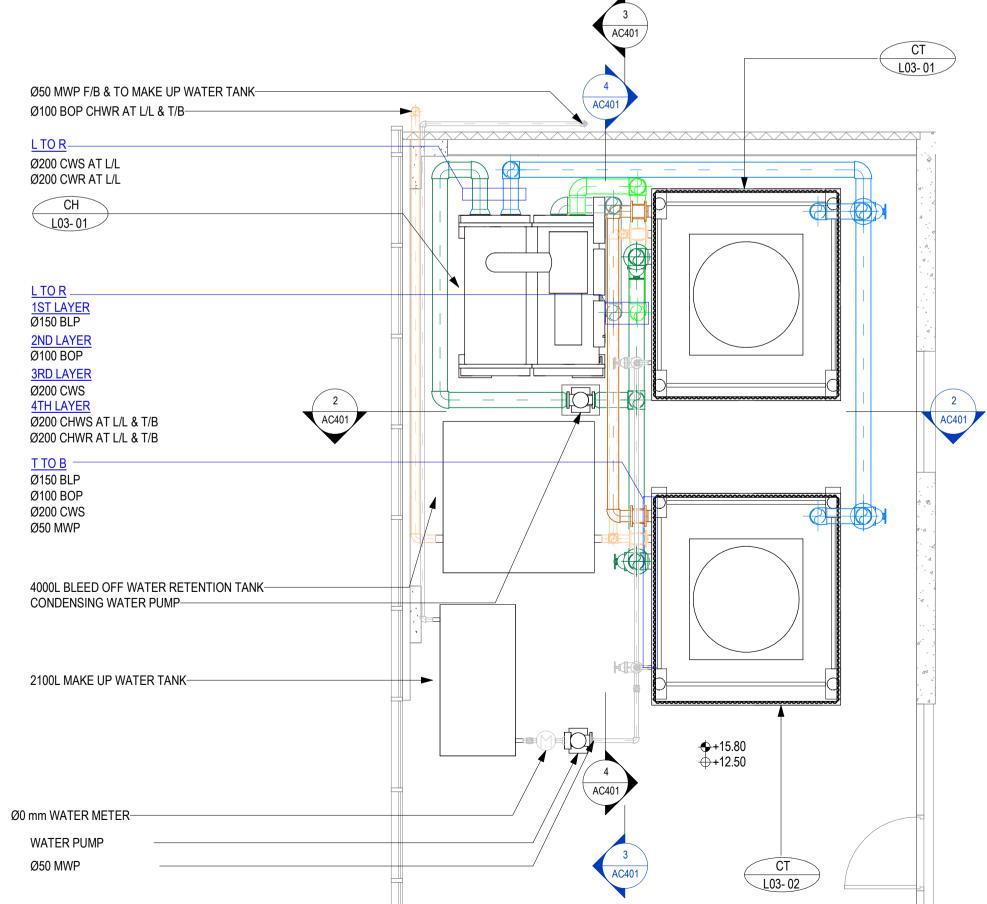

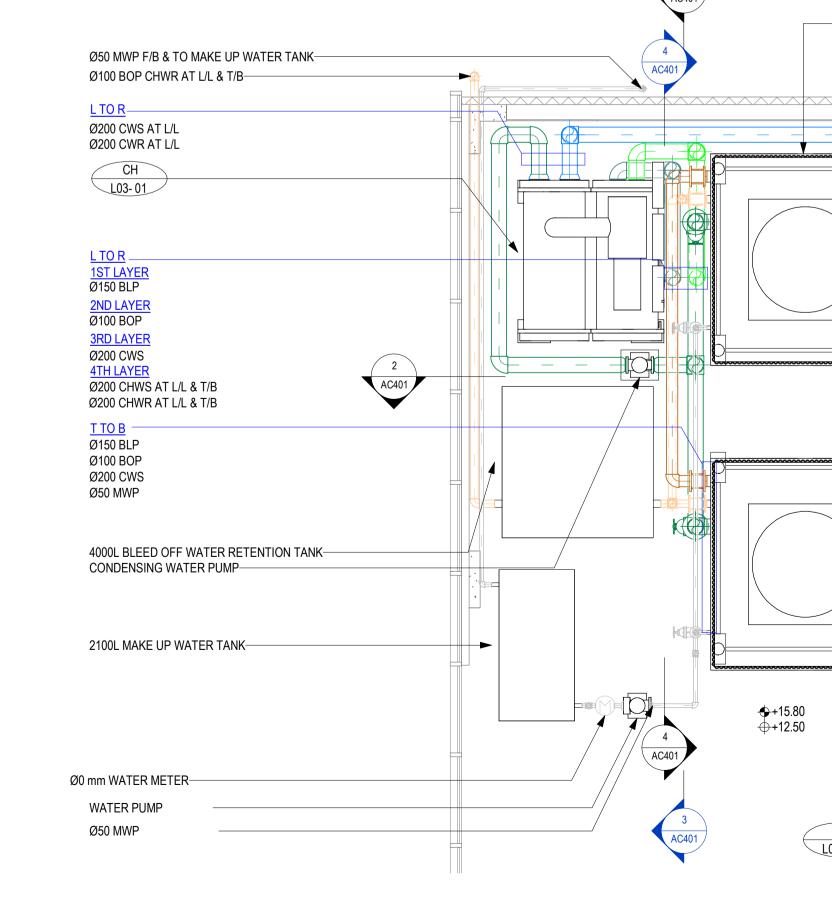

COOLING TOWER PART PLAN
1:50

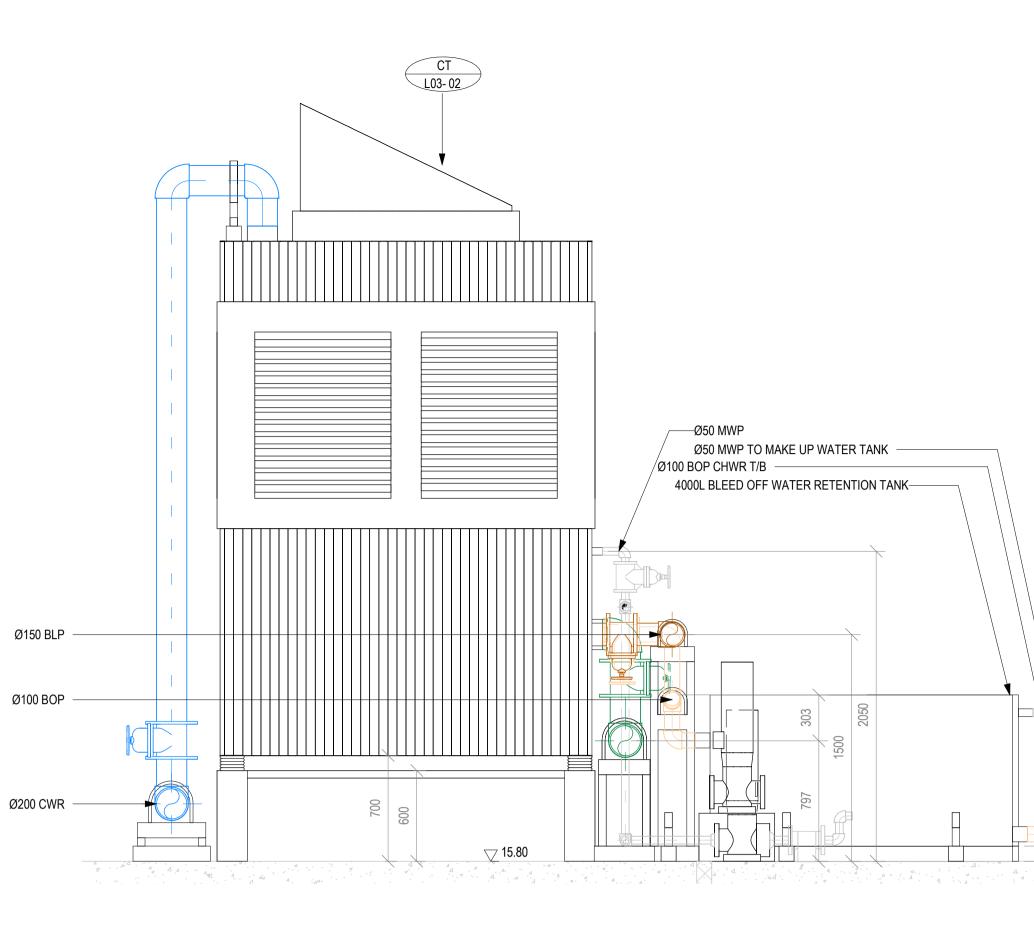

SECTION 3-3

-WATER PUMP

−Ø50 MWP AT L/L

—2100L MAKE UP WATER TANK

PXXXXX/AC401

B.D.REFERENCE

F.S.D.REFERENCE

W.W.O.REFERENCE

DO NOT SCALE DRAWINGS. ALL DIMENSIONS SHALL BE VERIFIED ON SITE.

This is a simulated project aiming to include as

many different MEP systems and provisions as possible within one sample building project so that MEP drawings can be produced to illustrate the various drawing requirements and techniques.

It shall be noted that professional MEP designs complying to prevailing regulations or design

not take the system designs as reference.

BIM system but by manual input"

is available.

CONSULTANT LOGO

Blue colour stands for "Not directly generated by

QR Code on drawing is an innovative idea to bridge

between 2D drawings and 3D BIM model/2D BIM

presentations when a Cloud Platform such as CDE

CONSTRUCTION INDUSTRY COUNCIL

建造業議會

CONSTRUCTION INDUSTRY COUNCIL

建造業議會

DO NOT SCALE DRAWINGS. ALL DIMENSIONS SHALL BE VERIFIED ON SITE. APPOINTING PARTY / CLIENT REVIEW & ACCEPT

B - REVIEWED & ACCEPTED WITH COMMENTS

LEAD CONSULTANT / LEAD CONTRACTOR REVIEW &

B - REVIEWED & AUTHORISED WITH COMMENTS

DESCRIPTION

NAME AND DESIGNATION

T - ACCEPTED (TIME)

C - DO NOT USE

C - DO NOT USE

AUTHORISATION

1ST SUBMISSION

APPROVED APPROVER

DESIGNED DESIGNER

CHECKER

BIM MODELLER

HVAC PLAN DETAIL & SECTION

PXXXXX

As indicated A1

PURPOSE OF ISSUE PLANNING SUBMISSION

DRAWING NO.

CIC SAMPLE PROJECT

CHECKED

DATE

A - REVIEWED & ACCEPTED

A - REVIEWED & AUTHORISED

criteria are NOT the purpose of this drawing set and thus the provisions illustrated may appear to be over provided or unreasonably located. Please do

08-03-2021

DATE

DATE

DD/MM/YYYY

DD/MM/YYYY

DD/MM/YYYY

DD/MM/YYYY

PRINTED BY:
PRIN

Formily Name COLL Tyres Level Count COLL Size CAD Size DAD Size Dan Size							n Size		
Family Name	FCU Type	Level	Count	FCU Size	SAD Size	RAD Size	CHWR	CHWS	CDP
MCQ-FCU-CIC-FCU	FCU-12	G/F +4.50	3	1470 X 281 X 223	1400 X 150	1400 X 150	25 mm	25 mm	32 mm
MCQ-FCU-CIC-FCU	FCU-12	1/F +9.50	6	1470 X 281 X 223	1400 X 150	1400 X 150	25 mm	25 mm	32 mm
MCQ-FCU-CIC-FCU	FCU-12	2/F +12.65	6	1470 X 281 X 223	1400 X 150	1400 X 150	25 mm	25 mm	32 mn
MCQ-FCU-CIC-FCU	FCU-12	3/F +15.80	4	1470 X 281 X 223	1400 X 150	1400 X 150	25 mm	25 mm	32 mn
MCQ-FCU-CIC-FCU	FCU-12	4/F +18.95	4	1470 X 281 X 223	1400 X 150	1400 X 150	25 mm	25 mm	32 mn
MCQ-FCU-CIC-FCU	FCU-12	5/F +22.10	4	1470 X 281 X 223	1400 X 150	1400 X 150	25 mm	25 mm	32 mn
MCQ-FCU-CIC-FCU	FCU-12	6/F +25.25	4	1470 X 281 X 223	1400 X 150	1400 X 150	25 mm	25 mm	32 mn
MCQ-FCU-CIC-FCU	FCU-12	7/F +28.40	4	1470 X 281 X 223	1400 X 150	1400 X 150	25 mm	25 mm	32 mn
MCQ-FCU-CIC-FCU	FCU-12	8/F +31.55	4	1470 X 281 X 223	1400 X 150	1400 X 150	25 mm	25 mm	32 mn
MCQ-FCU-CIC-FCU	FCU-12	9/F +34.70	4	1470 X 281 X 223	1400 X 150	1400 X 150	25 mm	25 mm	32 mn
MCQ-FCU-CIC-FCU	FCU-12	10/F +37.85	4	1470 X 281 X 223	1400 X 150	1400 X 150	25 mm	25 mm	32 mr
MCQ-FCU-CIC-FCU	FCU-12	11/F +41.00	4	1470 X 281 X 223	1400 X 150	1400 X 150	25 mm	25 mm	32 mr
MCQ-FCU-CIC-FCU	FCU-12	12/F +44.15	4	1470 X 281 X 223	1400 X 150	1400 X 150	25 mm	25 mm	32 mn
MCQ-FCU-CIC-FCU	FCU-12	13/F +47.30	4	1470 X 281 X 223	1400 X 150	1400 X 150	25 mm	25 mm	32 mr
MCQ-FCU-CIC-FCU	FCU-12	14/F +50.45	4	1470 X 281 X 223	1400 X 150	1400 X 150	25 mm	25 mm	32 mr
MCQ-FCU-CIC-FCU	FCU-12	15/F +53.60	4	1470 X 281 X 223	1400 X 150	1400 X 150	25 mm	25 mm	32 mr
//CQ-OTR-CIC-FCU_RECT	FCU-GF1	G/F +4.50	1	825 X 825 X 298	01	01	25 mm	25 mm	40 mn

B.D.REFERENCE F.S.D.REFERENCE

W.W.O.REFERENCE

DO NOT SCALE DRAWINGS. ALL DIMENSIONS SHALL BE VERIFIED ON SITE.

This is a simulated project aiming to include as many different MEP systems and provisions as possible within one sample building project so that MEP drawings can be produced to illustrate the various drawing requirements and techniques.

It shall be noted that professional MEP designs complying to prevailing regulations or design criteria are NOT the purpose of this drawing set and thus the provisions illustrated may appear to be over provided or unreasonably located. Please do not take the system designs as reference.

Blue colour stands for "Not directly generated by BIM system but by manual input"

QR Code on drawing is an innovative idea to bridge between 2D drawings and 3D BIM model/2D BIM presentations when a Cloud Platform such as CDE is available.



CONSULTANT LOGO



DO NOT SCALE DRAWINGS. ALL DIMENSIONS SHALL BE VERIFIED ON SITE.

APPOINTING PARTY / CLIENT REVIEW & ACCEPT			
T - ACCEPTED (TIME)			
A - REVIEWED & ACCEPTED			
B - REVIEWED & ACCEPTED WITH COMMENTS			
O DO NOT HOE			

C - DO NOT USE

LEAD CONSULTANT / LEAD CONTRACTOR REVIEW & AUTHORISATION

	A - REVIEWED & AUTHORISED
	B - REVIEWED & AUTHORISED WITH COMMENTS
	C - DO NOT USE


REV		DESCRIPTION	DATE
		NAME AND DESIGNATION	DATE
APPR	OVED	Approver	
CHEC	CKED	Checker	
DESIG	SNED	Designer	

CIC SAMPLE PROJECT

HVAC EQUIPMENT SCHEDULE


ROJECT NUMBER	PXXXXX	
URPOSE OF ISSUE		
CALE	A1	
RAWING NO		REV


PXXXXX/AC501

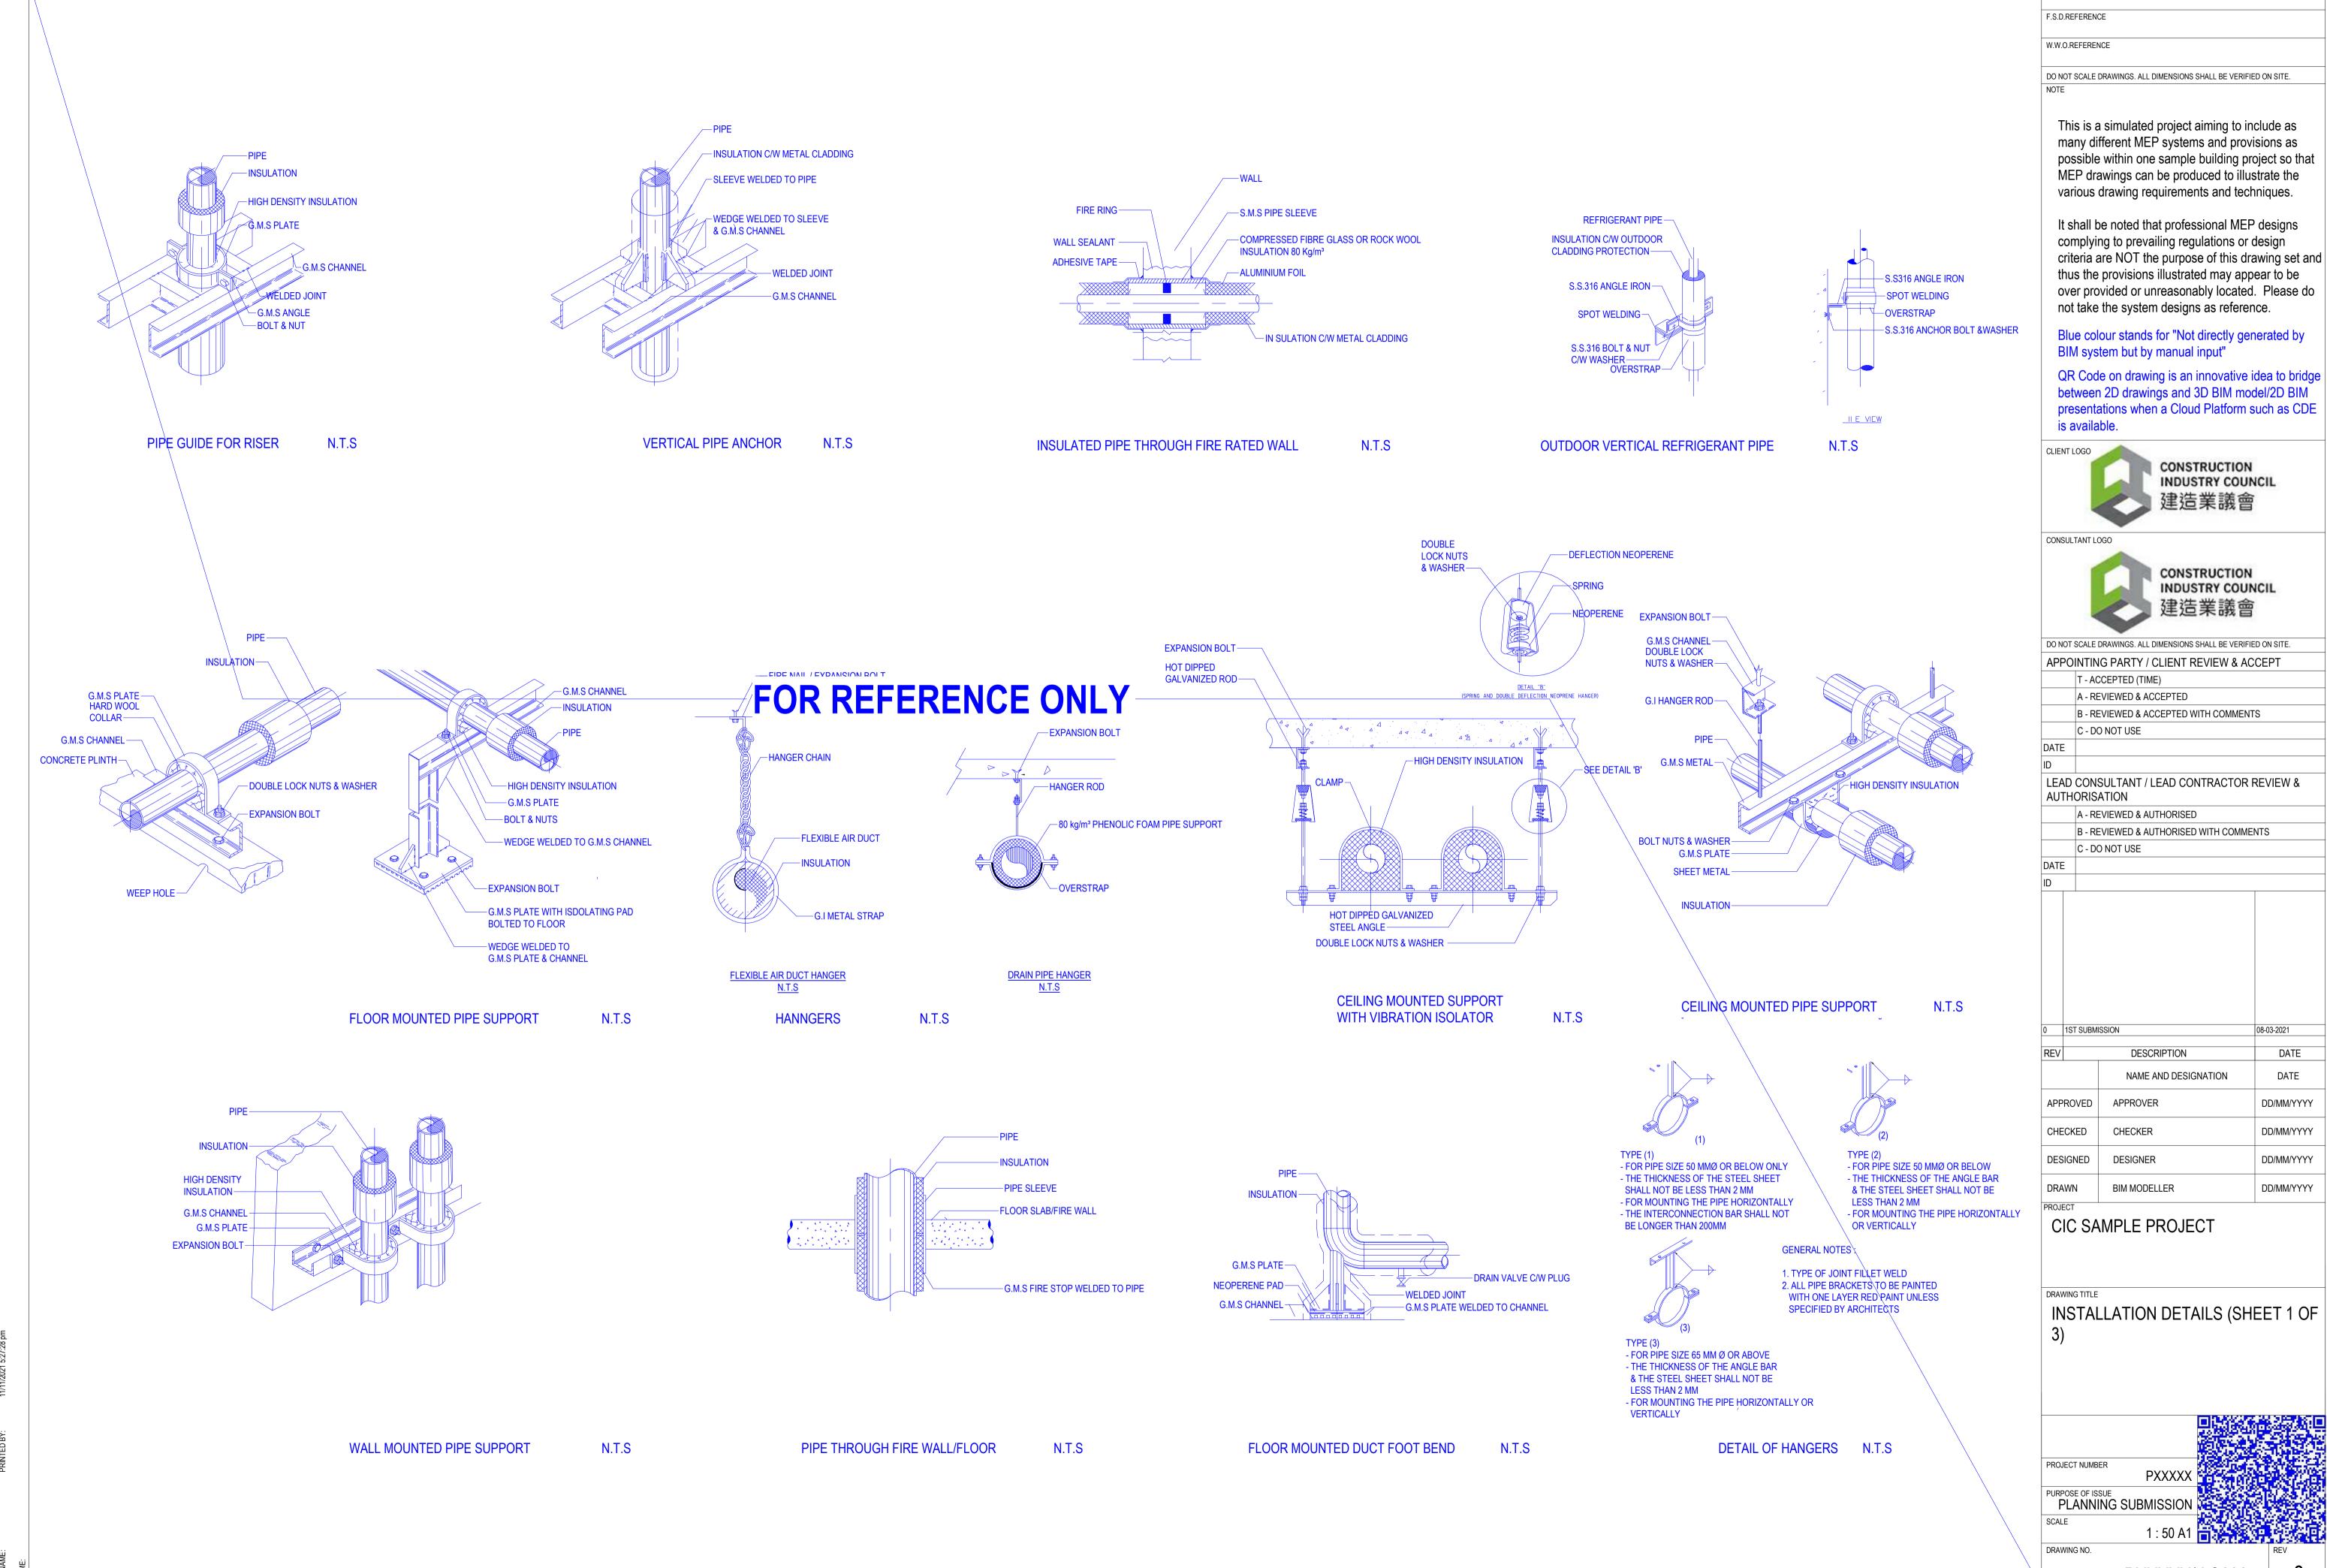


B.D.REFERENCE

PXXXXX/AC600

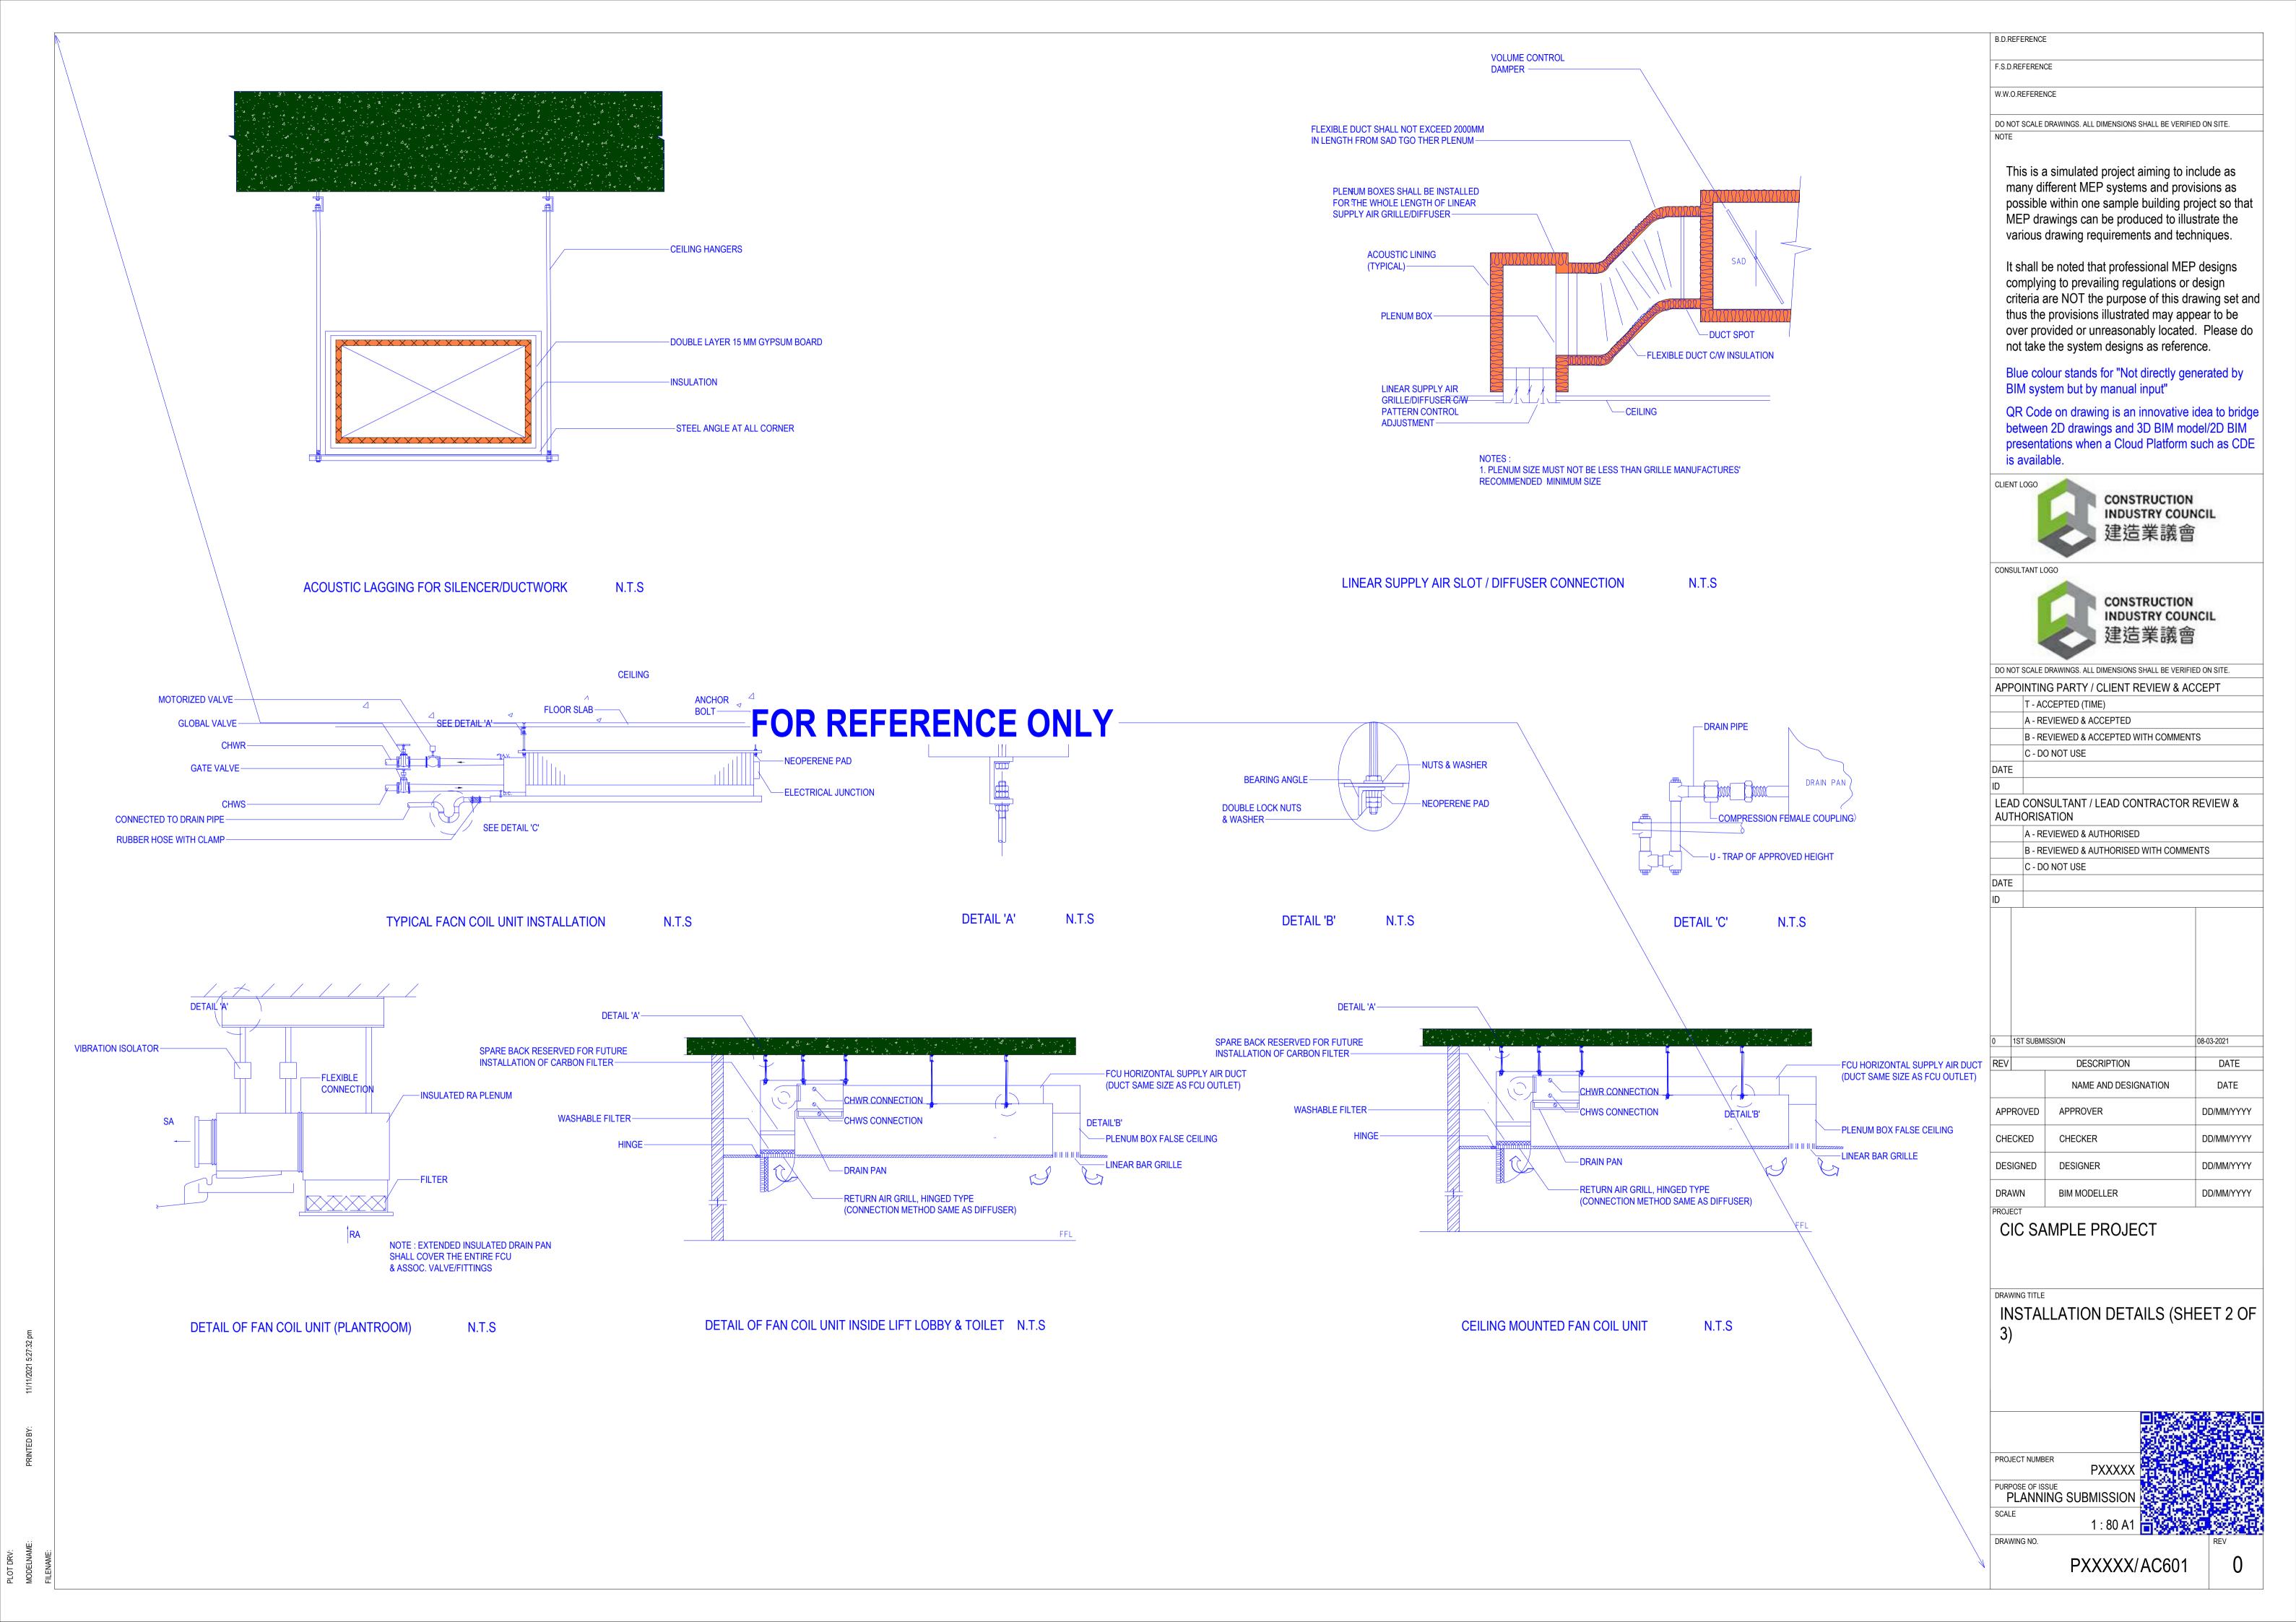

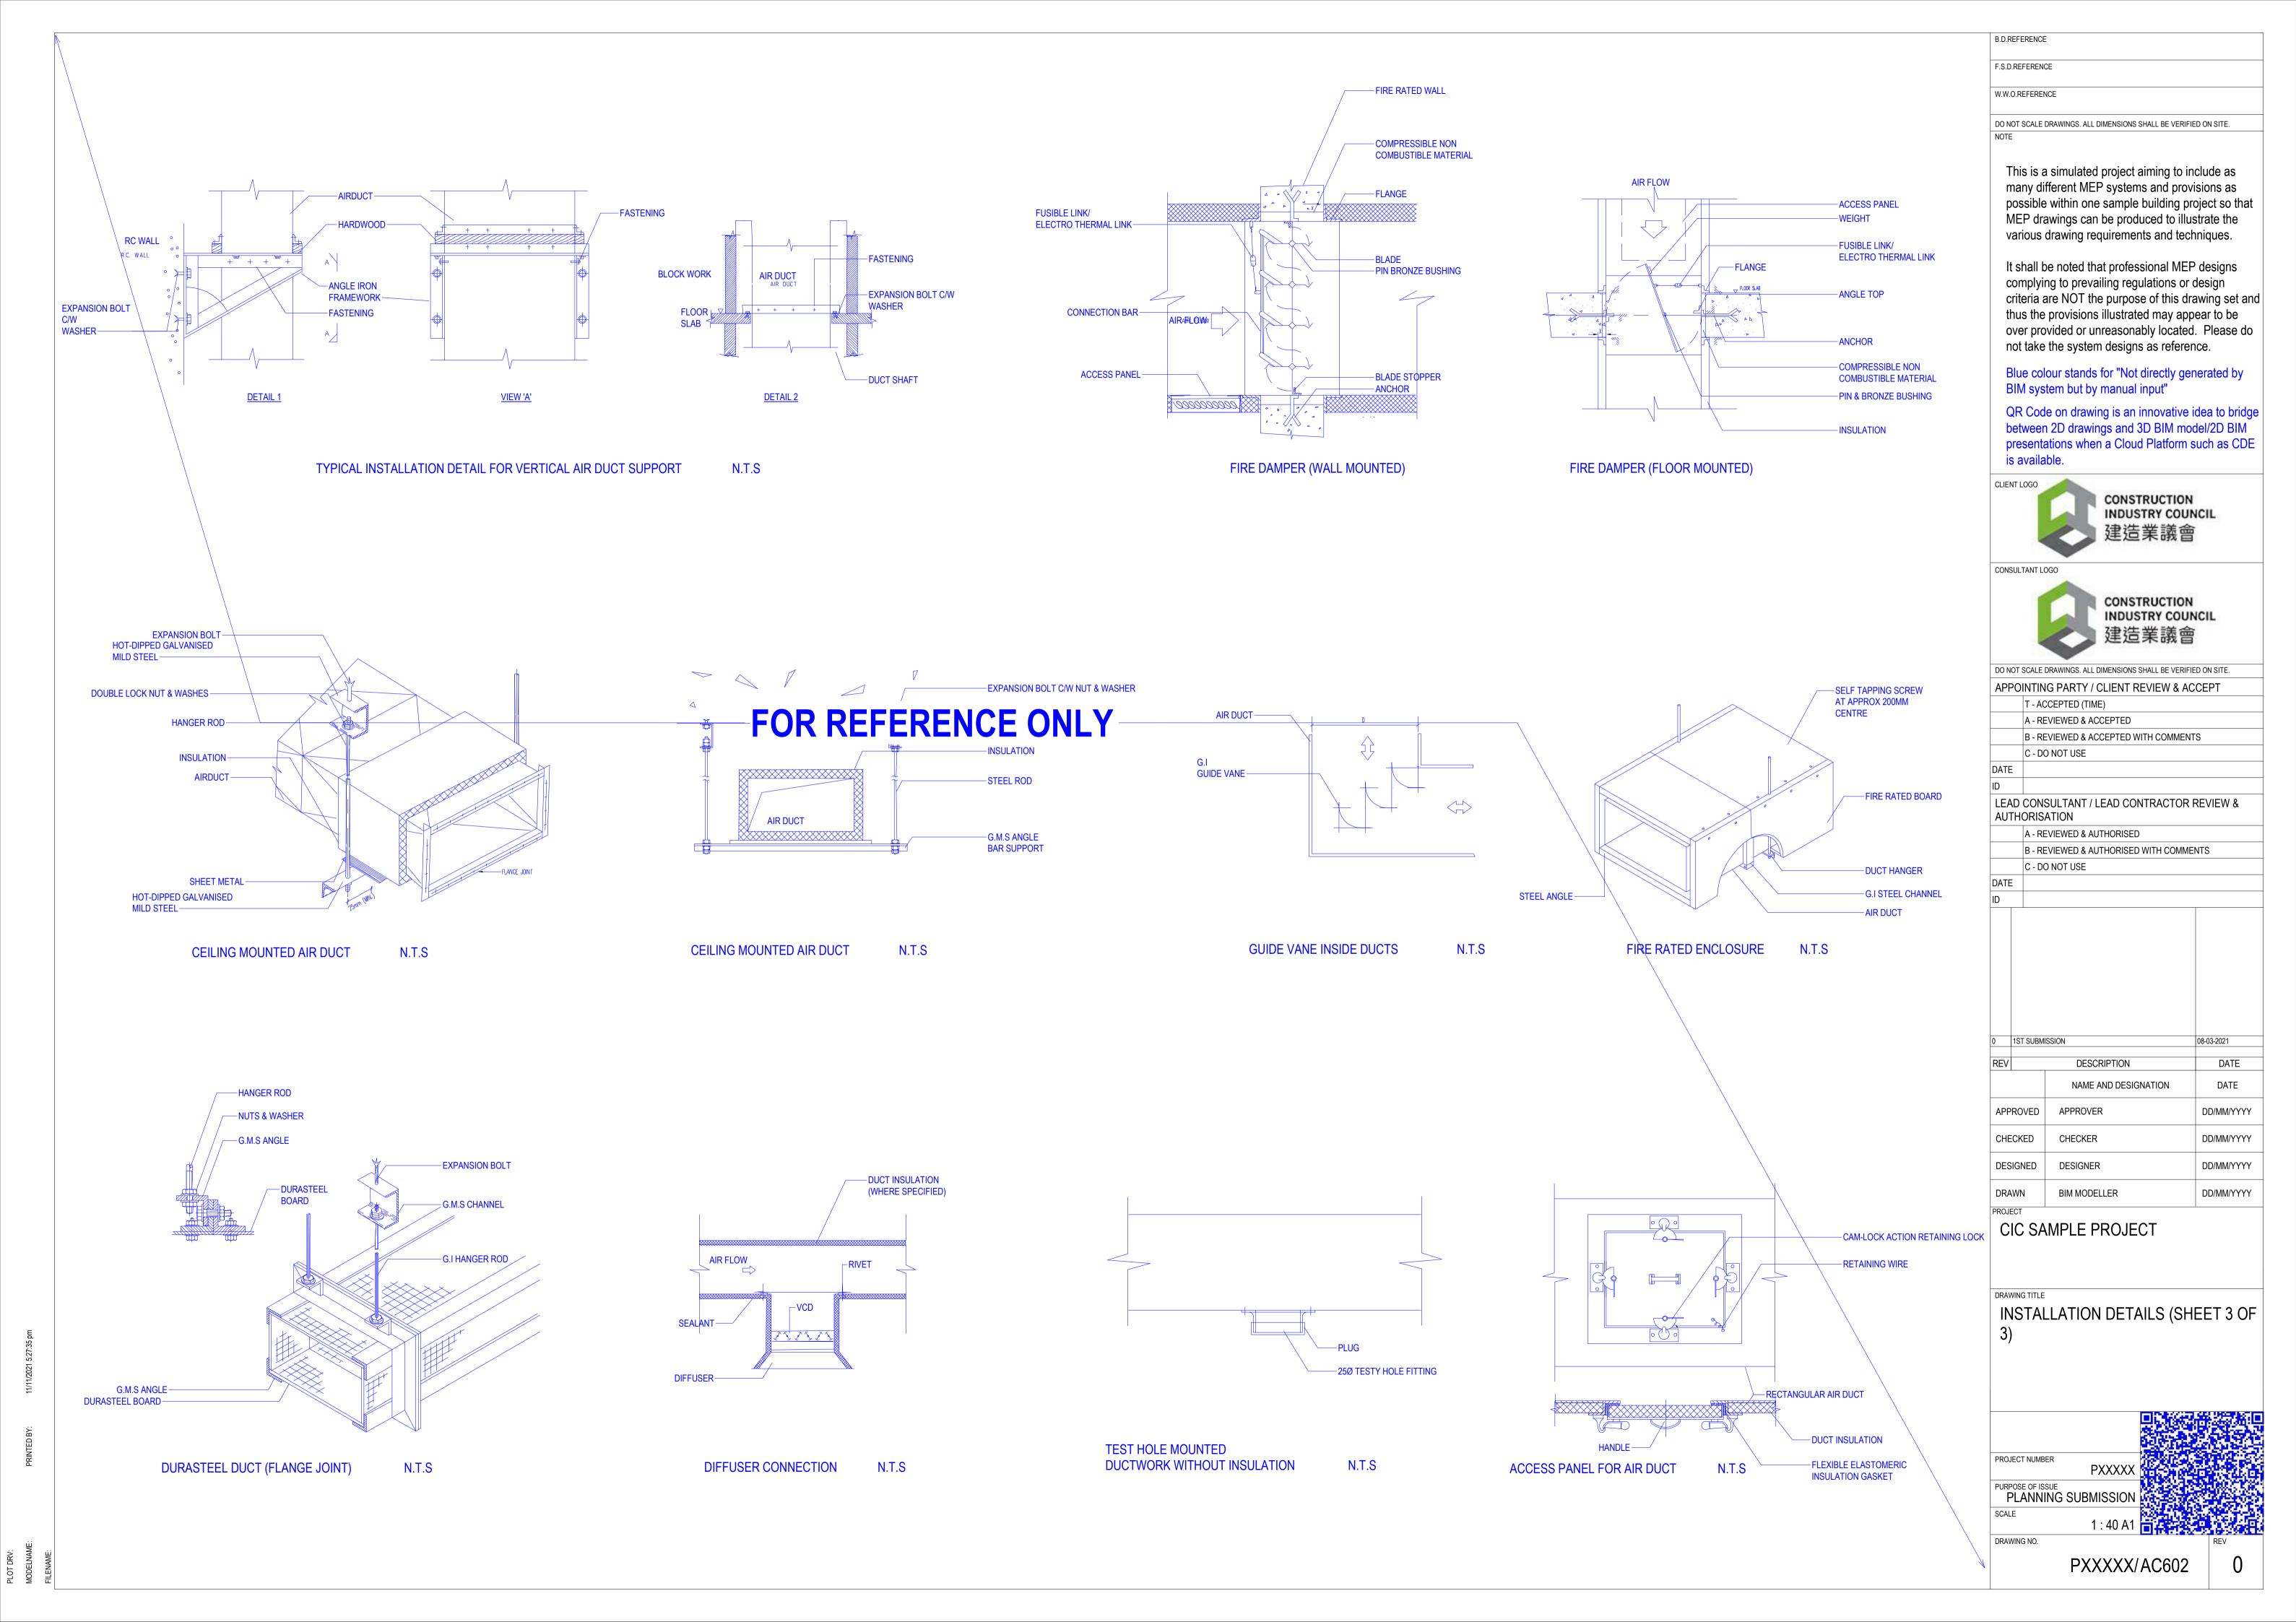

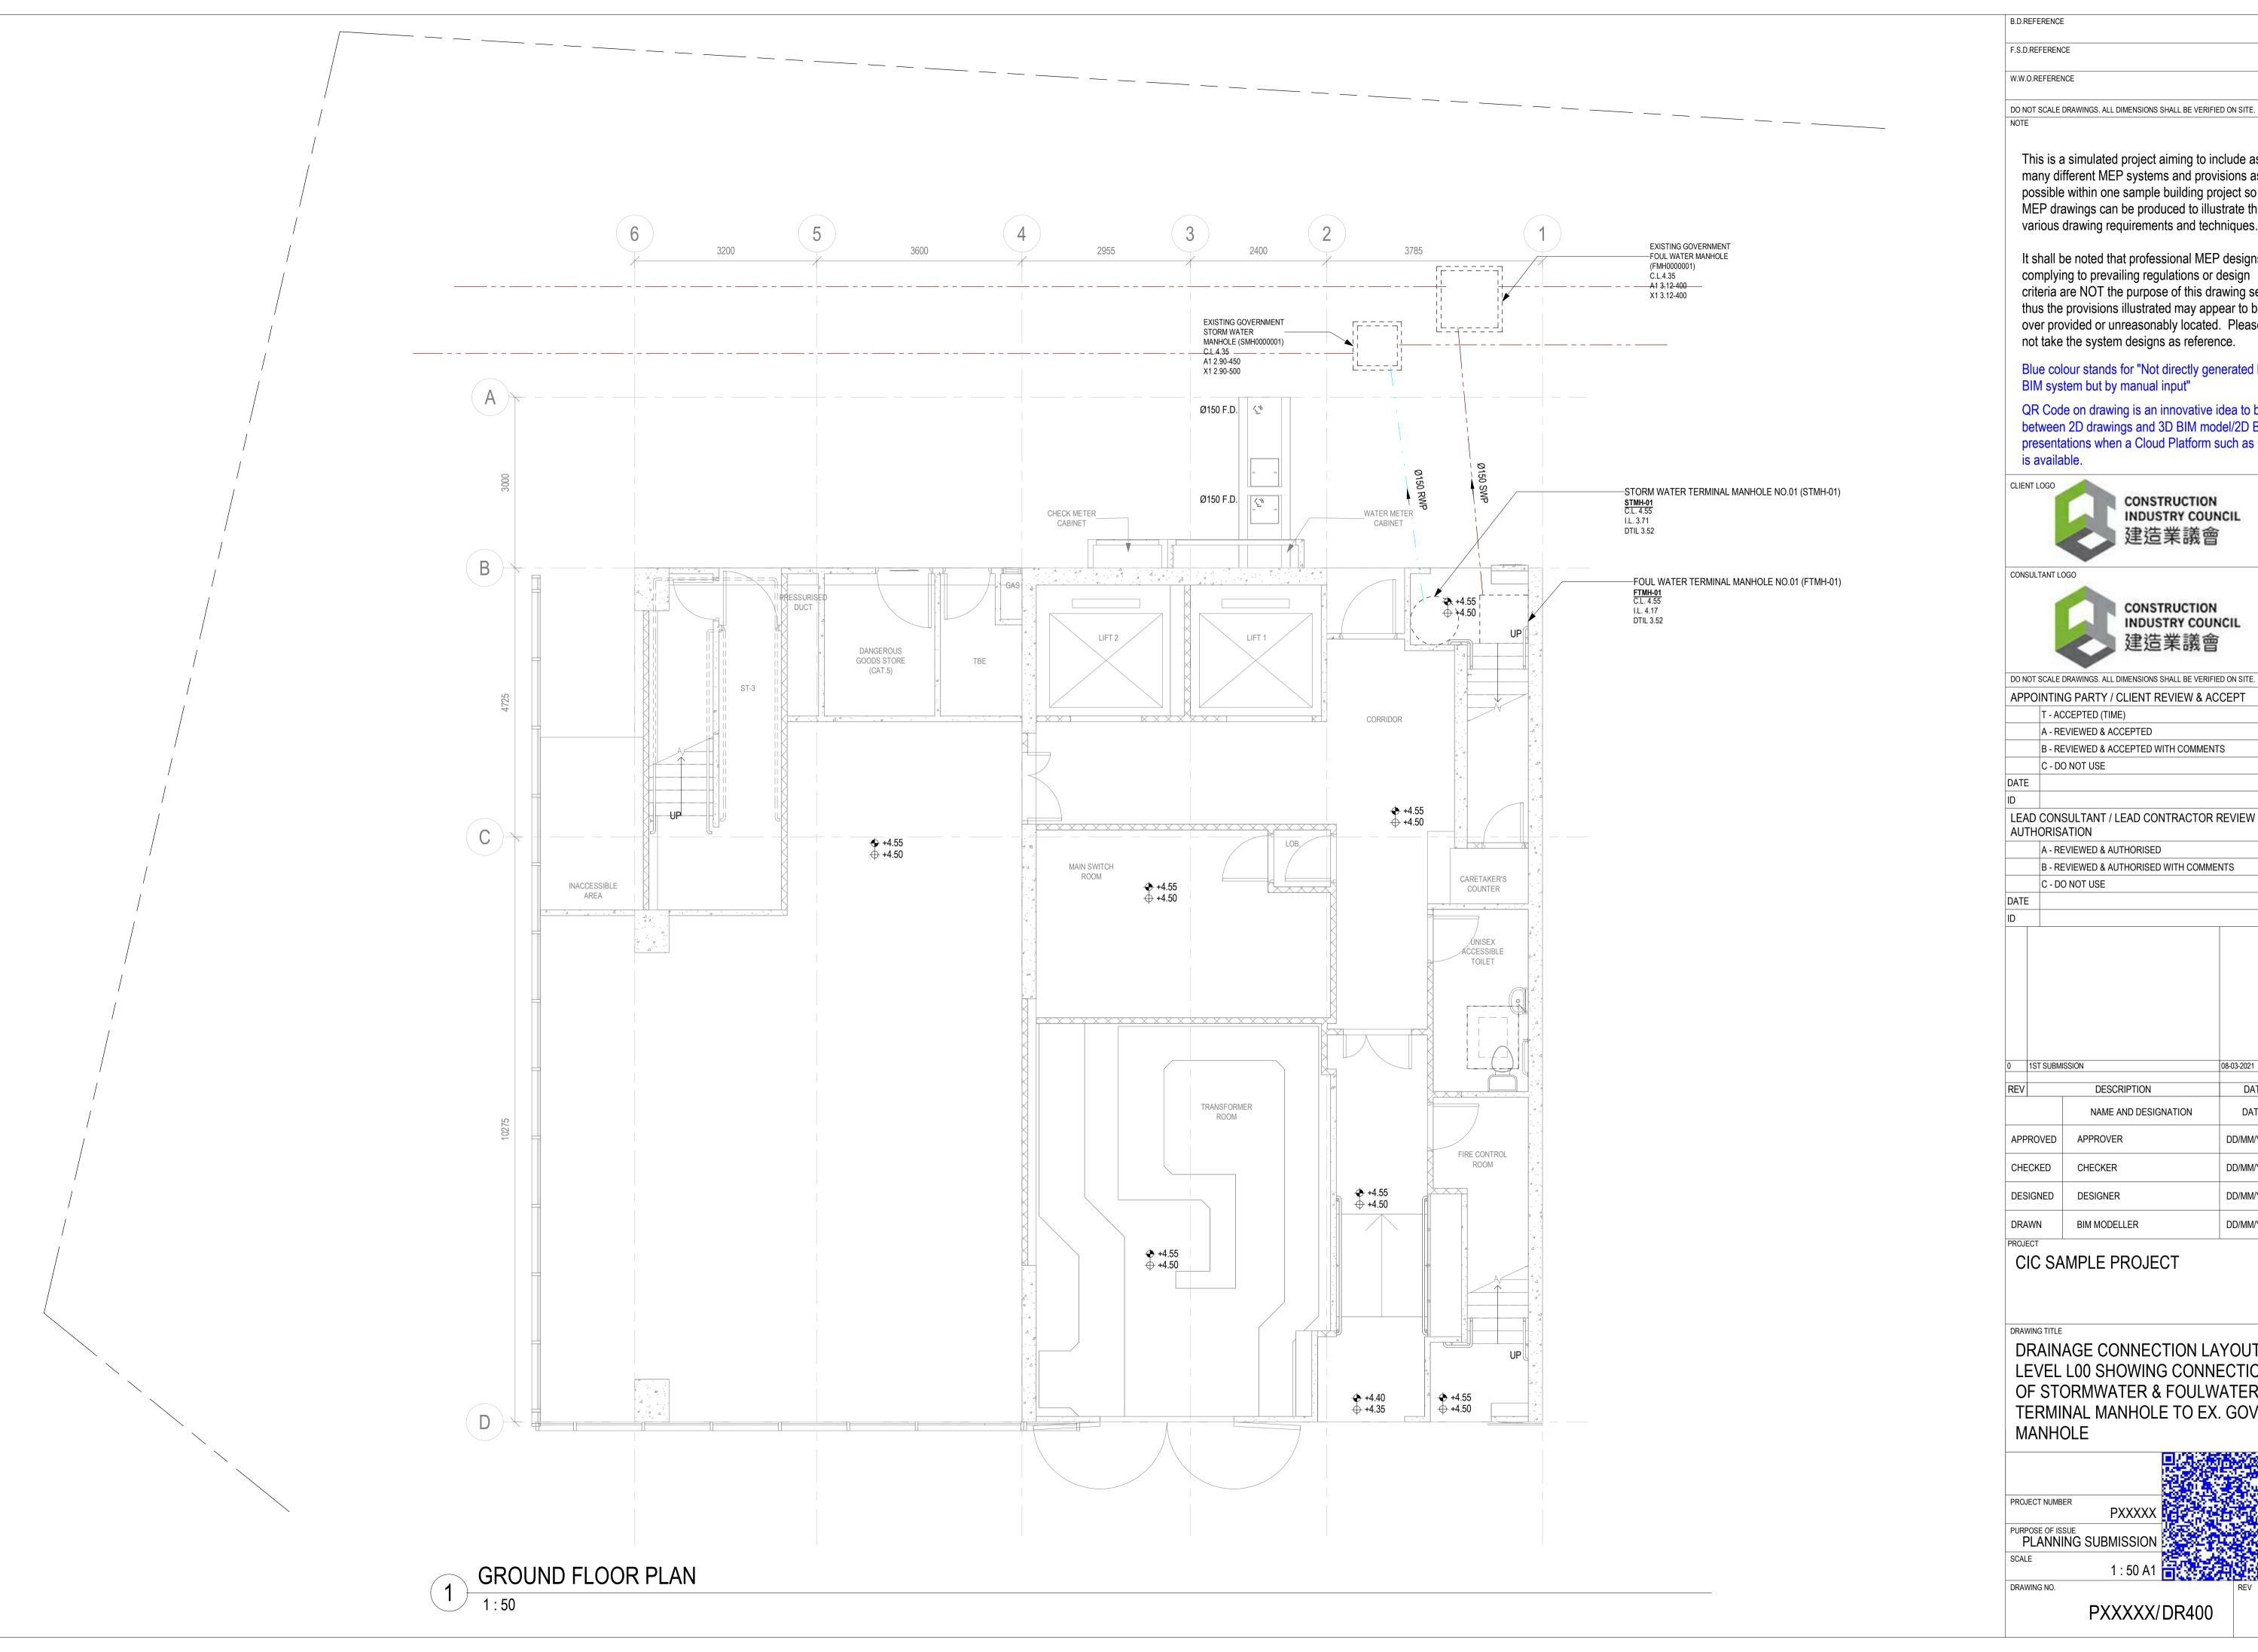

F.S.D.REFERENCE

This is a simulated project aiming to include as many different MEP systems and provisions as possible within one sample building project so that MEP drawings can be produced to illustrate the various drawing requirements and techniques.

It shall be noted that professional MEP designs complying to prevailing regulations or design criteria are NOT the purpose of this drawing set and thus the provisions illustrated may appear to be over provided or unreasonably located. Please do not take the system designs as reference.

Blue colour stands for "Not directly generated by BIM system but by manual input"

QR Code on drawing is an innovative idea to bridge between 2D drawings and 3D BIM model/2D BIM presentations when a Cloud Platform such as CDE is available.

CONSTRUCTION INDUSTRY COUNCIL 建造業議會



APPOINTING PARTY / CLIENT REVIEW & ACCEPT

T - ACCEPTED (TIME) A - REVIEWED & ACCEPTED B - REVIEWED & ACCEPTED WITH COMMENTS C - DO NOT USE

LEAD CONSULTANT / LEAD CONTRACTOR REVIEW & AUTHORISATION

A - REVIEWED & AUTHORISED

B - REVIEWED & AUTHORISED WITH COMMENTS C - DO NOT USE

08-03-2021 DESCRIPTION DATE NAME AND DESIGNATION

APPROVED APPROVER DD/MM/YYYY DD/MM/YYYY DESIGNER DD/MM/YYYY DD/MM/YYYY

BIM MODELLER

DRAINAGE CONNECTION LAYOUT AT LEVEL L00 SHOWING CONNECTION OF STORMWATER & FOULWATER TERMINAL MANHOLE TO EX. GOVT. MANHOLE

PXXXXX PURPOSE OF ISSUE
PLANNING SUBMISSION

PXXXXX/DR400

GENERAL NOTES

THE L.V. SCHEMATIC WIRING DIAGRAM AND THE ASSOCIATED POWER DISTRIBUTION ARRANGEMENT AS SHOWN ON THE DISTRIBUTION BOARD DETAILED DRAWINGS ARE FOR INDICATIVE PURPOSE ONLY. THE SUB-CONTRACTOR SHALL BASED ON THE MINIMUM REQUIREMENTS AS SHOWN ON THIS SET OF DRAWINGS TO DEVELOPE HIS DESIGN IN MORE DETAILS TO SUIT THE SITE CONDITION, AND TO SUBMIT HIS DESIGN DRAWINGS (AS SHOP DRAWINGS) FOR ENGINEER'S AND CLP'S APPROVAL PRIOR TO MATERIAL ORDERING AND INSTALLATION.

THE ELECTRICAL SYSTEM DESIGN AND INSTALLATION CARRIED OUT BY THE SUB-CONTRACTOR SHALL FULLY COMPLY WITH THE LATEST EDITION OF THE CODE OF PRACTICE FOR THE ELECTRICITY (WIRING) REGULATIONS ISSUED BY THE ELECTRICAL AND MECHANICAL SERVICES DEPARTMENT (EMSD), THE SUPPLY RULES OF THE POWER SUPPLY COMPANY AND ALL RELEVANT STATUTORY REQUIREMENTS. THE MEANS FOR PROTECTION AGAINST INDIRECT CONTACT IS BY EARTHED EQUIPOTENTIAL BONDING AND AUTOMATIC DISCONNECTION OF SUPPLY, IN

ELECTRICITY (WIRING) REGULATIONS ISSUED BY THE EMSD. THE LOCATION AND QUANTITY OF EARTH PIT(S) AS SHOWN ON THE DRAWINGS IS FOR INDICATIVE ONLY. THE SUB-CONTRACTOR SHALL PROVIDE PROPER EARTHING SYSTEM AS REQUIRED, AND THE NUMBER OF EARTH ELECTRODE(S) AND THE RESULTANT EARTH FAULT LOOP IMPEDANCE SHALL BE SUCH THAT THE EARTH FAULT CURRENT IS CAPABLE TO ACTUATE THE PROTECTION DEVICES AND CLEAR THE FAULT WITHIN 5 SECONDS FOR ANY EARTH FAULT OCCURS AT THE MAINS AND DISTRIBUTION CIRCUITS. UNLESS OTHERWISE SPECIFIED, THE QUANTITY, SIZE AND TYPE OF ALL POWER DISTRIBUTION CABLES AS INDICATED ON THE DRAWINGS SHALL REFER TO THE

ACCORDANCE WITH THE LATEST EDITION OF THE CODE OF PRACTICE FOR THE

DENOTES THE QUANTITY OF CABLES

FOLLOWING NOTATION:

DENOTES THE TYPE OF CABLES (SEE BELOW): 4/C XLPE/SWA/PVC COPPER CABLE 3/C XLRE/SWA/PVC COPPER CABLE 2/C XLPE/SWA/PVC COPPER CABLE

1/C XLPEXPVC COPPER CABLE 1/C PVC COPPER CABLE

4/C FR/LSOH/SWA/LSOH FIRE RESISTANT CORRED CARLE 3/C FR/LSOH/SWA/LSOH FIRE RESISTANT C FOR REFERENCE ONLY
1/C FR/LSOH/LSOH FIRE RESISTANT C FOR REFERENCE ONLY

1/C FR/LSOH FIRE RESISTANT COPPER CABLE


1/C XLPE/PVC COPPER CABLE C/W PRE-FABRICATED

LEGENDS


SYMBOL	FRONT	DESCRIPTION
TPN		DRAW-OUT TYPE AIR CIRCUIT BREAKER (ACB) WITHOUT BUILT-IN OVERLOAD AND SHORT-CIRCUIT PROTECTION BUT C/W SHUNT-TRIP FACILITY; WHERE THE SYMBOL: - 'X' DENOTES THE NOMINAL CURRENT (In) SET BY PROTECTION RELAYS - 'Y' DENOTES THE FRAME SIZE OF THE AIR CIRCUIT BREAKER
'X' A 'Y' A		AIR CIRCUIT BREAKER (ACB) C/W ADJUSTABLE SHORT-CIRCUIT & OVER-CURRENT PROTECTION SETTINGS AND SHUNT-TRIP FACILITY, WHERE THE SYMBOL: - 'X' DENOTES THE SETTING NOMINAL CURRENT (In) RATING - 'Y' DENOTES THE FRAME SIZE OF THE AIR CIRCUIT BREAKER DRAW-OUT TYPE MOULDED CASE CIRCUIT BREAKER (MCCB) C/W ADJUSTABLE SHORT-CIRCUIT & OVER-CURRENT PROTECTION RATING AND SHUNT-TRIP FACILITY; WHERE THE SYMBOL: - 'X' DENOTES THE SETTING NOMINAL CURRENT (In) RATING
	pag .	- 'Y' DENOTES THE FRAME SIZE OF THE MOULDED CASE CIRCUIT BREAKER 13A SWITCHED SOCKET OUTLET
<u> </u>	<u> </u>	13A SWITCHED FUSED SPUR UNIT
•	EI.	10A 1-WAY LIGHTING SWITCH
^	₽	10A 2-WAY LIGHTING SWITCH
P	Ð	ISOLATING SWITCH
		CONTROL PANEL
		MCB D.B.

CABLE SI	ZE SCHE	DULE-A				
PROTECTIVE	MINIMUM CABLE SIZE FOR FINAL CIRCUIT ENCLOSED IN CONDUIT / TRUNKING					
NOMINAL CURRENT RATING	PH	GLE- ASE CUIT	THREE- PHASE CIRCUIT			
(In)	LIVE & NEUTRAL CONDUCTORS	CIRCUIT PROTECTIVE CONDUCTORS (C.P.C.)	LIVE & NEUTRAL CONDUCTORS	CIRCUIT PROTECTIVE CONDUCTORS (C.P.C.)		
6A	2x1.5mm²	1x1.5mm²	4x2.5mm²	1x2.5mm²		
10A	2x2.5mm²	1x2.5mm²	4x2.5mm²	1x2.5mm²		
16A	2x2.5mm²	1x2.5mm²	4x4.0mm²	1x4.0mm²		
20A	2x4.0mm	1x4.0mm²	4x4.0mm²	1x4.0mm²		
32A (RADIAL)	2x6.0mm²	1x6.0mm ²	4x10.0mm²	1x10.0mm²		
32A (RING)	4x2.5mm²	2x2.5mm²	-	-		
40A	2x10.0mm ²	1x10.0mm²	4x10.0mm²	1x10.0mm²		
50A	2x16.0mm ²	1x16.0mm²	4x16.0mm²	1x16.0mm ²		
63A	2x25.0mm ²	1x16.0mm²	4x25.0mm²	1x16.0mm²		
80A	2x35.0mm ²	1x16.0mm ²	4x35.0mm ²	1x16.0mm ²		
100A	-	-	4x50.0mm ²	1x25.0mm²		
125A	-	-	4x70.0mm ²	1x35.0mm²		
160A	-	-	4x120mm²	1x70.0mm²		
200A	-	-	4x150mm²	1x95.0mm ²		

<u>DRAWING LIST</u>					
DRAWING NUMBER	DRAWING NUMBER DRAWING TITLE				
EL001	GENERAL NOTES, LEGENDS, ABBREVIATION AND DRAWING LIST	0			
EL100	SCHEMATIC	0			
EL101	ELECTRICAL LAYOUT PLAN AT LEVEL GF, L01, L02, L03	0			
EL102	ELECTRICAL LAYOUT PLAN AT LEVEL L04-L15, RF, URF, TRF	0			
EL103	LIGHTING LAYOUT PLAN AT LEVEL GF, L01, L02, L03	0			
EL104	LIGHTING LAYOUT PLAN AT LEVEL L04-L15, RF, URF, TRF	0			
EL400	TRANSFORMER ROOM LAYOUT AT LEVEL GF	0			
EL401	L.V. SWITCH ROOM LAYOUT AT LEVEL GF	0			
EL402	EMERGENCY GENERATOR ROOM LAYOUT AND SECTIONAL DETAILS	0			
EL403	TBE ROOM LAYOUT AT LEVEL GF	0			

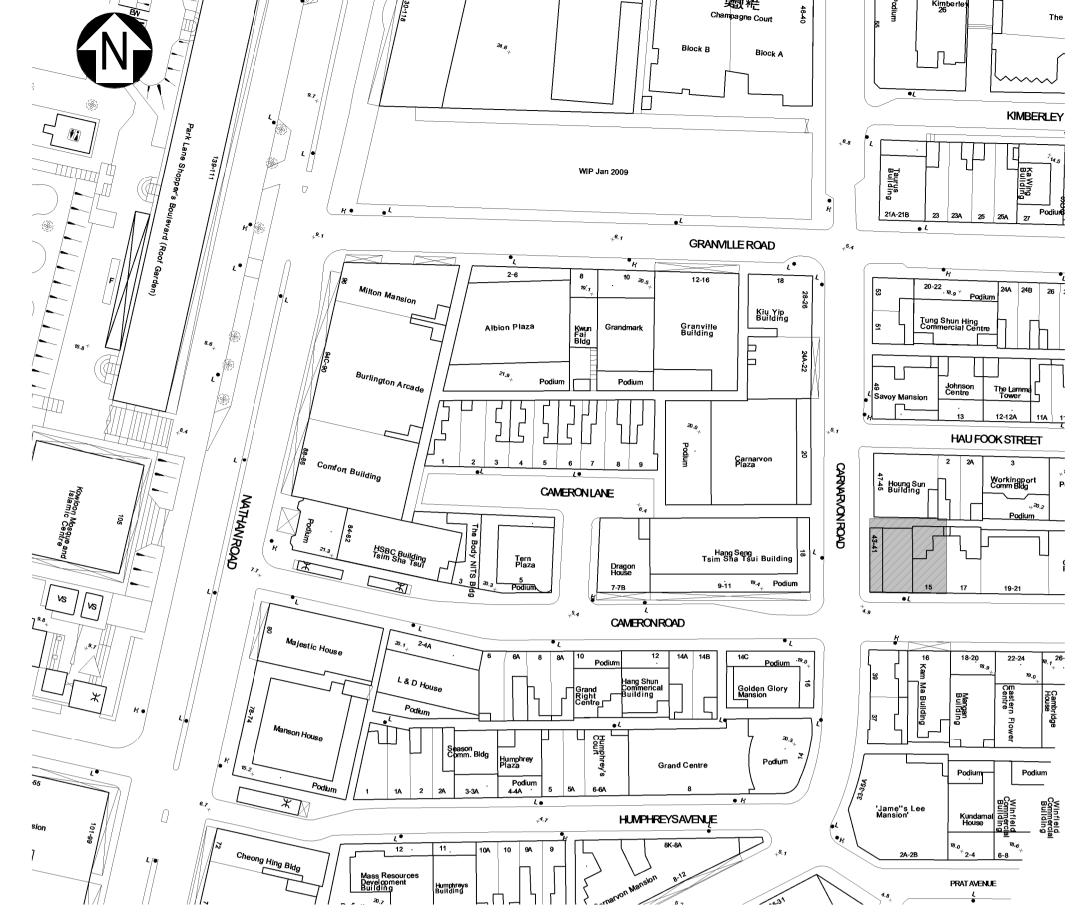

LOCATION PLAN

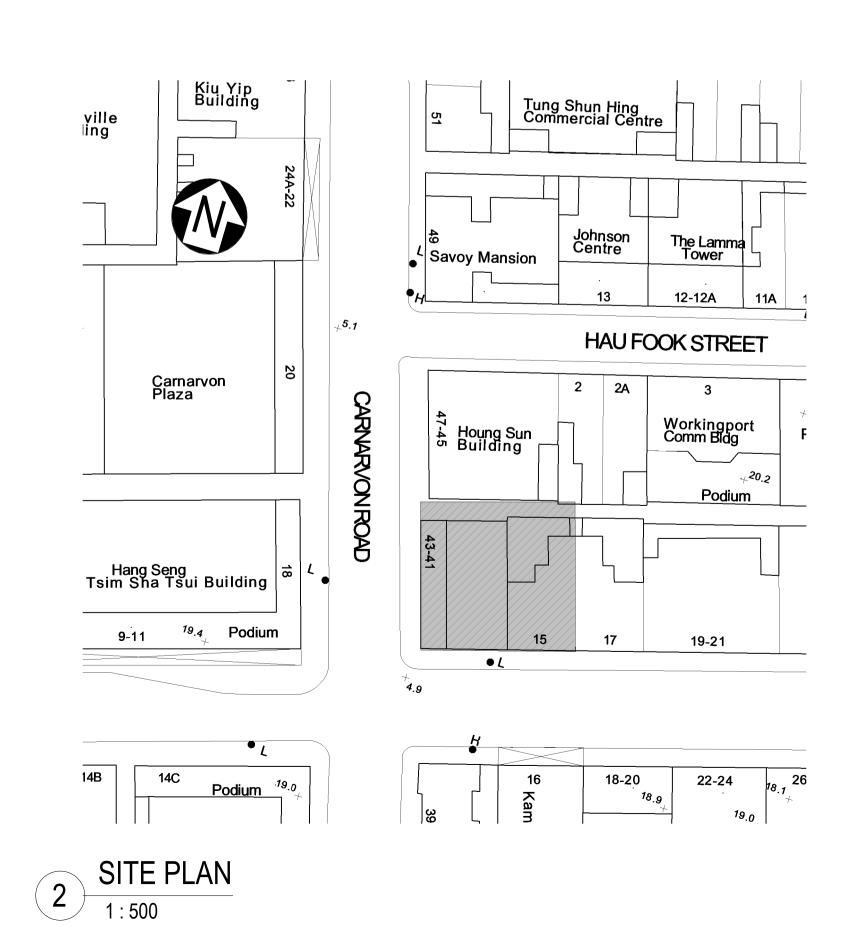

B.D.REFERENCE F.S.D.REFERENCE W.W.O.REFERENCE DO NOT SCALE DRAWINGS. ALL DIMENSIONS SHALL BE VERIFIED ON SITE.

This is a simulated project aiming to include as many different MEP systems and provisions as possible within one sample building project so that MEP drawings can be produced to illustrate the various drawing requirements and techniques.

It shall be noted that professional MEP designs complying to prevailing regulations or design criteria are NOT the purpose of this drawing set and thus the provisions illustrated may appear to be over provided or unreasonably located. Please do not take the system designs as reference.

Blue colour stands for "Not directly generated by BIM system but by manual input"

QR Code on drawing is an innovative idea to bridge between 2D drawings and 3D BIM model/2D BIM presentations when a Cloud Platform such as CDE is available.





INDUSTRY COUNCIL 建造業議會

DO NOT SCALE DRAWINGS. ALL DIMENSIONS SHALL BE VERIFIED ON SITE APPOINTING PARTY / CLIENT REVIEW & ACCEPT T - ACCEPTED (TIME)

A - REVIEWED & ACCEPTED B - REVIEWED & ACCEPTED WITH COMMENTS C - DO NOT USE

DATE

LEAD CONSULTANT / LEAD CONTRACTOR REVIEW & AUTHORISATION

A - REVIEWED & AUTHORISED B - REVIEWED & AUTHORISED WITH COMMENTS C - DO NOT USE

DATE

08-03-2021 1ST SUBMISSION DESCRIPTION DATE NAME AND DESIGNATION DATE

APPROVED CHECKED DESIGNER DESIGNED


BIM MODELLER

CIC SAMPLE PROJECT

GENERAL NOTES, LEGENDS, ABBREVIATION AND DRAWING LIST

PXXXXX PURPOSE OF ISSUE
PLANNING SUBMISSION DRAWING NO.


PXXXXX/EL001

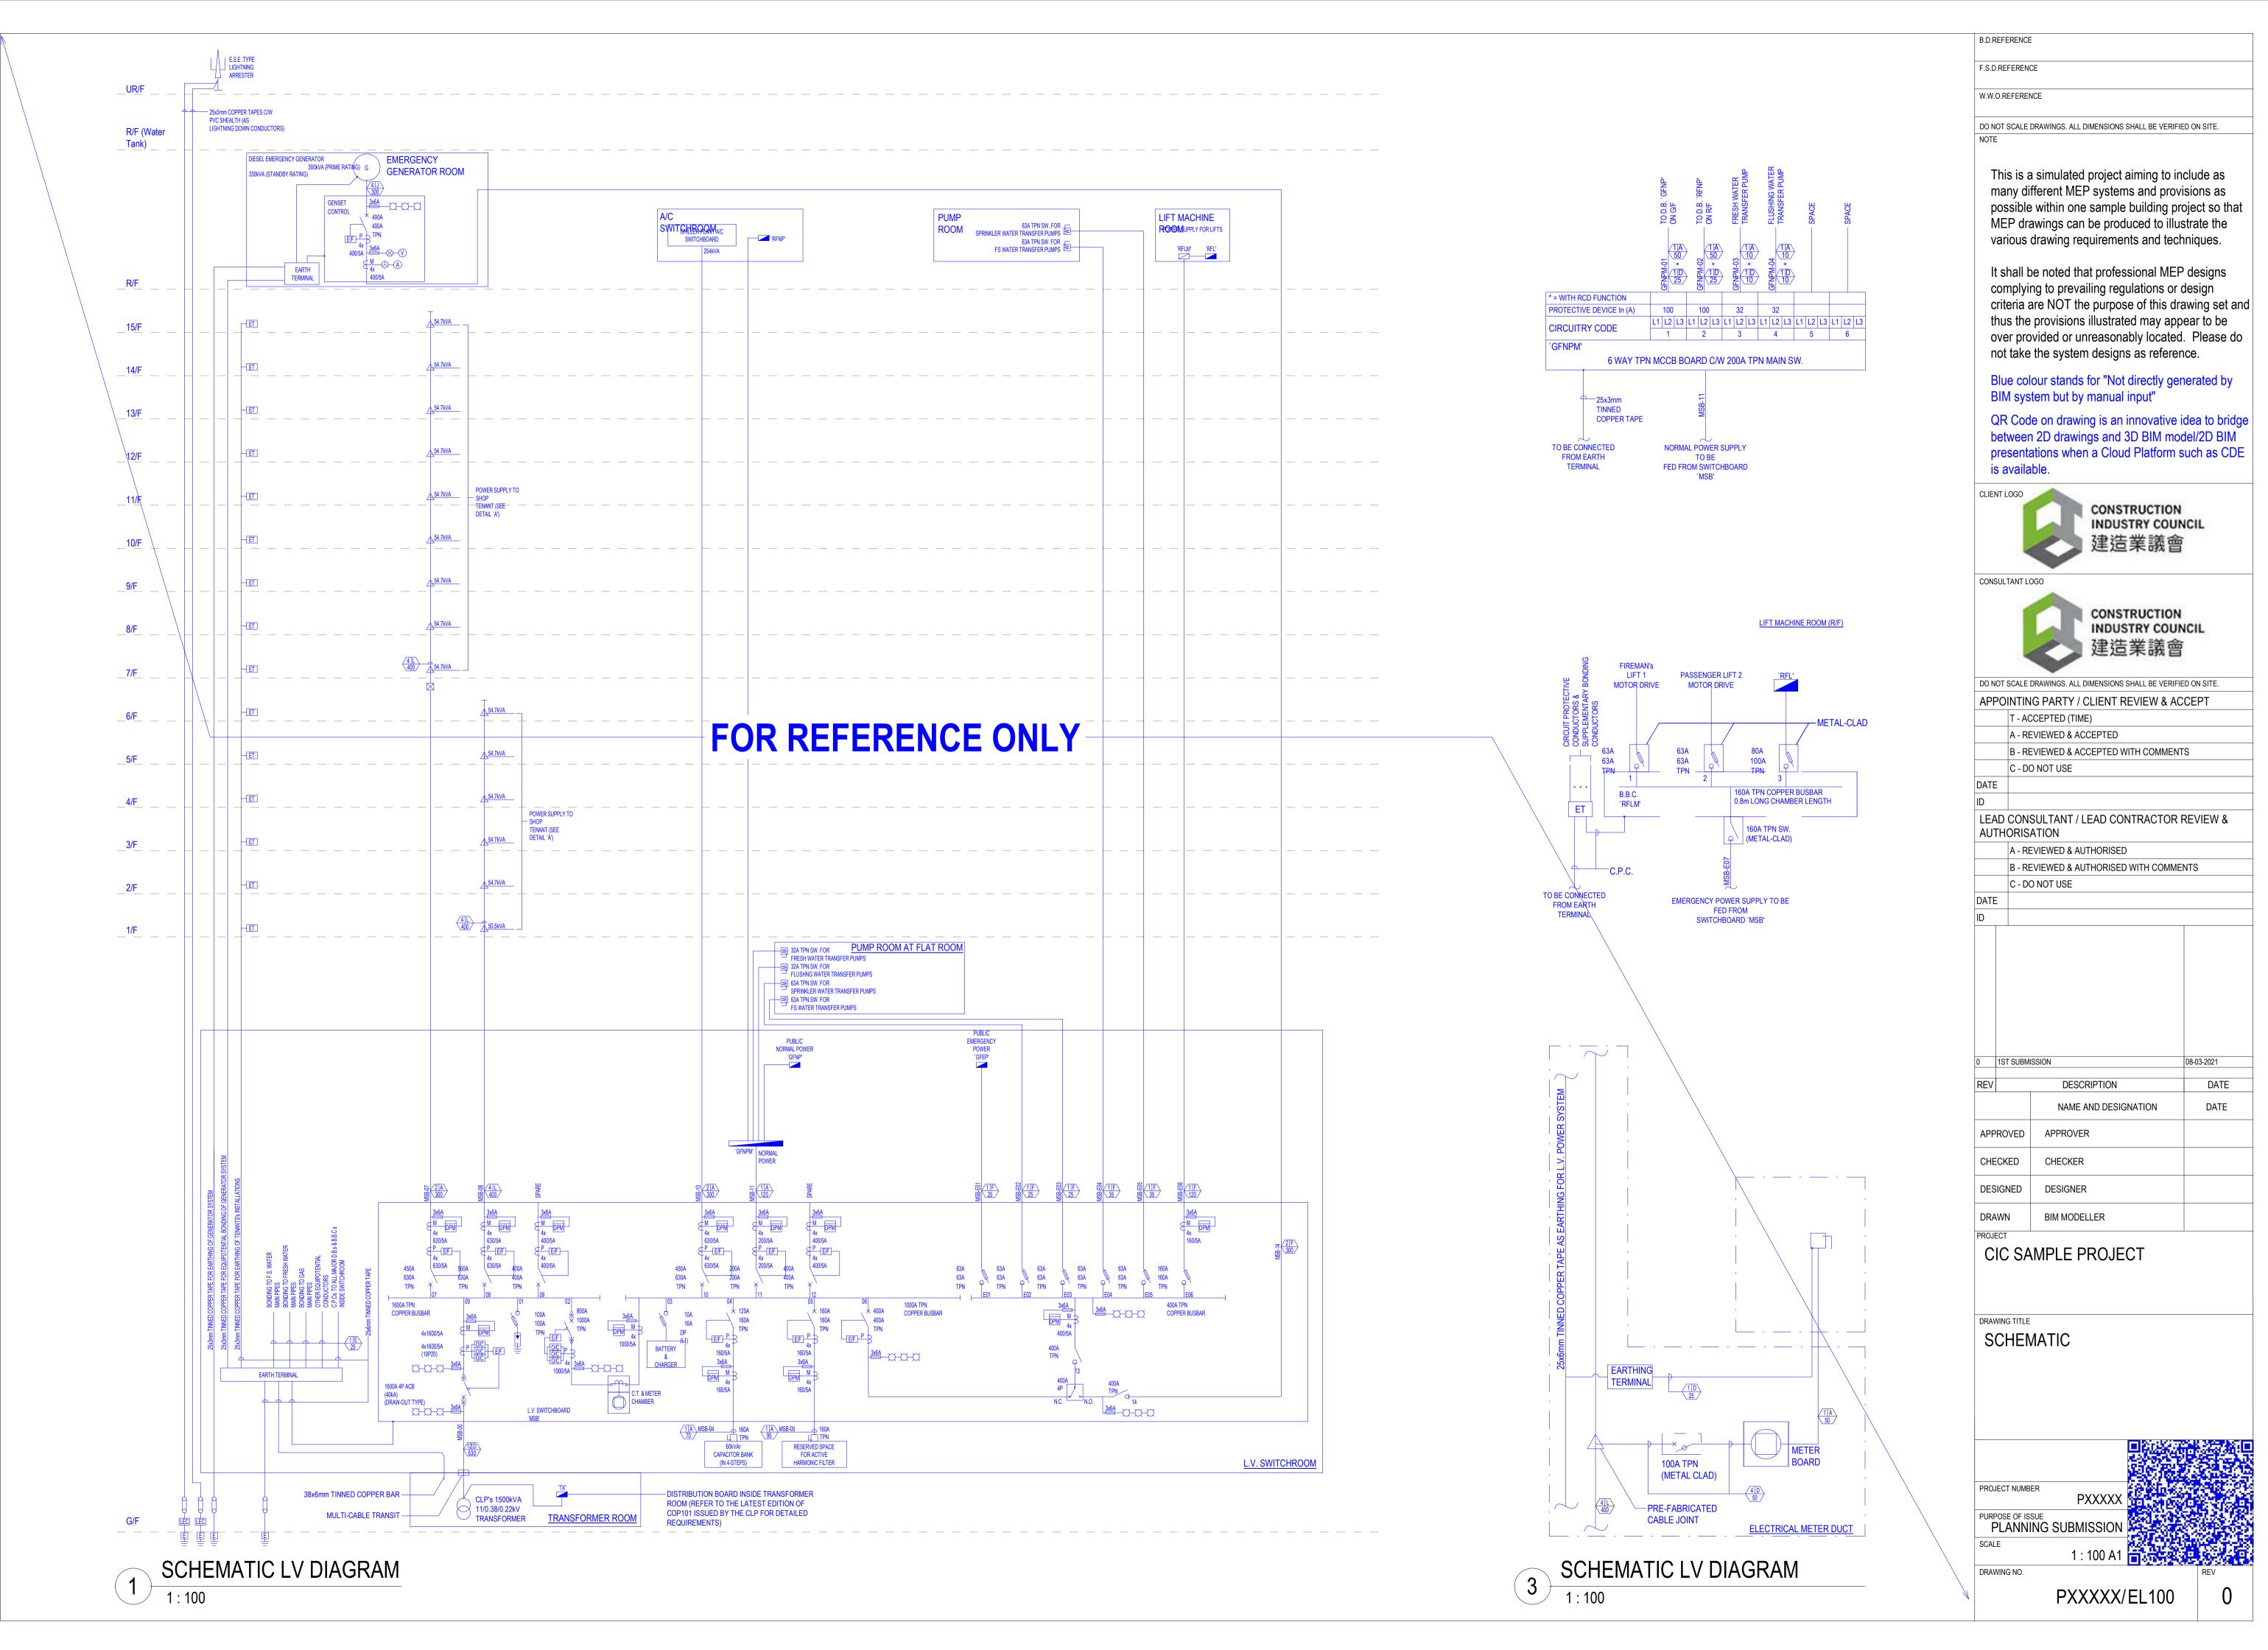


PRINTED BY:

DRV: :LNAME:

MODELNA

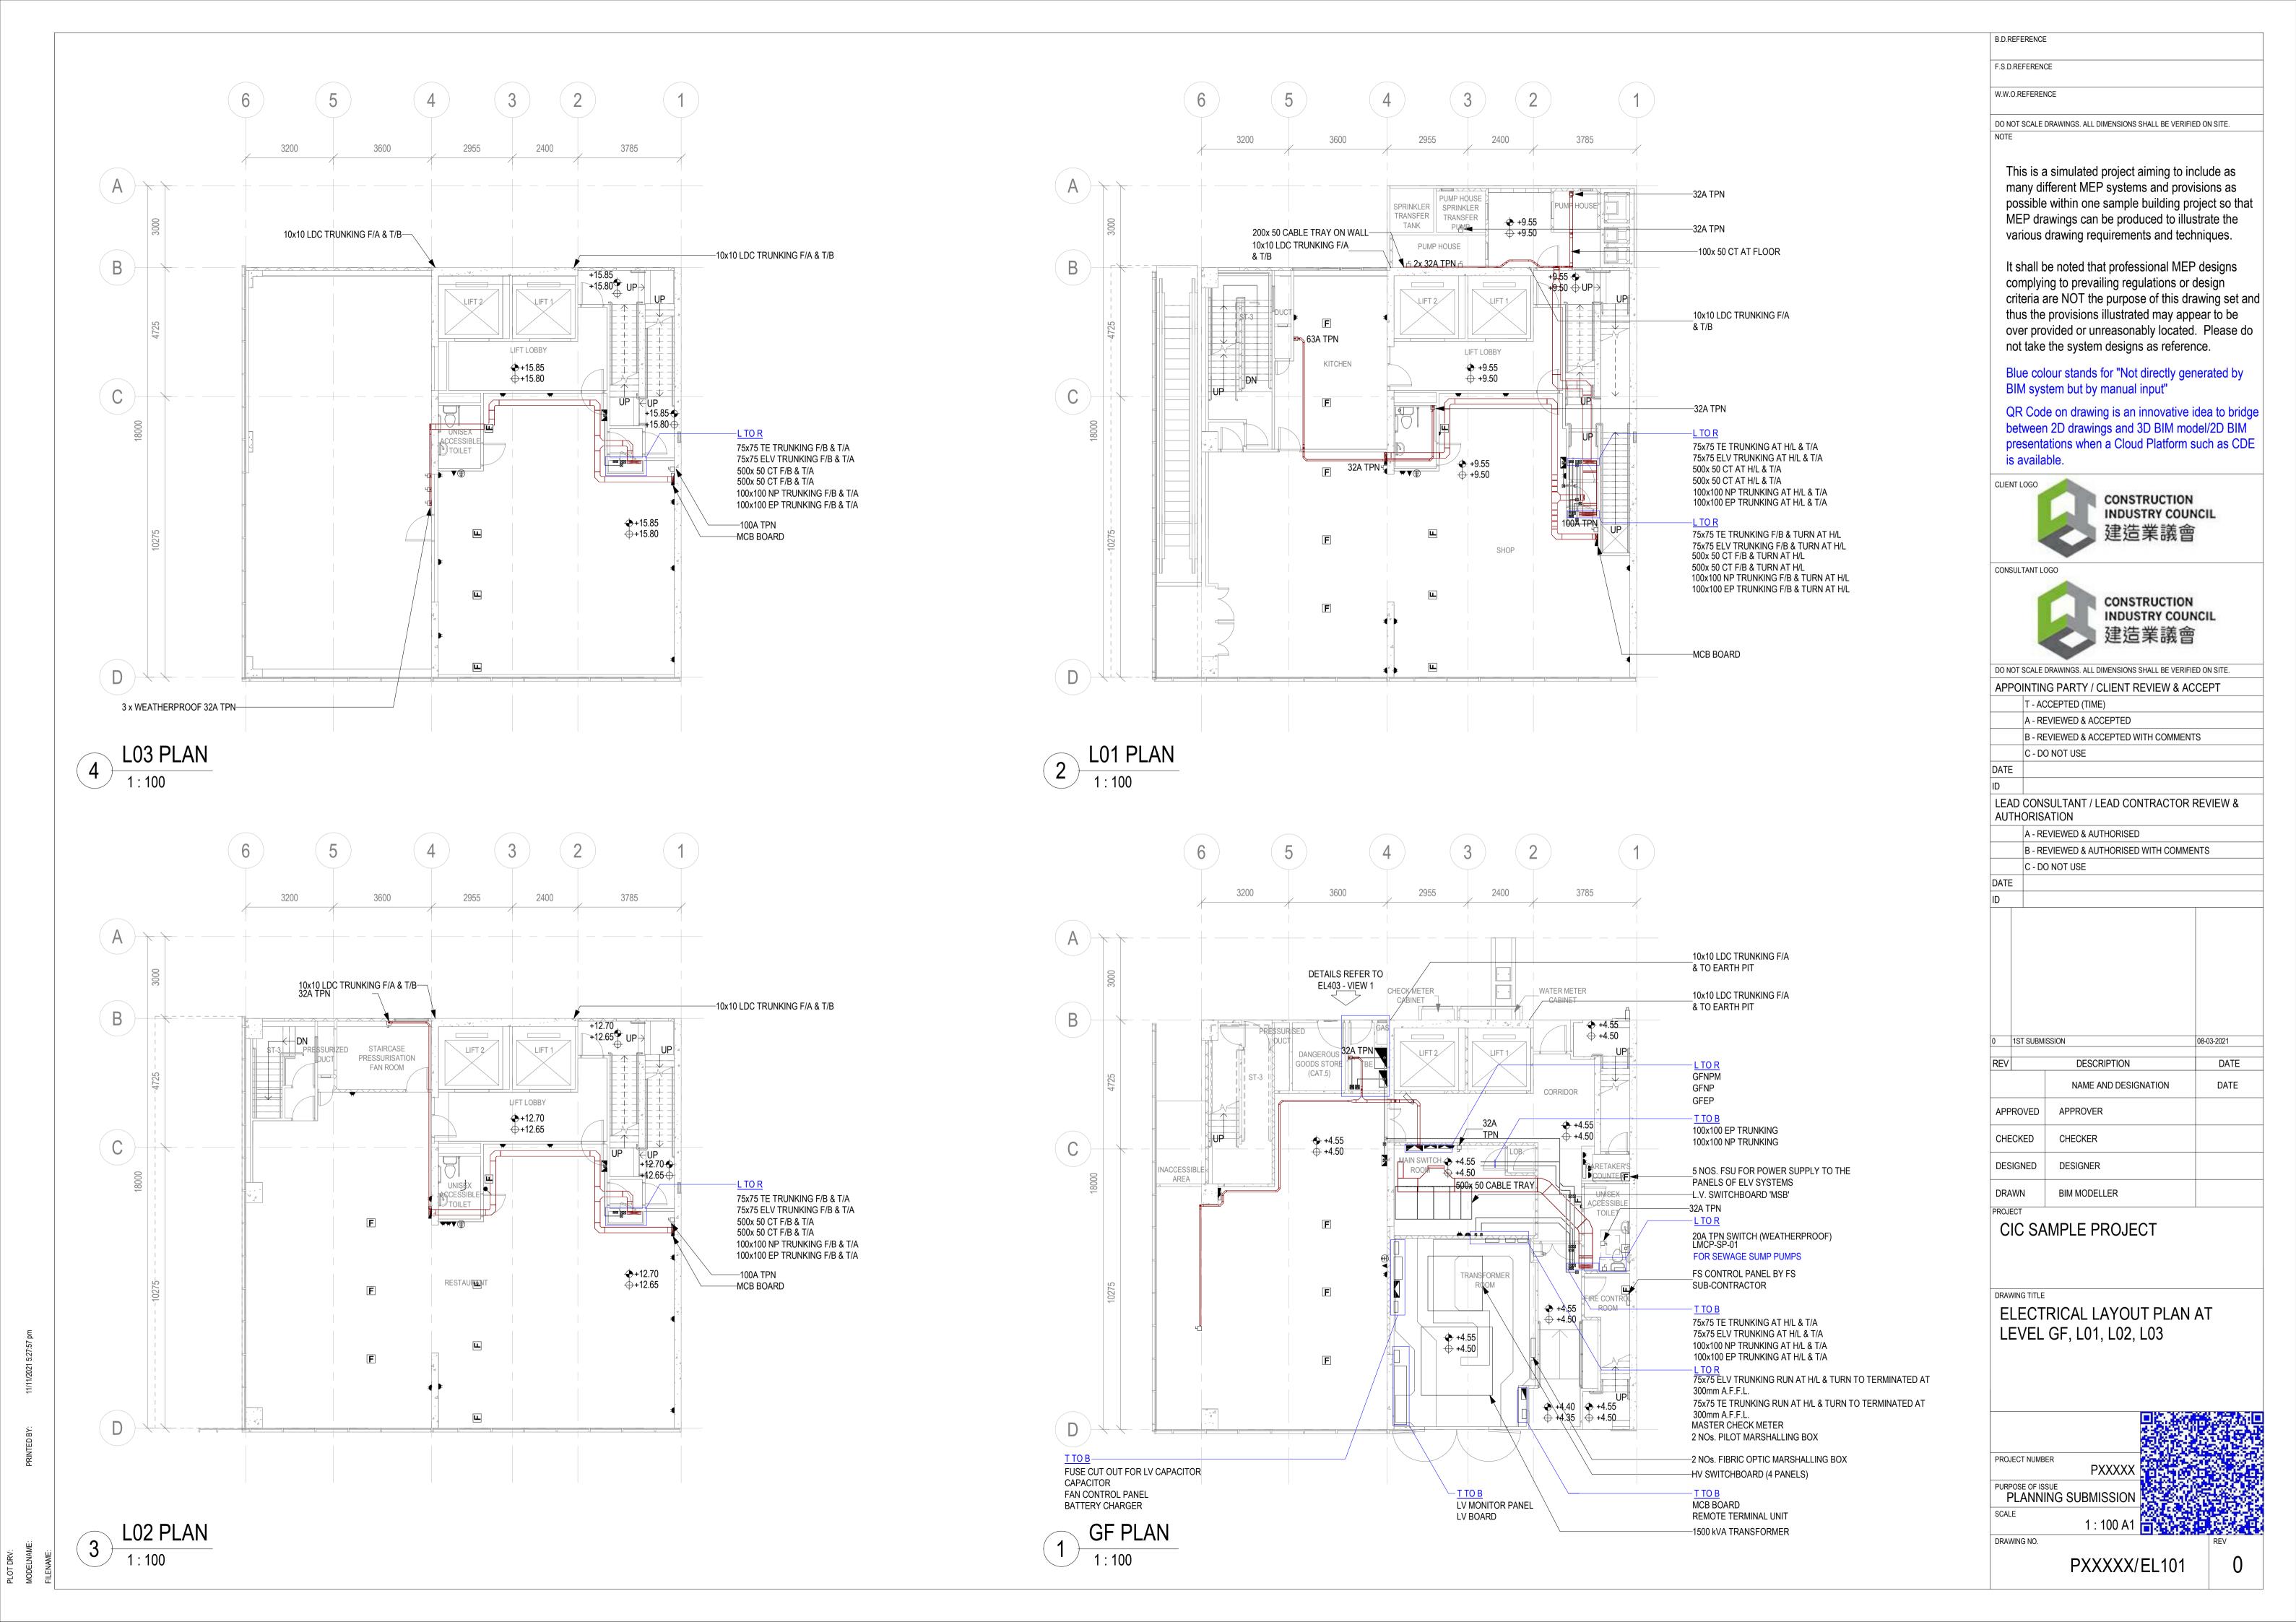


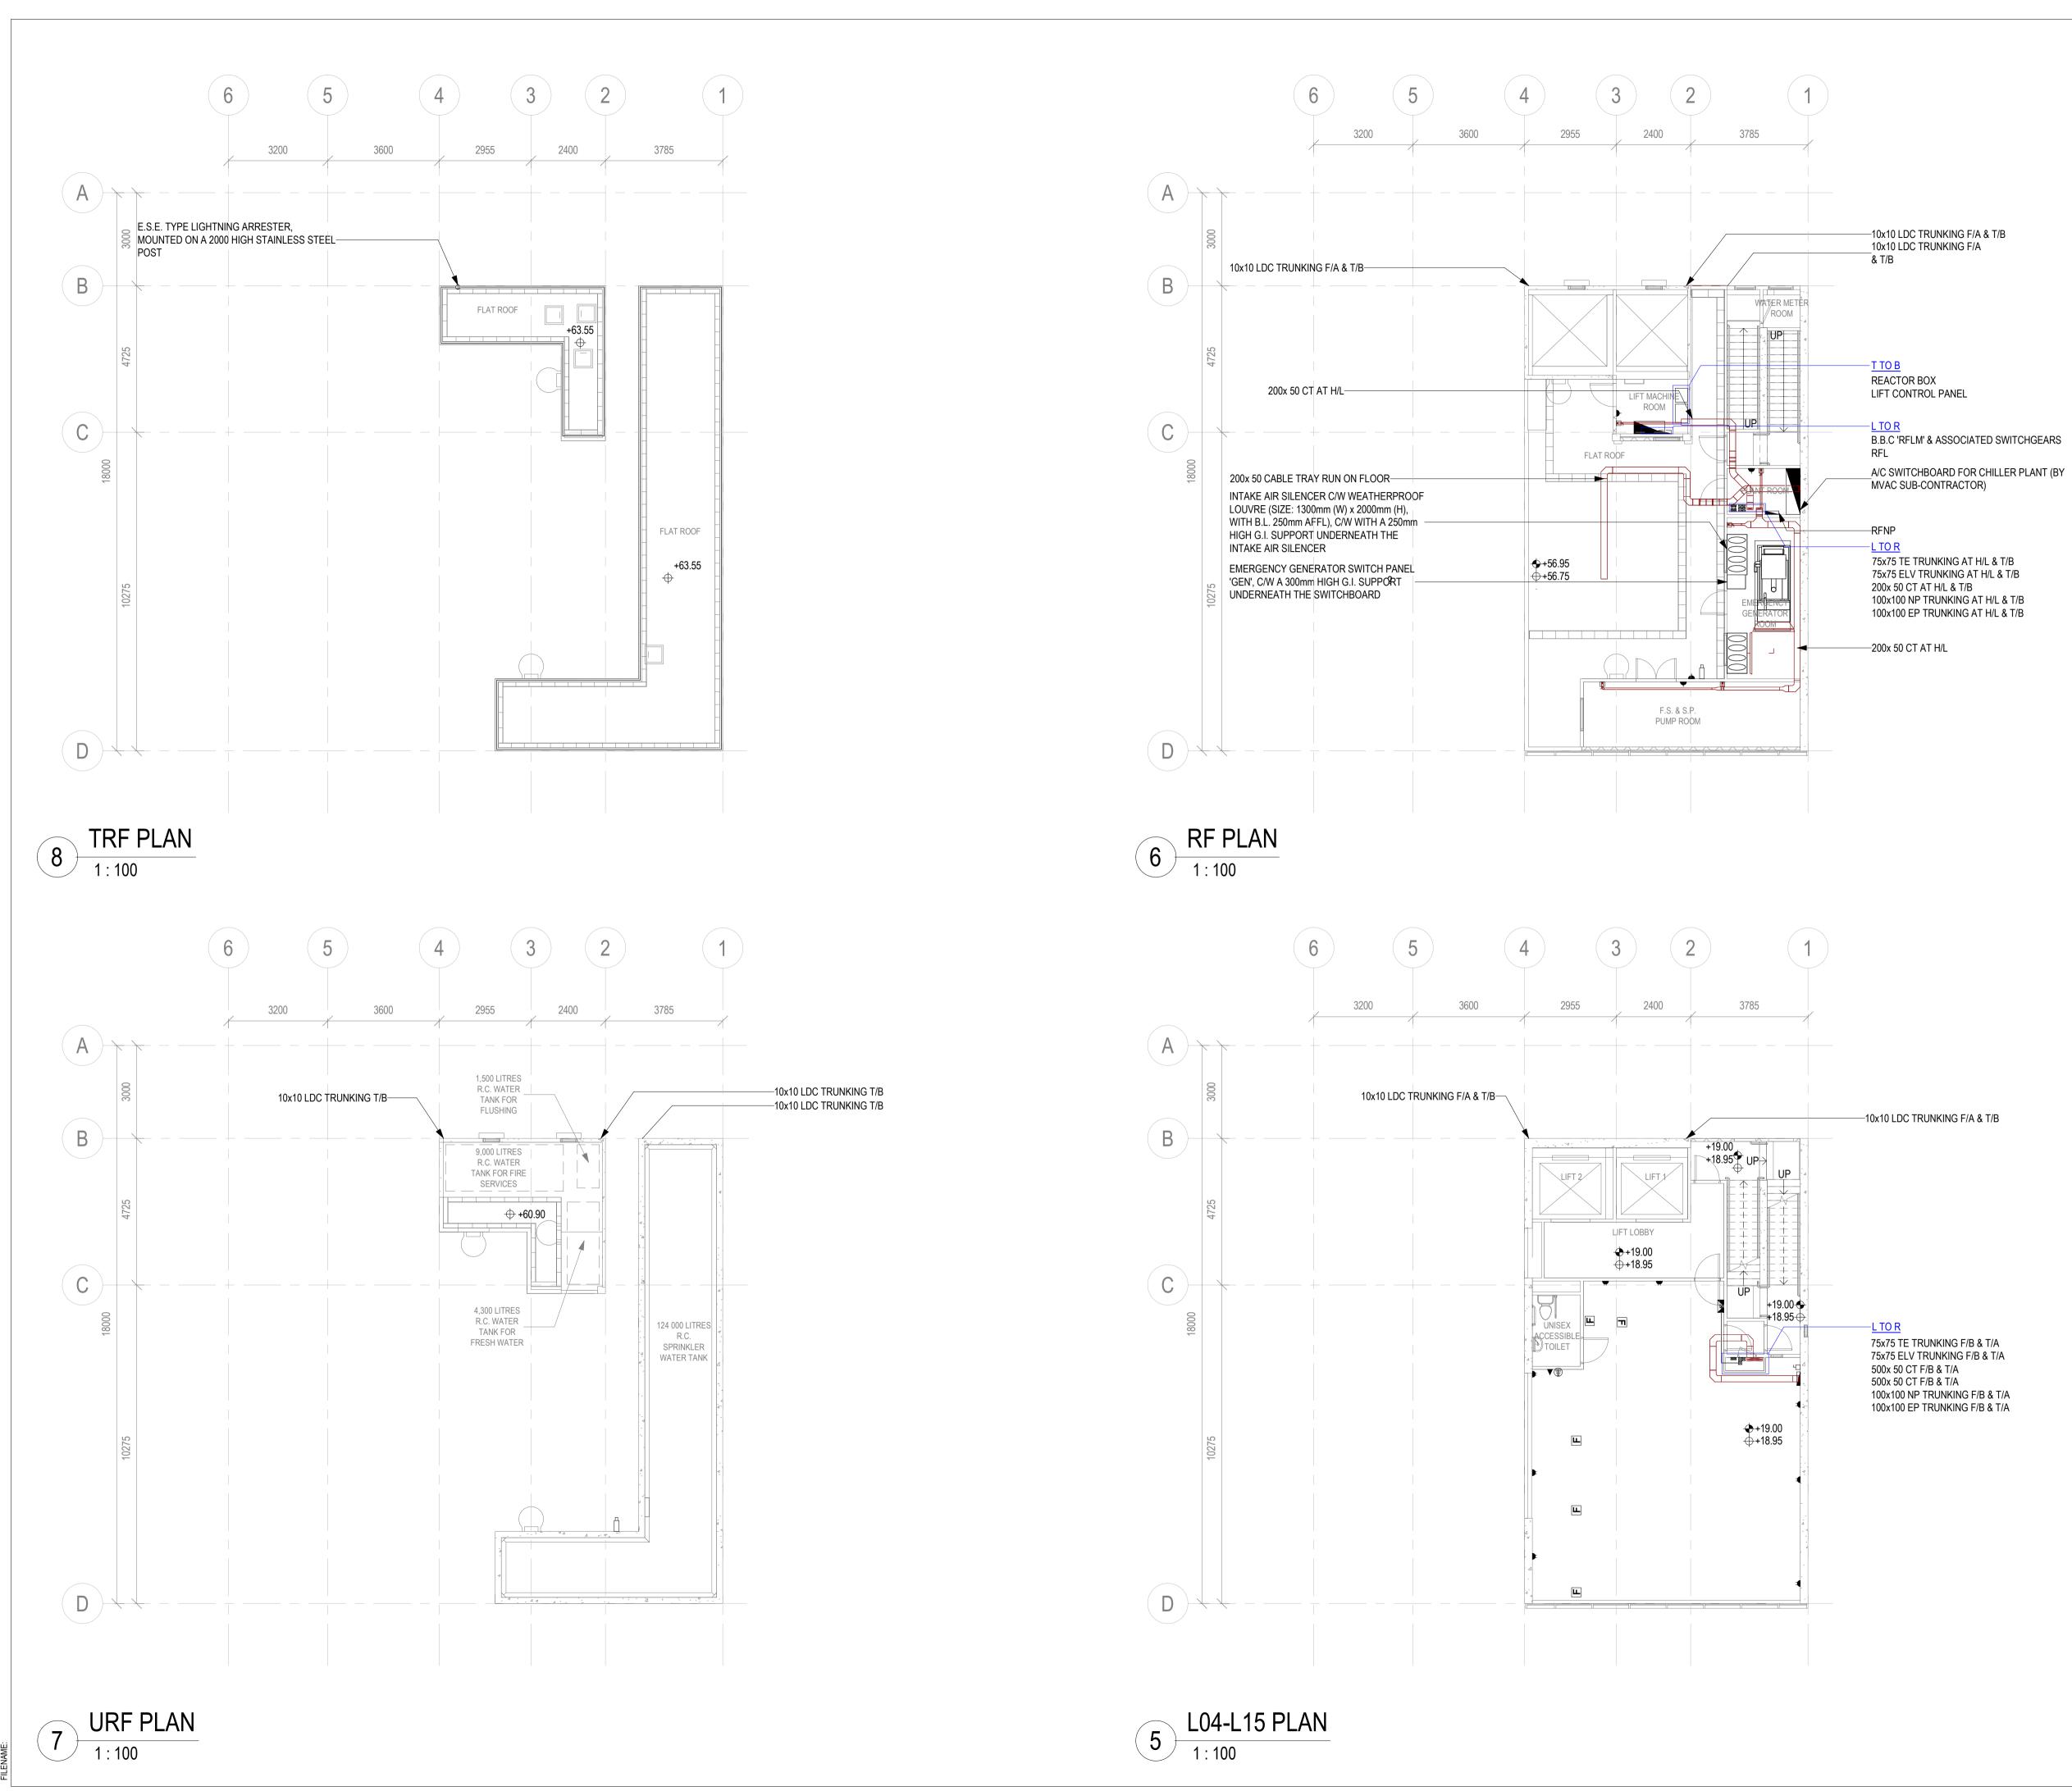



F.S.D.REFERENCE W.W.O.REFERENCE DO NOT SCALE DRAWINGS. ALL DIMENSIONS SHALL BE VERIFIED ON SITE. This is a simulated project aiming to include as many different MEP systems and provisions as possible within one sample building project so that MEP drawings can be produced to illustrate the various drawing requirements and techniques. It shall be noted that professional MEP designs complying to prevailing regulations or design criteria are NOT the purpose of this drawing set and thus the provisions illustrated may appear to be over provided or unreasonably located. Please do not take the system designs as reference. Blue colour stands for "Not directly generated by BIM system but by manual input" QR Code on drawing is an innovative idea to bridge between 2D drawings and 3D BIM model/2D BIM presentations when a Cloud Platform such as CDE is available. CLIENT LOGO CONSTRUCTION INDUSTRY COUNCIL 建造業議會 CONSULTANT LOGO CONSTRUCTION INDUSTRY COUNCIL 建造業議會 DO NOT SCALE DRAWINGS. ALL DIMENSIONS SHALL BE VERIFIED ON SITE APPOINTING PARTY / CLIENT REVIEW & ACCEPT T - ACCEPTED (TIME) A - REVIEWED & ACCEPTED B - REVIEWED & ACCEPTED WITH COMMENTS C - DO NOT USE LEAD CONSULTANT / LEAD CONTRACTOR REVIEW & AUTHORISATION A - REVIEWED & AUTHORISED B - REVIEWED & AUTHORISED WITH COMMENTS C - DO NOT USE DATE 08-03-2021 1ST SUBMISSION DESCRIPTION DATE NAME AND DESIGNATION DATE APPROVED APPROVER CHECKED CHECKER DESIGNED DESIGNER DRAWN **BIM MODELLER** CIC SAMPLE PROJECT ELECTRICAL LAYOUT PLAN AT LEVEL L04-L15, RF, URF, TRF PXXXXX PURPOSE OF ISSUE
PLANNING SUBMISSION DRAWING NO. PXXXXX/EL102

B.D.REFERENCE

PLOT DRV: MODELNAME:

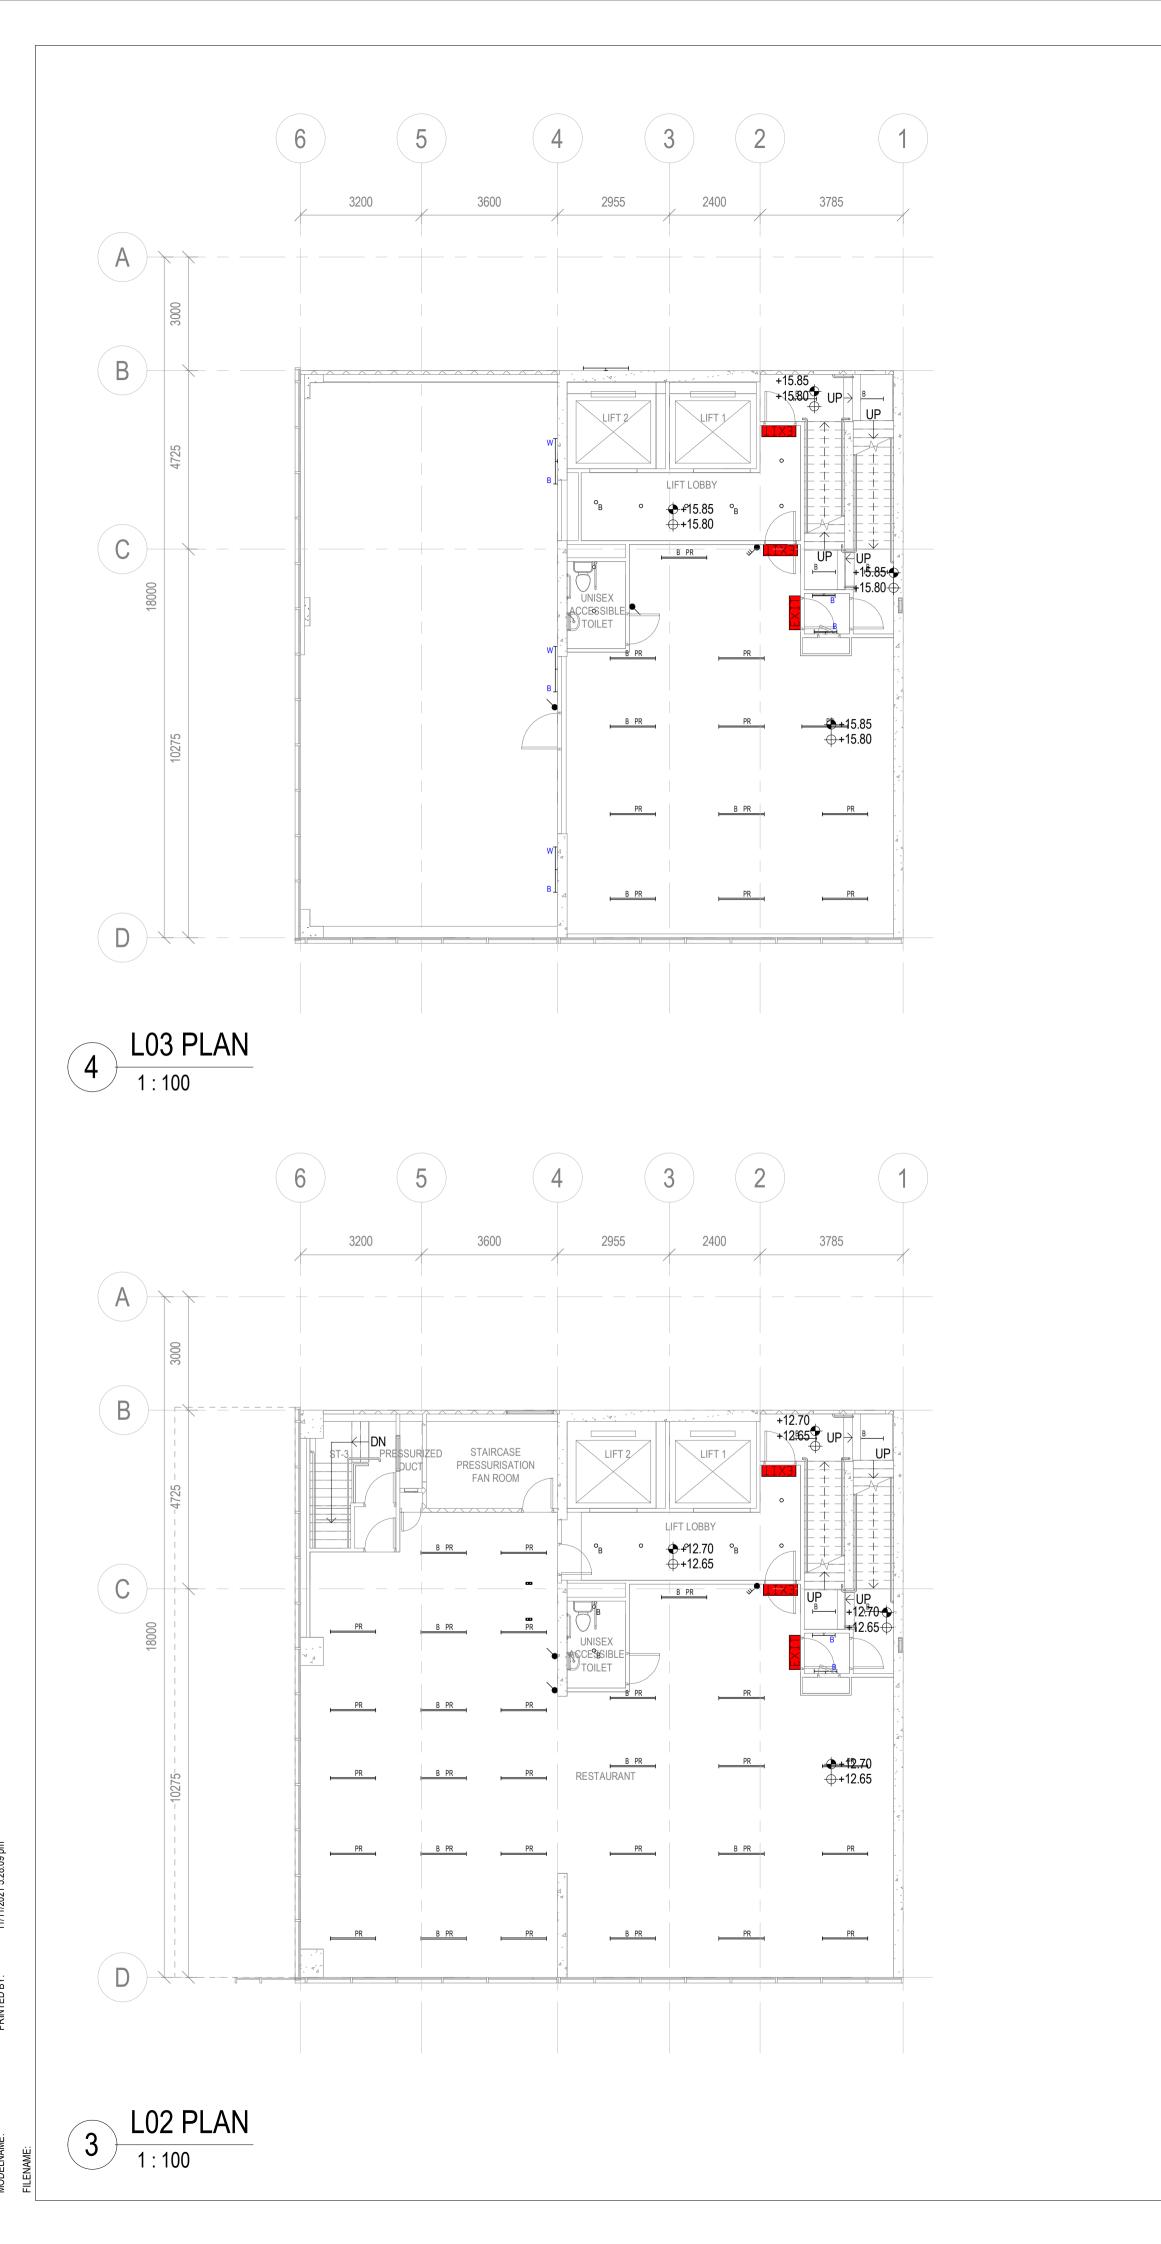

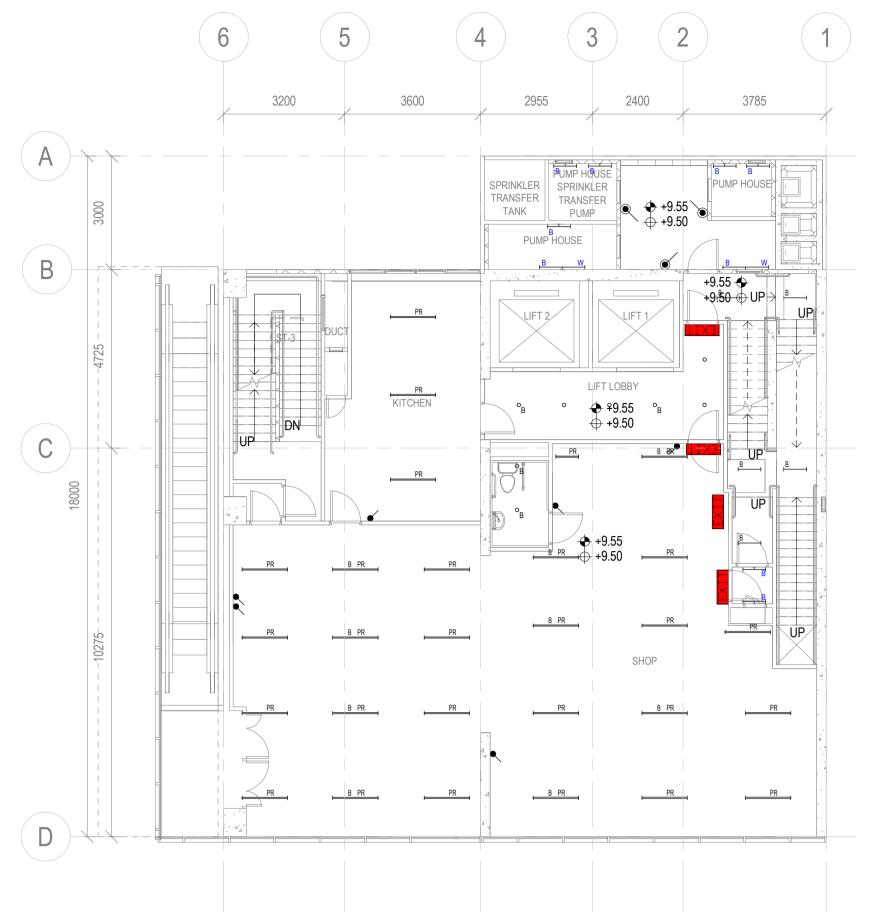

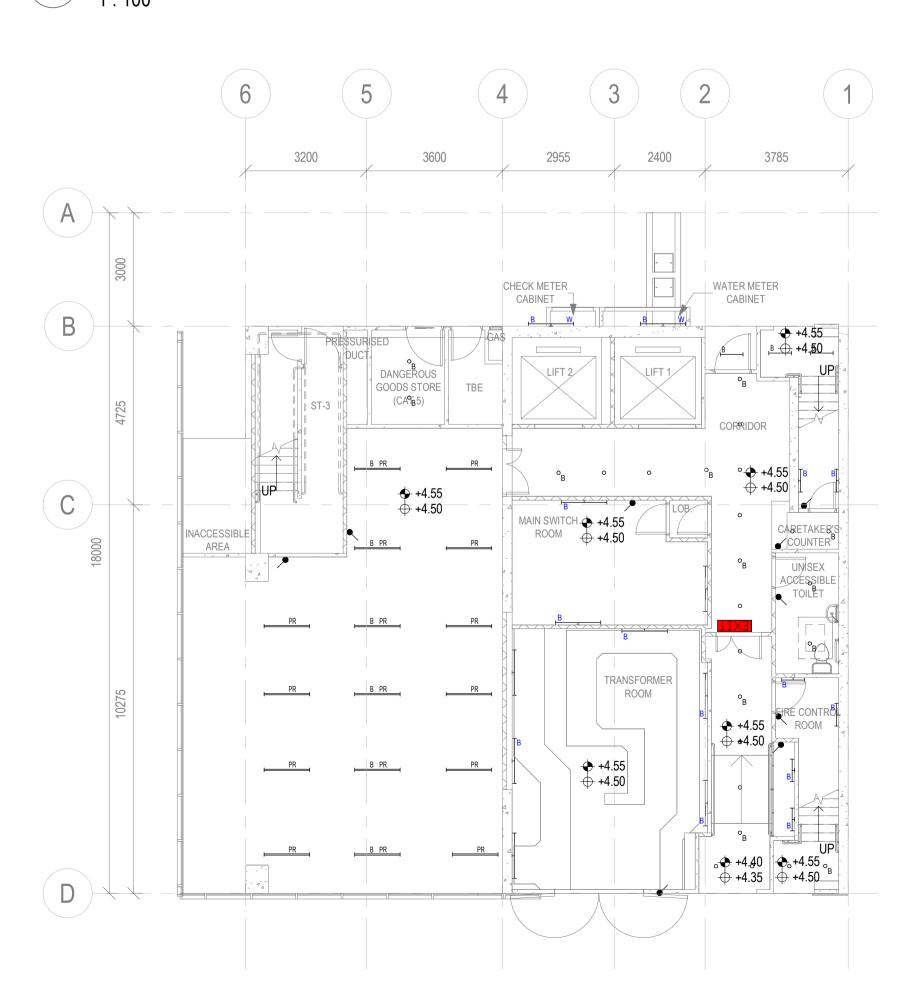

B.D.REFERENCE F.S.D.REFERENCE W.W.O.REFERENCE DO NOT SCALE DRAWINGS. ALL DIMENSIONS SHALL BE VERIFIED ON SITE. This is a simulated project aiming to include as

MEP drawings can be produced to illustrate the various drawing requirements and techniques. It shall be noted that professional MEP designs complying to prevailing regulations or design criteria are NOT the purpose of this drawing set and thus the provisions illustrated may appear to be

over provided or unreasonably located. Please do

many different MEP systems and provisions as possible within one sample building project so that

Blue colour stands for "Not directly generated by BIM system but by manual input"

not take the system designs as reference.

QR Code on drawing is an innovative idea to bridge between 2D drawings and 3D BIM model/2D BIM presentations when a Cloud Platform such as CDE is available.



CONSULTANT LOGO



DO NOT SCALE DRAWINGS. ALL DIMENSIONS SHALL BE VERIFIED ON SITE APPOINTING PARTY / CLIENT REVIEW & ACCEPT T - ACCEPTED (TIME)

A - REVIEWED & ACCEPTED B - REVIEWED & ACCEPTED WITH COMMENTS C - DO NOT USE

LEAD CONSULTANT / LEAD CONTRACTOR REVIEW & AUTHORISATION

A - REVIEWED & AUTHORISED

B - REVIEWED & AUTHORISED WITH COMMENTS C - DO NOT USE

1ST SUBMISSION

DATE DESCRIPTION NAME AND DESIGNATION DATE APPROVED DD/MM/YYYY CHECKED DD/MM/YYYY DESIGNED DESIGNER DD/MM/YYYY **BIM MODELLER** DD/MM/YYYY


08-03-2021


CIC SAMPLE PROJECT


LIGHTING LAYOUT PLAN AT LEVEL GF, L01, L02, L03

PXXXXX PURPOSE OF ISSUE PLANNING SUBMISSION DRAWING NO.

PXXXXX/EL103

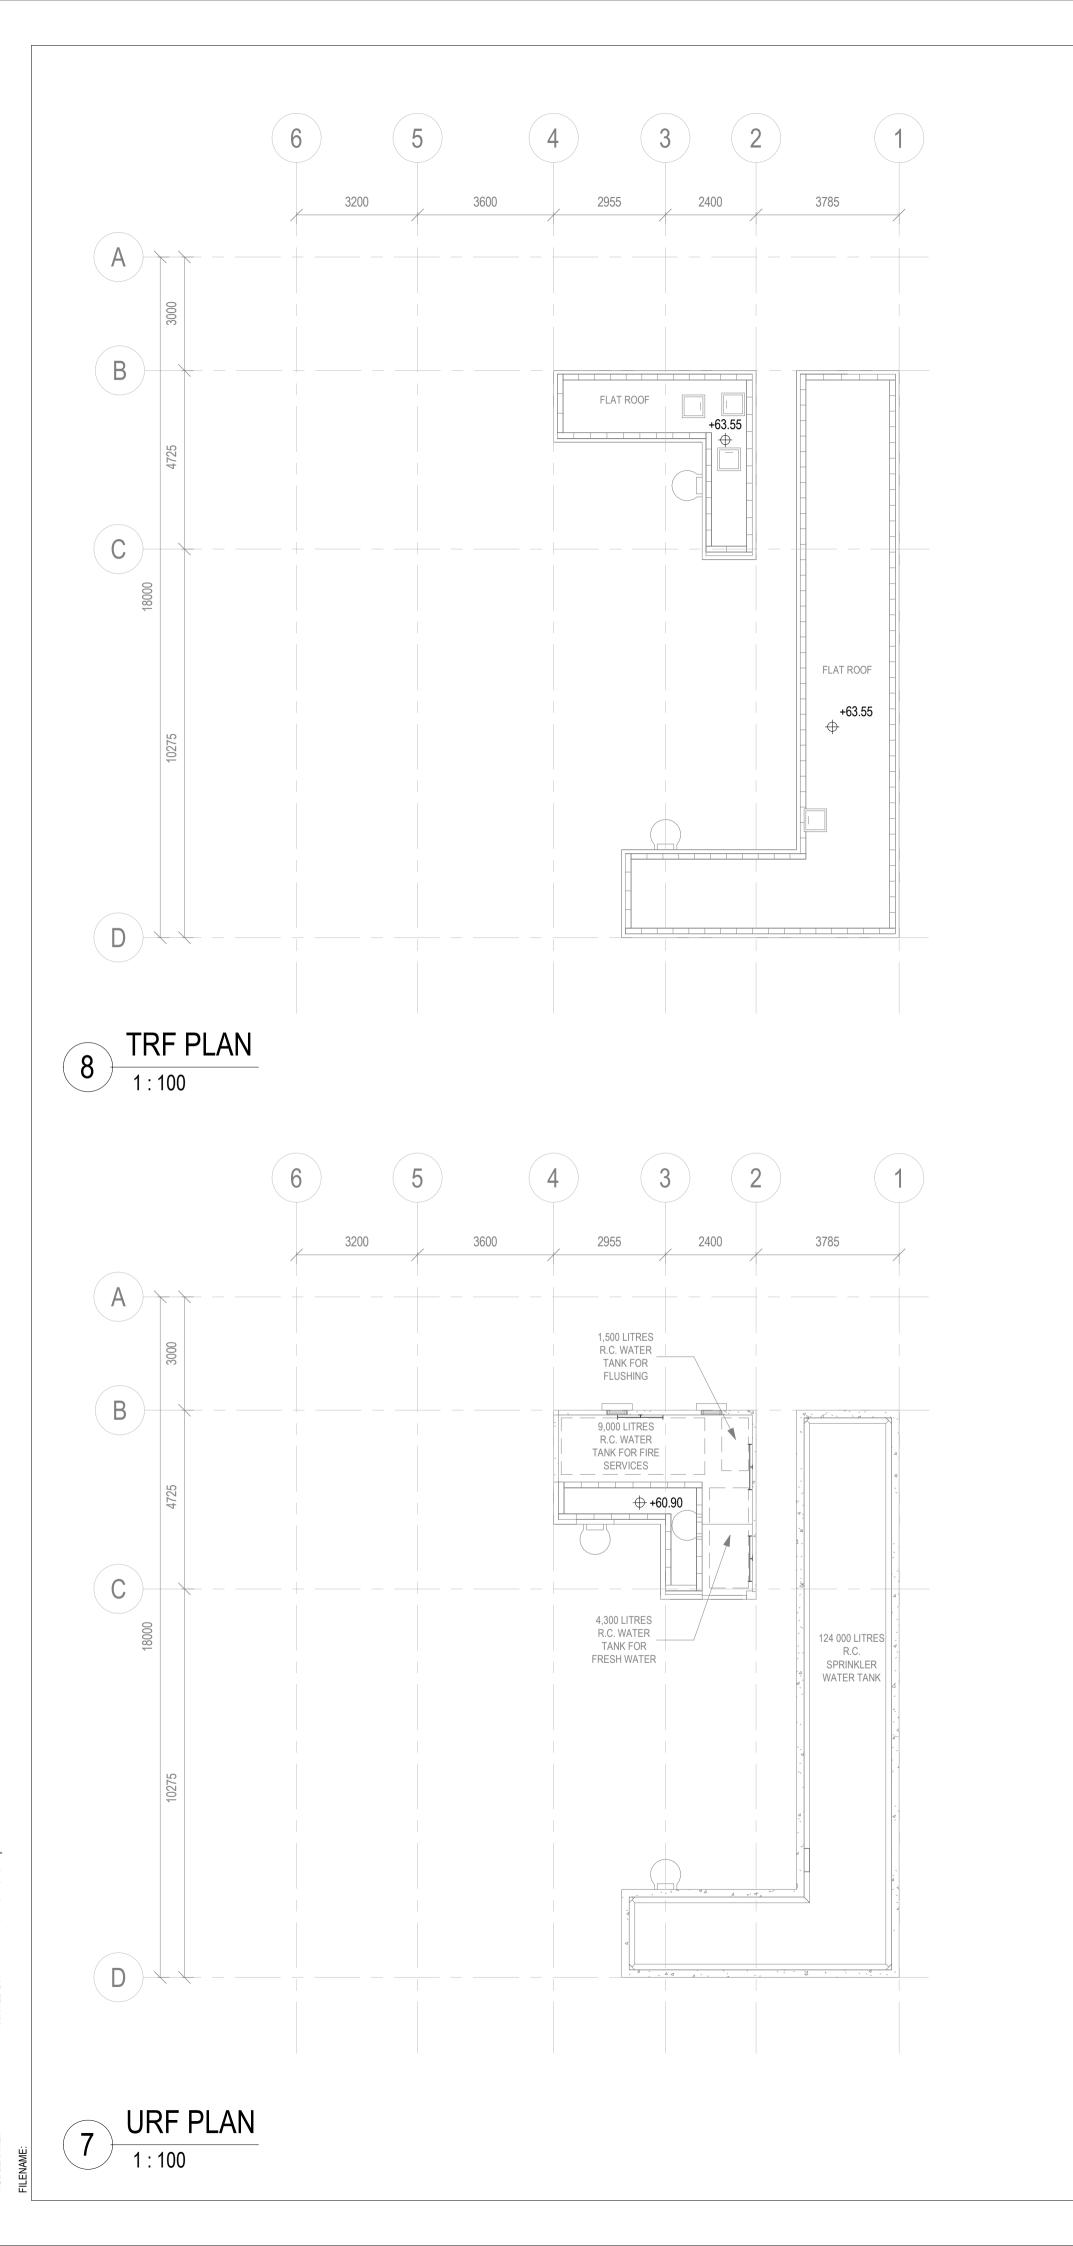

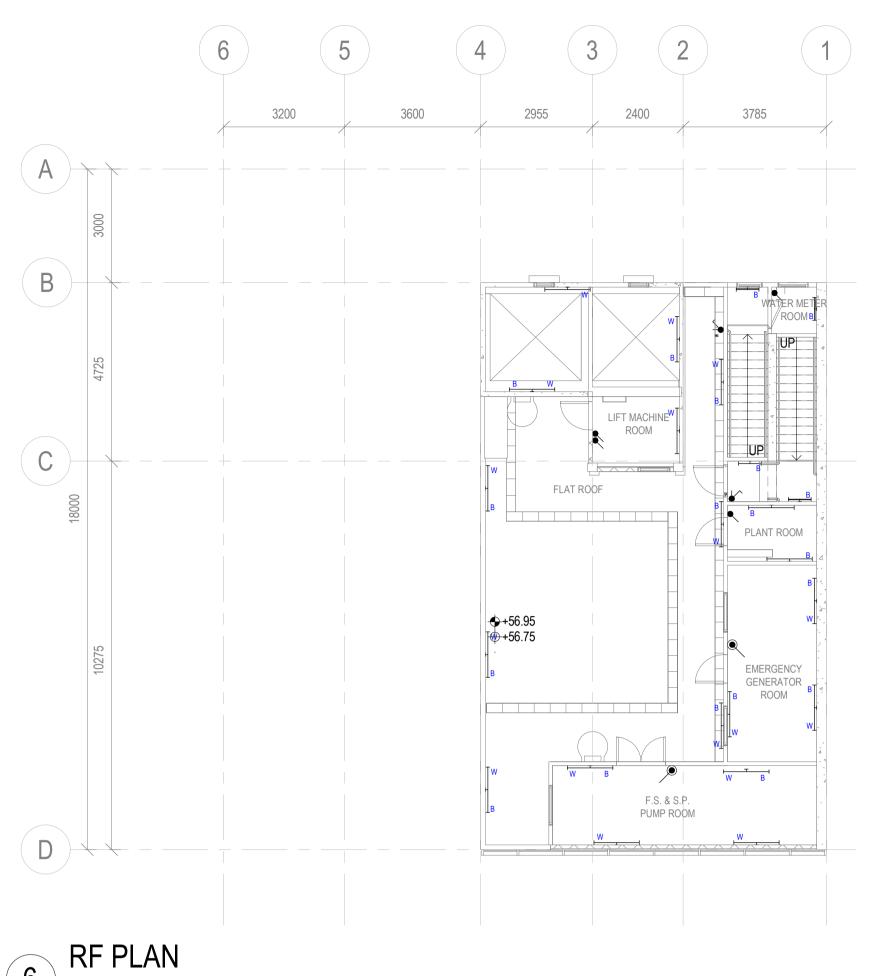

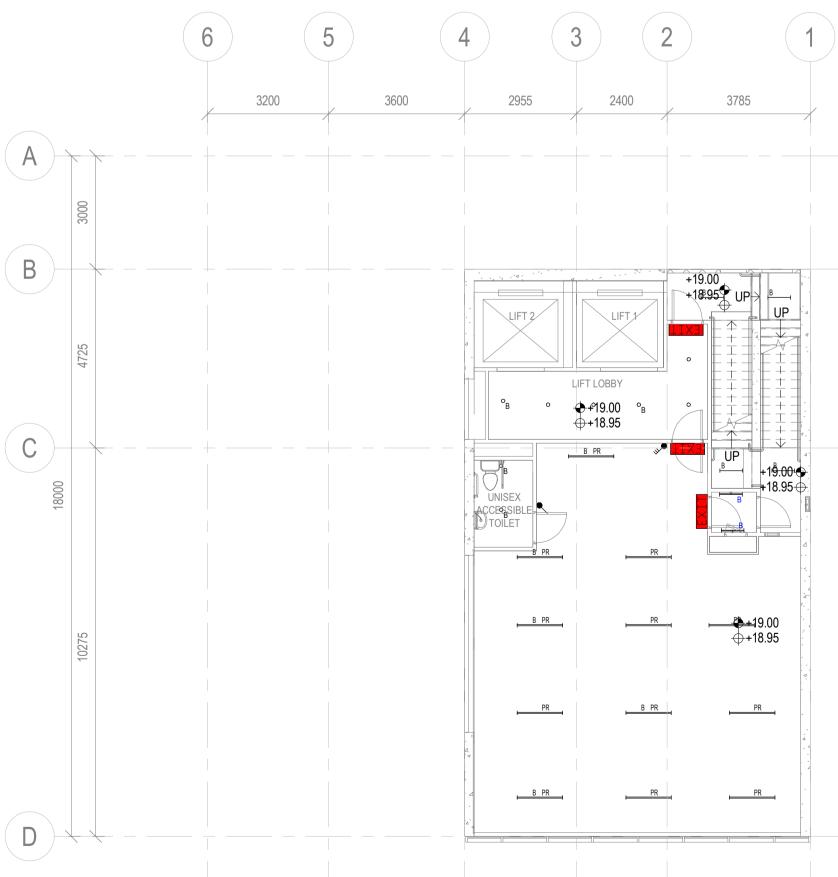

B.D.REFERENCE F.S.D.REFERENCE W.W.O.REFERENCE DO NOT SCALE DRAWINGS. ALL DIMENSIONS SHALL BE VERIFIED ON SITE. This is a simulated project aiming to include as many different MEP systems and provisions as possible within one sample building project so that MEP drawings can be produced to illustrate the various drawing requirements and techniques. It shall be noted that professional MEP designs complying to prevailing regulations or design criteria are NOT the purpose of this drawing set and thus the provisions illustrated may appear to be over provided or unreasonably located. Please do not take the system designs as reference. Blue colour stands for "Not directly generated by BIM system but by manual input" QR Code on drawing is an innovative idea to bridge between 2D drawings and 3D BIM model/2D BIM presentations when a Cloud Platform such as CDE is available. CLIENT LOGO CONSTRUCTION INDUSTRY COUNCIL 建造業議會 CONSULTANT LOGO CONSTRUCTION INDUSTRY COUNCIL 建造業議會 DO NOT SCALE DRAWINGS. ALL DIMENSIONS SHALL BE VERIFIED ON SITE APPOINTING PARTY / CLIENT REVIEW & ACCEPT T - ACCEPTED (TIME) A - REVIEWED & ACCEPTED B - REVIEWED & ACCEPTED WITH COMMENTS C - DO NOT USE LEAD CONSULTANT / LEAD CONTRACTOR REVIEW & AUTHORISATION A - REVIEWED & AUTHORISED B - REVIEWED & AUTHORISED WITH COMMENTS C - DO NOT USE DATE ID 1ST SUBMISSION APPROVED CHECKED CHECKER DESIGNED DESIGNER DRAWN BIM MODELLER


08-03-2021 DATE DESCRIPTION NAME AND DESIGNATION DATE DD/MM/YYYY DD/MM/YYYY DD/MM/YYYY DD/MM/YYYY

CIC SAMPLE PROJECT


LIGHTING LAYOUT PLAN AT LEVEL L04-L15, RF, URF, TRF

PXXXXX PURPOSE OF ISSUE PLANNING SUBMISSION DRAWING NO.

PXXXXX/EL104

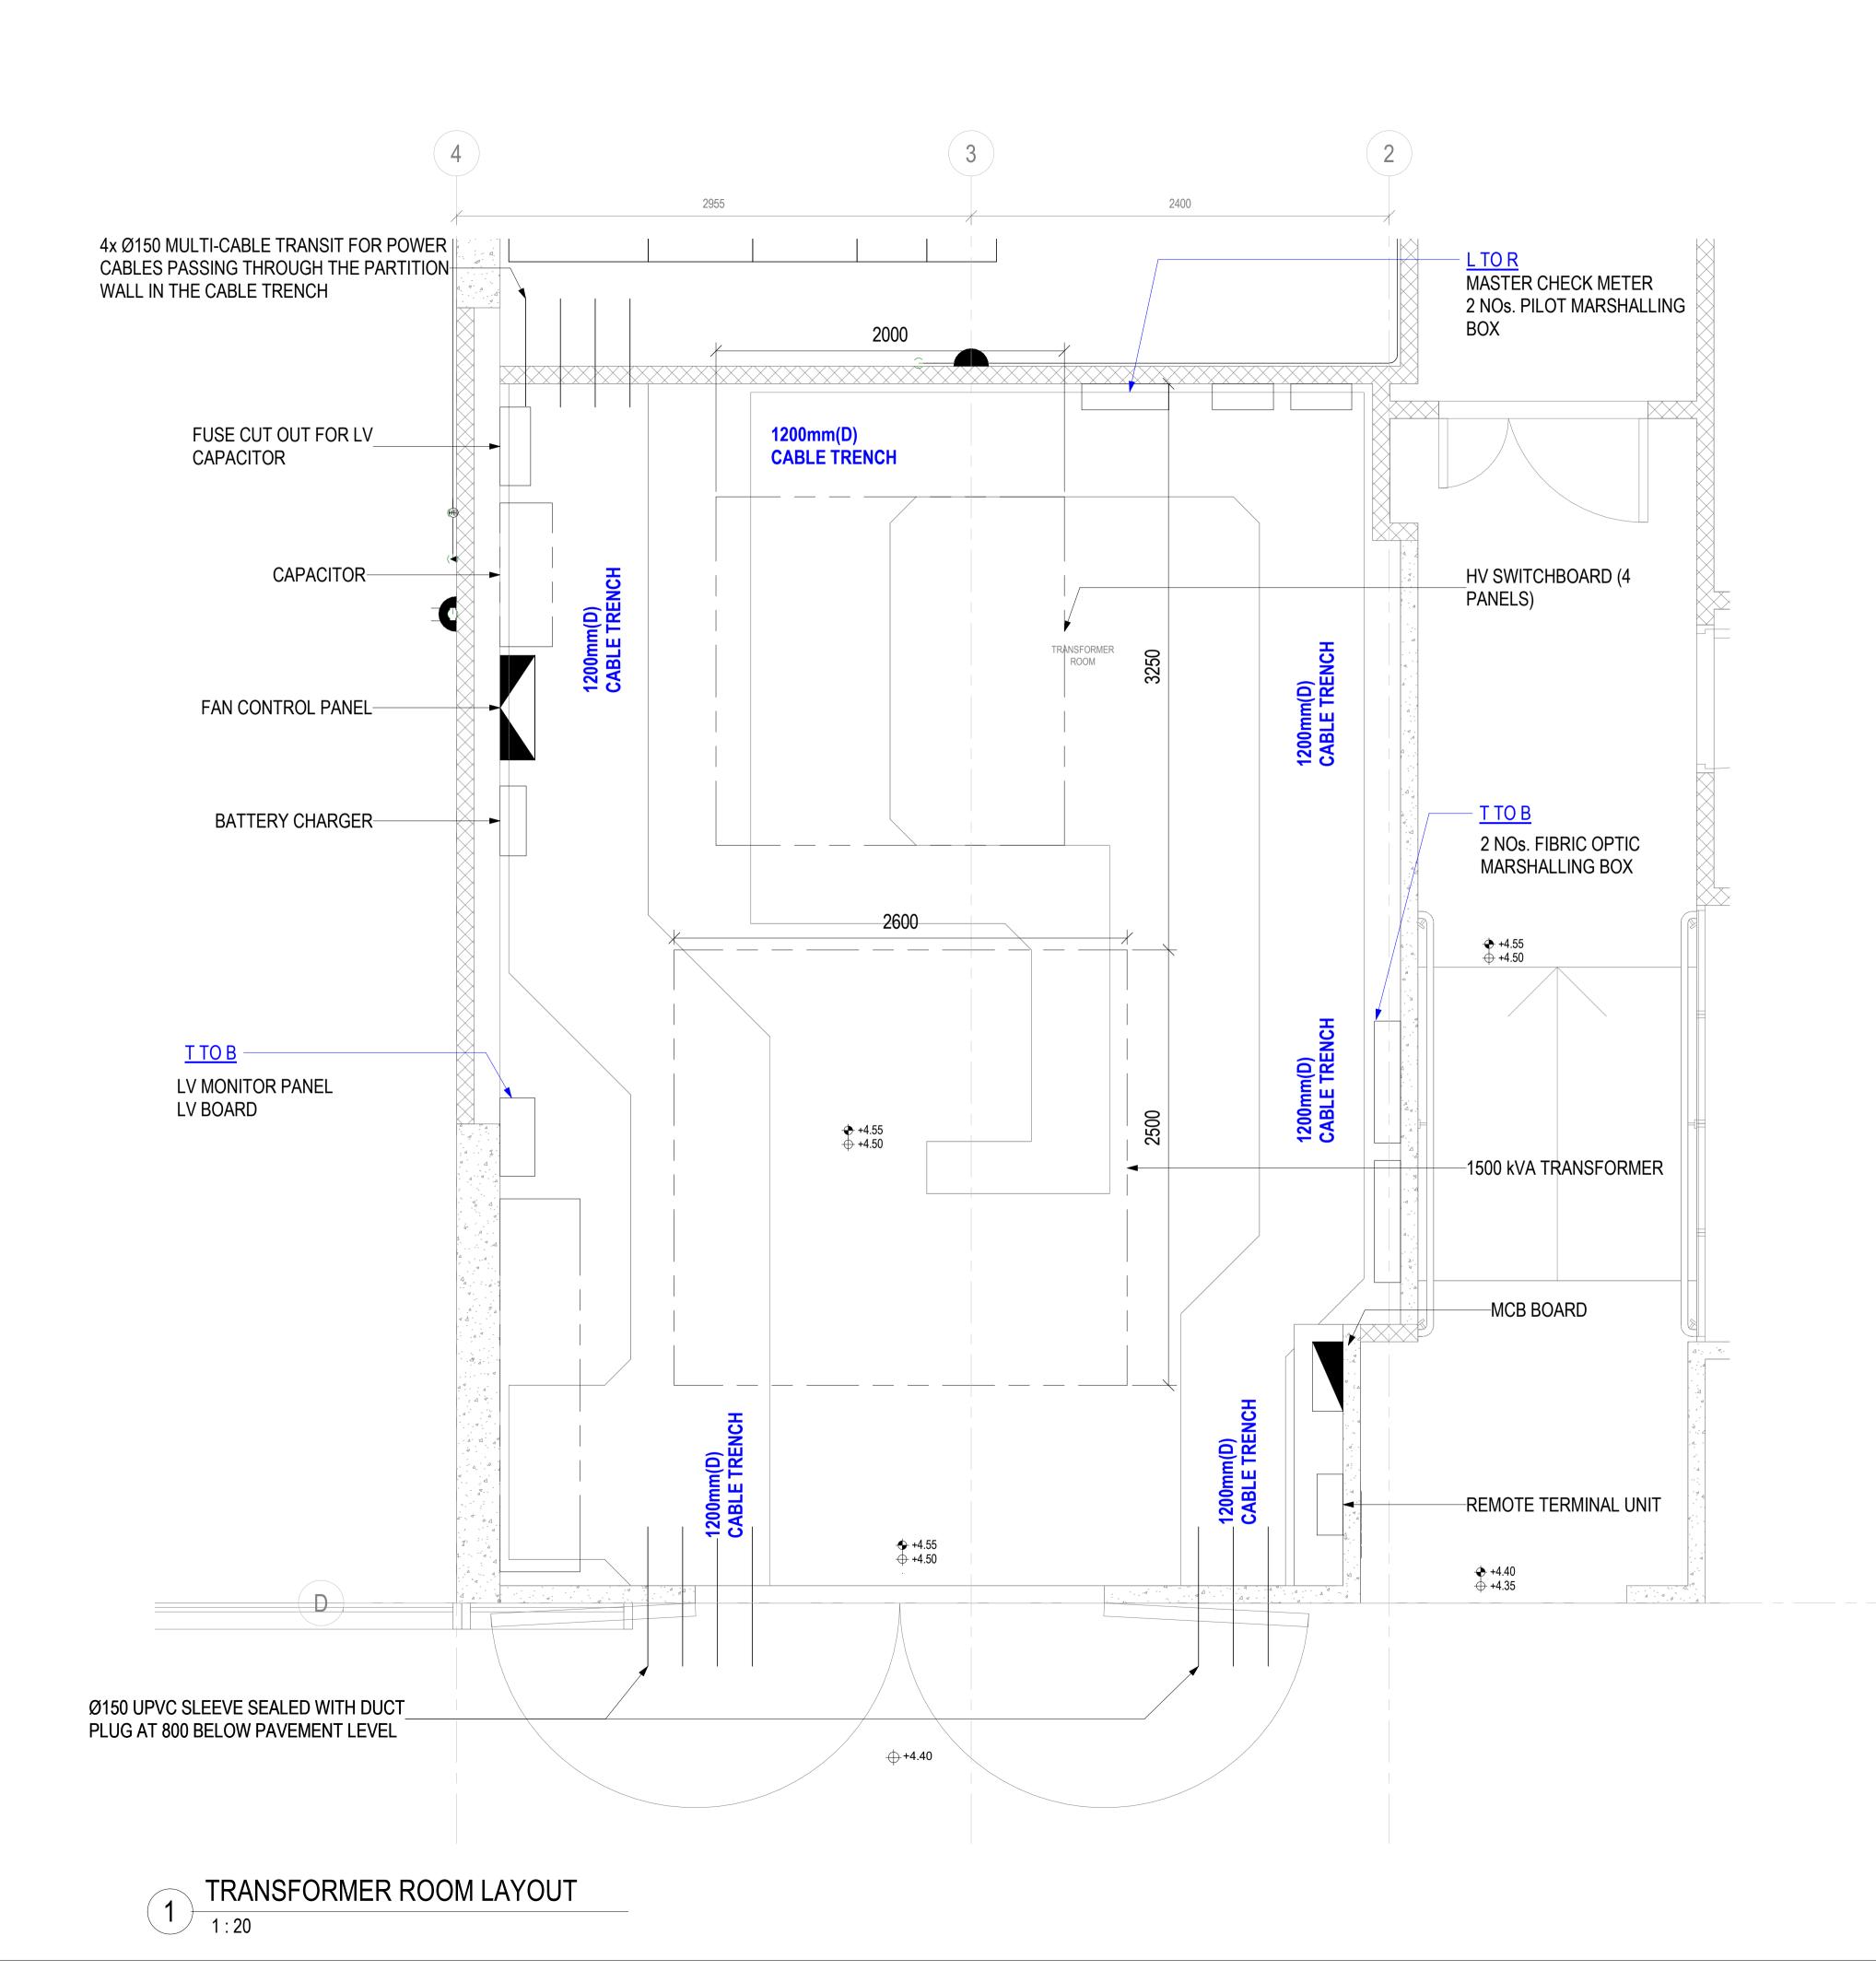

B.D.REFERENCE F.S.D.REFERENCE W.W.O.REFERENCE DO NOT SCALE DRAWINGS. ALL DIMENSIONS SHALL BE VERIFIED ON SITE. This is a simulated project aiming to include as many different MEP systems and provisions as possible within one sample building project so that MEP drawings can be produced to illustrate the various drawing requirements and techniques. It shall be noted that professional MEP designs complying to prevailing regulations or design criteria are NOT the purpose of this drawing set and thus the provisions illustrated may appear to be over provided or unreasonably located. Please do not take the system designs as reference. Blue colour stands for "Not directly generated by BIM system but by manual input" QR Code on drawing is an innovative idea to bridge between 2D drawings and 3D BIM model/2D BIM presentations when a Cloud Platform such as CDE is available. CLIENT LOGO CONSTRUCTION INDUSTRY COUNCIL 建造業議會 CONSTRUCTION INDUSTRY COUNCIL 建造業議會 DO NOT SCALE DRAWINGS. ALL DIMENSIONS SHALL BE VERIFIED ON SITE. APPOINTING PARTY / CLIENT REVIEW & ACCEPT T - ACCEPTED (TIME) A - REVIEWED & ACCEPTED B - REVIEWED & ACCEPTED WITH COMMENTS C - DO NOT USE LEAD CONSULTANT / LEAD CONTRACTOR REVIEW & AUTHORISATION A - REVIEWED & AUTHORISED B - REVIEWED & AUTHORISED WITH COMMENTS C - DO NOT USE 08-03-2021 DATE DESCRIPTION NAME AND DESIGNATION APPROVED APPROVER DESIGNED DESIGNER **BIM MODELLER** CIC SAMPLE PROJECT TRANSFORMER ROOM LAYOUT AT LEVEL GF PURPOSE OF ISSUE PLANNING SUBMISSION DRAWING NO. PXXXXX/EL400

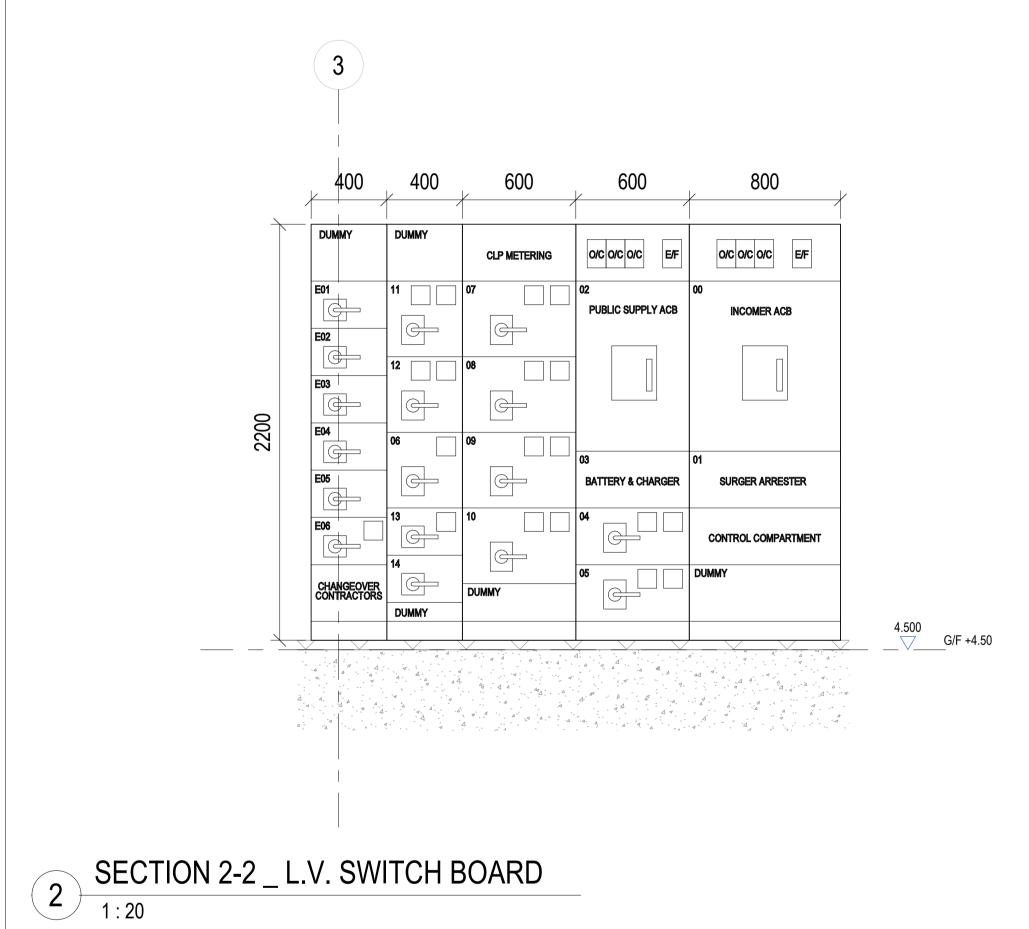

GFNPM GFNP GFEP TFNN

MAN SWITCH

ROCM

LUB.


LU


1 MAIN SWTICH ROOM PART PLAN

B.D.REFERENCE F.S.D.REFERENCE W.W.O.REFERENCE DO NOT SCALE DRAWINGS. ALL DIMENSIONS SHALL BE VERIFIED ON SITE. This is a simulated project aiming to include as many different MEP systems and provisions as possible within one sample building project so that MEP drawings can be produced to illustrate the various drawing requirements and techniques. It shall be noted that professional MEP designs complying to prevailing regulations or design criteria are NOT the purpose of this drawing set and thus the provisions illustrated may appear to be over provided or unreasonably located. Please do not take the system designs as reference. Blue colour stands for "Not directly generated by BIM system but by manual input" QR Code on drawing is an innovative idea to bridge between 2D drawings and 3D BIM model/2D BIM presentations when a Cloud Platform such as CDE is available. CONSTRUCTION INDUSTRY COUNCIL 建造業議會 CONSULTANT LOGO CONSTRUCTION INDUSTRY COUNCIL 建造業議會 DO NOT SCALE DRAWINGS. ALL DIMENSIONS SHALL BE VERIFIED ON SITE. APPOINTING PARTY / CLIENT REVIEW & ACCEPT T - ACCEPTED (TIME) A - REVIEWED & ACCEPTED B - REVIEWED & ACCEPTED WITH COMMENTS C - DO NOT USE LEAD CONSULTANT / LEAD CONTRACTOR REVIEW & AUTHORISATION A - REVIEWED & AUTHORISED B - REVIEWED & AUTHORISED WITH COMMENTS C - DO NOT USE DATE 1ST SUBMISSION 08-03-2021 DESCRIPTION DATE NAME AND DESIGNATION DATE APPROVED APPROVER CHECKED DESIGNED DESIGNER **BIM MODELLER** CIC SAMPLE PROJECT L.V. SWITCH ROOM LAYOUT AT LEVEL GF PURPOSE OF ISSUE PLANNING SUBMISSION

DRAWING NO.

PXXXXX/EL401

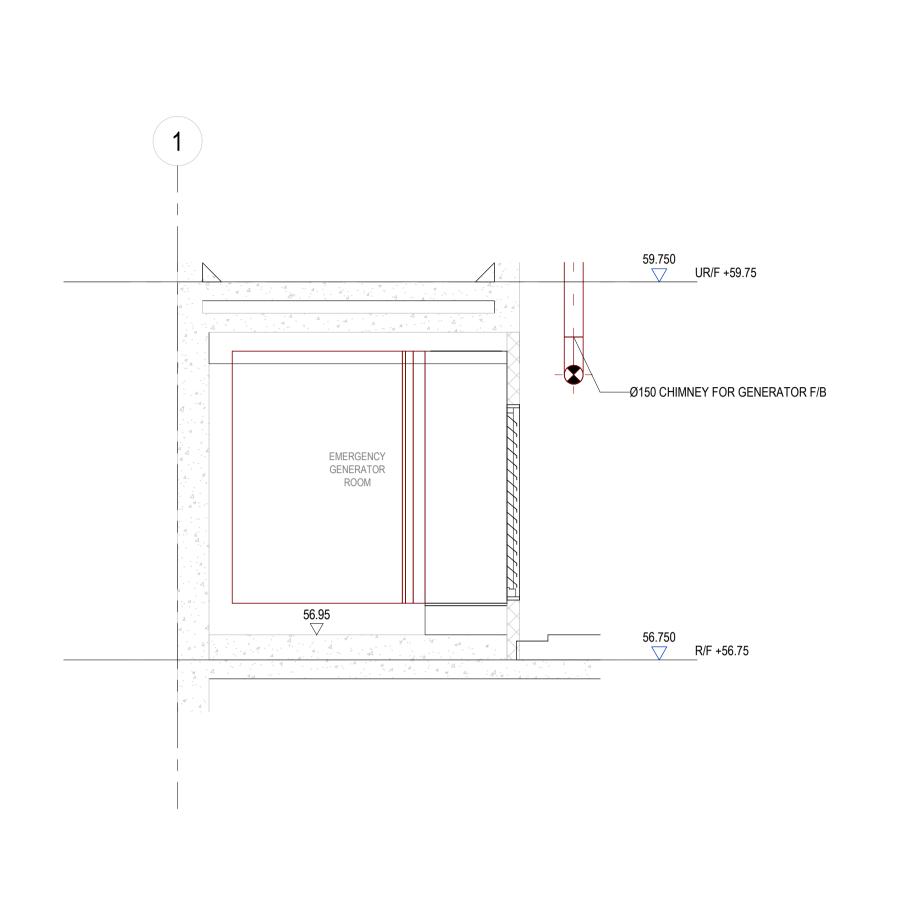


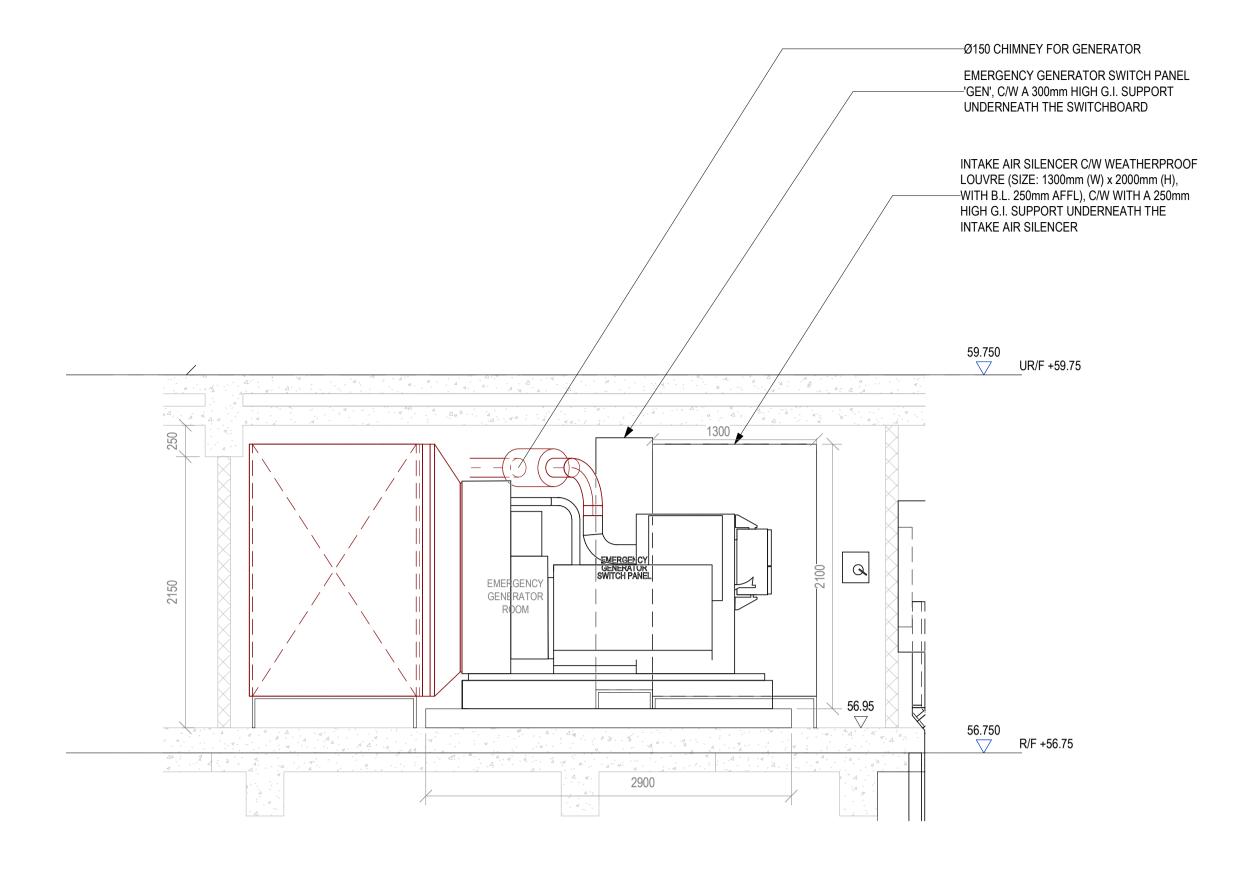



SECTION 5-5 _ EMERGENCY GENERATOR ROOM

SECTION 4-4 _ EMERGENCY GENERATOR ROOM

1:30

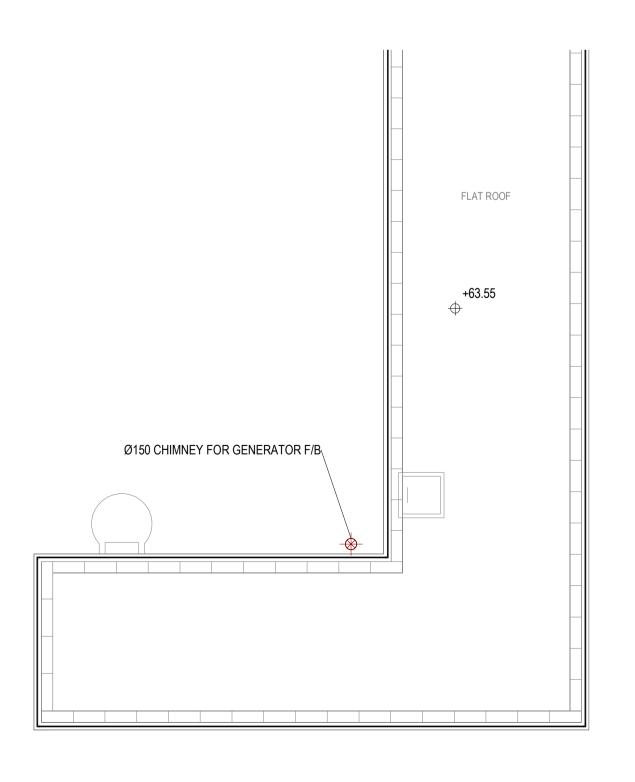

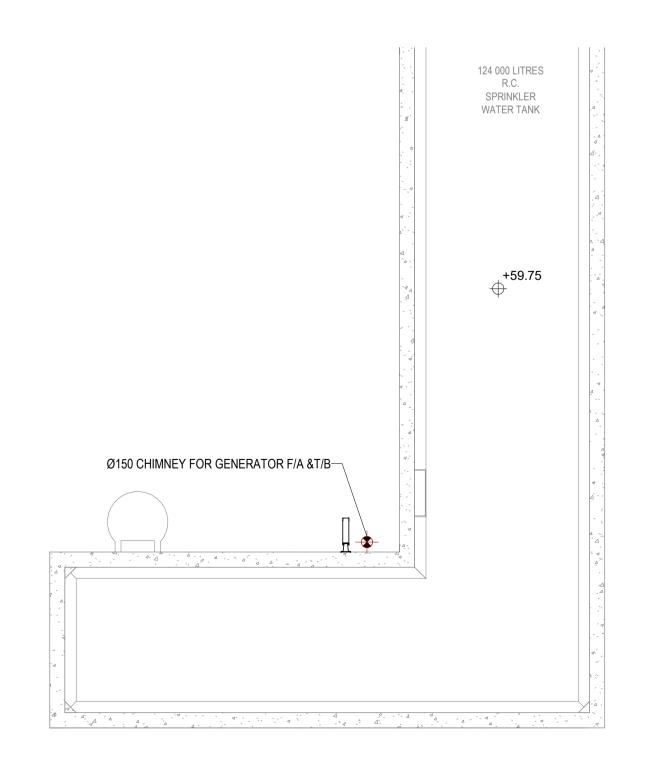

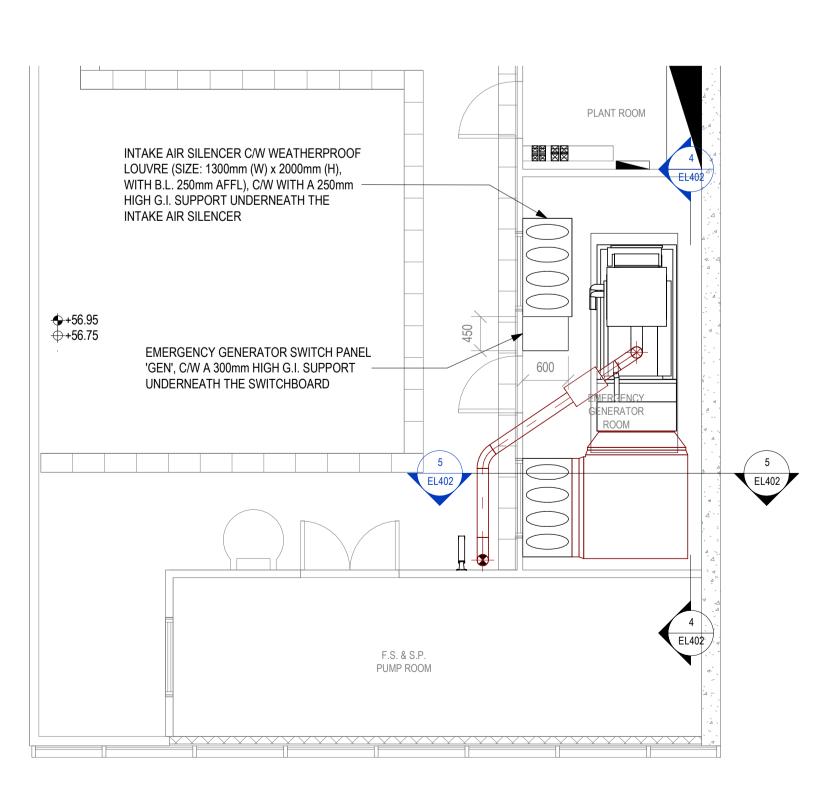

B.D.REFERENCE F.S.D.REFERENCE W.W.O.REFERENCE DO NOT SCALE DRAWINGS. ALL DIMENSIONS SHALL BE VERIFIED ON SITE. This is a simulated project aiming to include as many different MEP systems and provisions as possible within one sample building project so that MEP drawings can be produced to illustrate the various drawing requirements and techniques. It shall be noted that professional MEP designs complying to prevailing regulations or design criteria are NOT the purpose of this drawing set and thus the provisions illustrated may appear to be over provided or unreasonably located. Please do not take the system designs as reference. Blue colour stands for "Not directly generated by BIM system but by manual input" QR Code on drawing is an innovative idea to bridge between 2D drawings and 3D BIM model/2D BIM presentations when a Cloud Platform such as CDE is available. CLIENT LOGO CONSTRUCTION

INDUSTRY COUNCIL 建造業議會

CONSULTANT LOGO



DO NOT SCALE DRAWINGS. ALL DIMENSIONS SHALL BE VERIFIED ON SITE APPOINTING PARTY / CLIENT REVIEW & ACCEPT

T - ACCEPTED (TIME) A - REVIEWED & ACCEPTED B - REVIEWED & ACCEPTED WITH COMMENTS C - DO NOT USE

LEAD CONSULTANT / LEAD CONTRACTOR REVIEW &

AUTHORISATION A - REVIEWED & AUTHORISED B - REVIEWED & AUTHORISED WITH COMMENTS

C - DO NOT USE

1ST SUBMISSION 08-03-2021 DATE DESCRIPTION NAME AND DESIGNATION APPROVED APPROVER CHECKED CHECKER


DESIGNED DESIGNER **BIM MODELLER**

CIC SAMPLE PROJECT

EMERGENCY GENERATOR ROOM LAYOUT AND SECTIONAL DETAILS

PURPOSE OF ISSUE
PLANNING SUBMISSION DRAWING NO.

PXXXXX/EL402

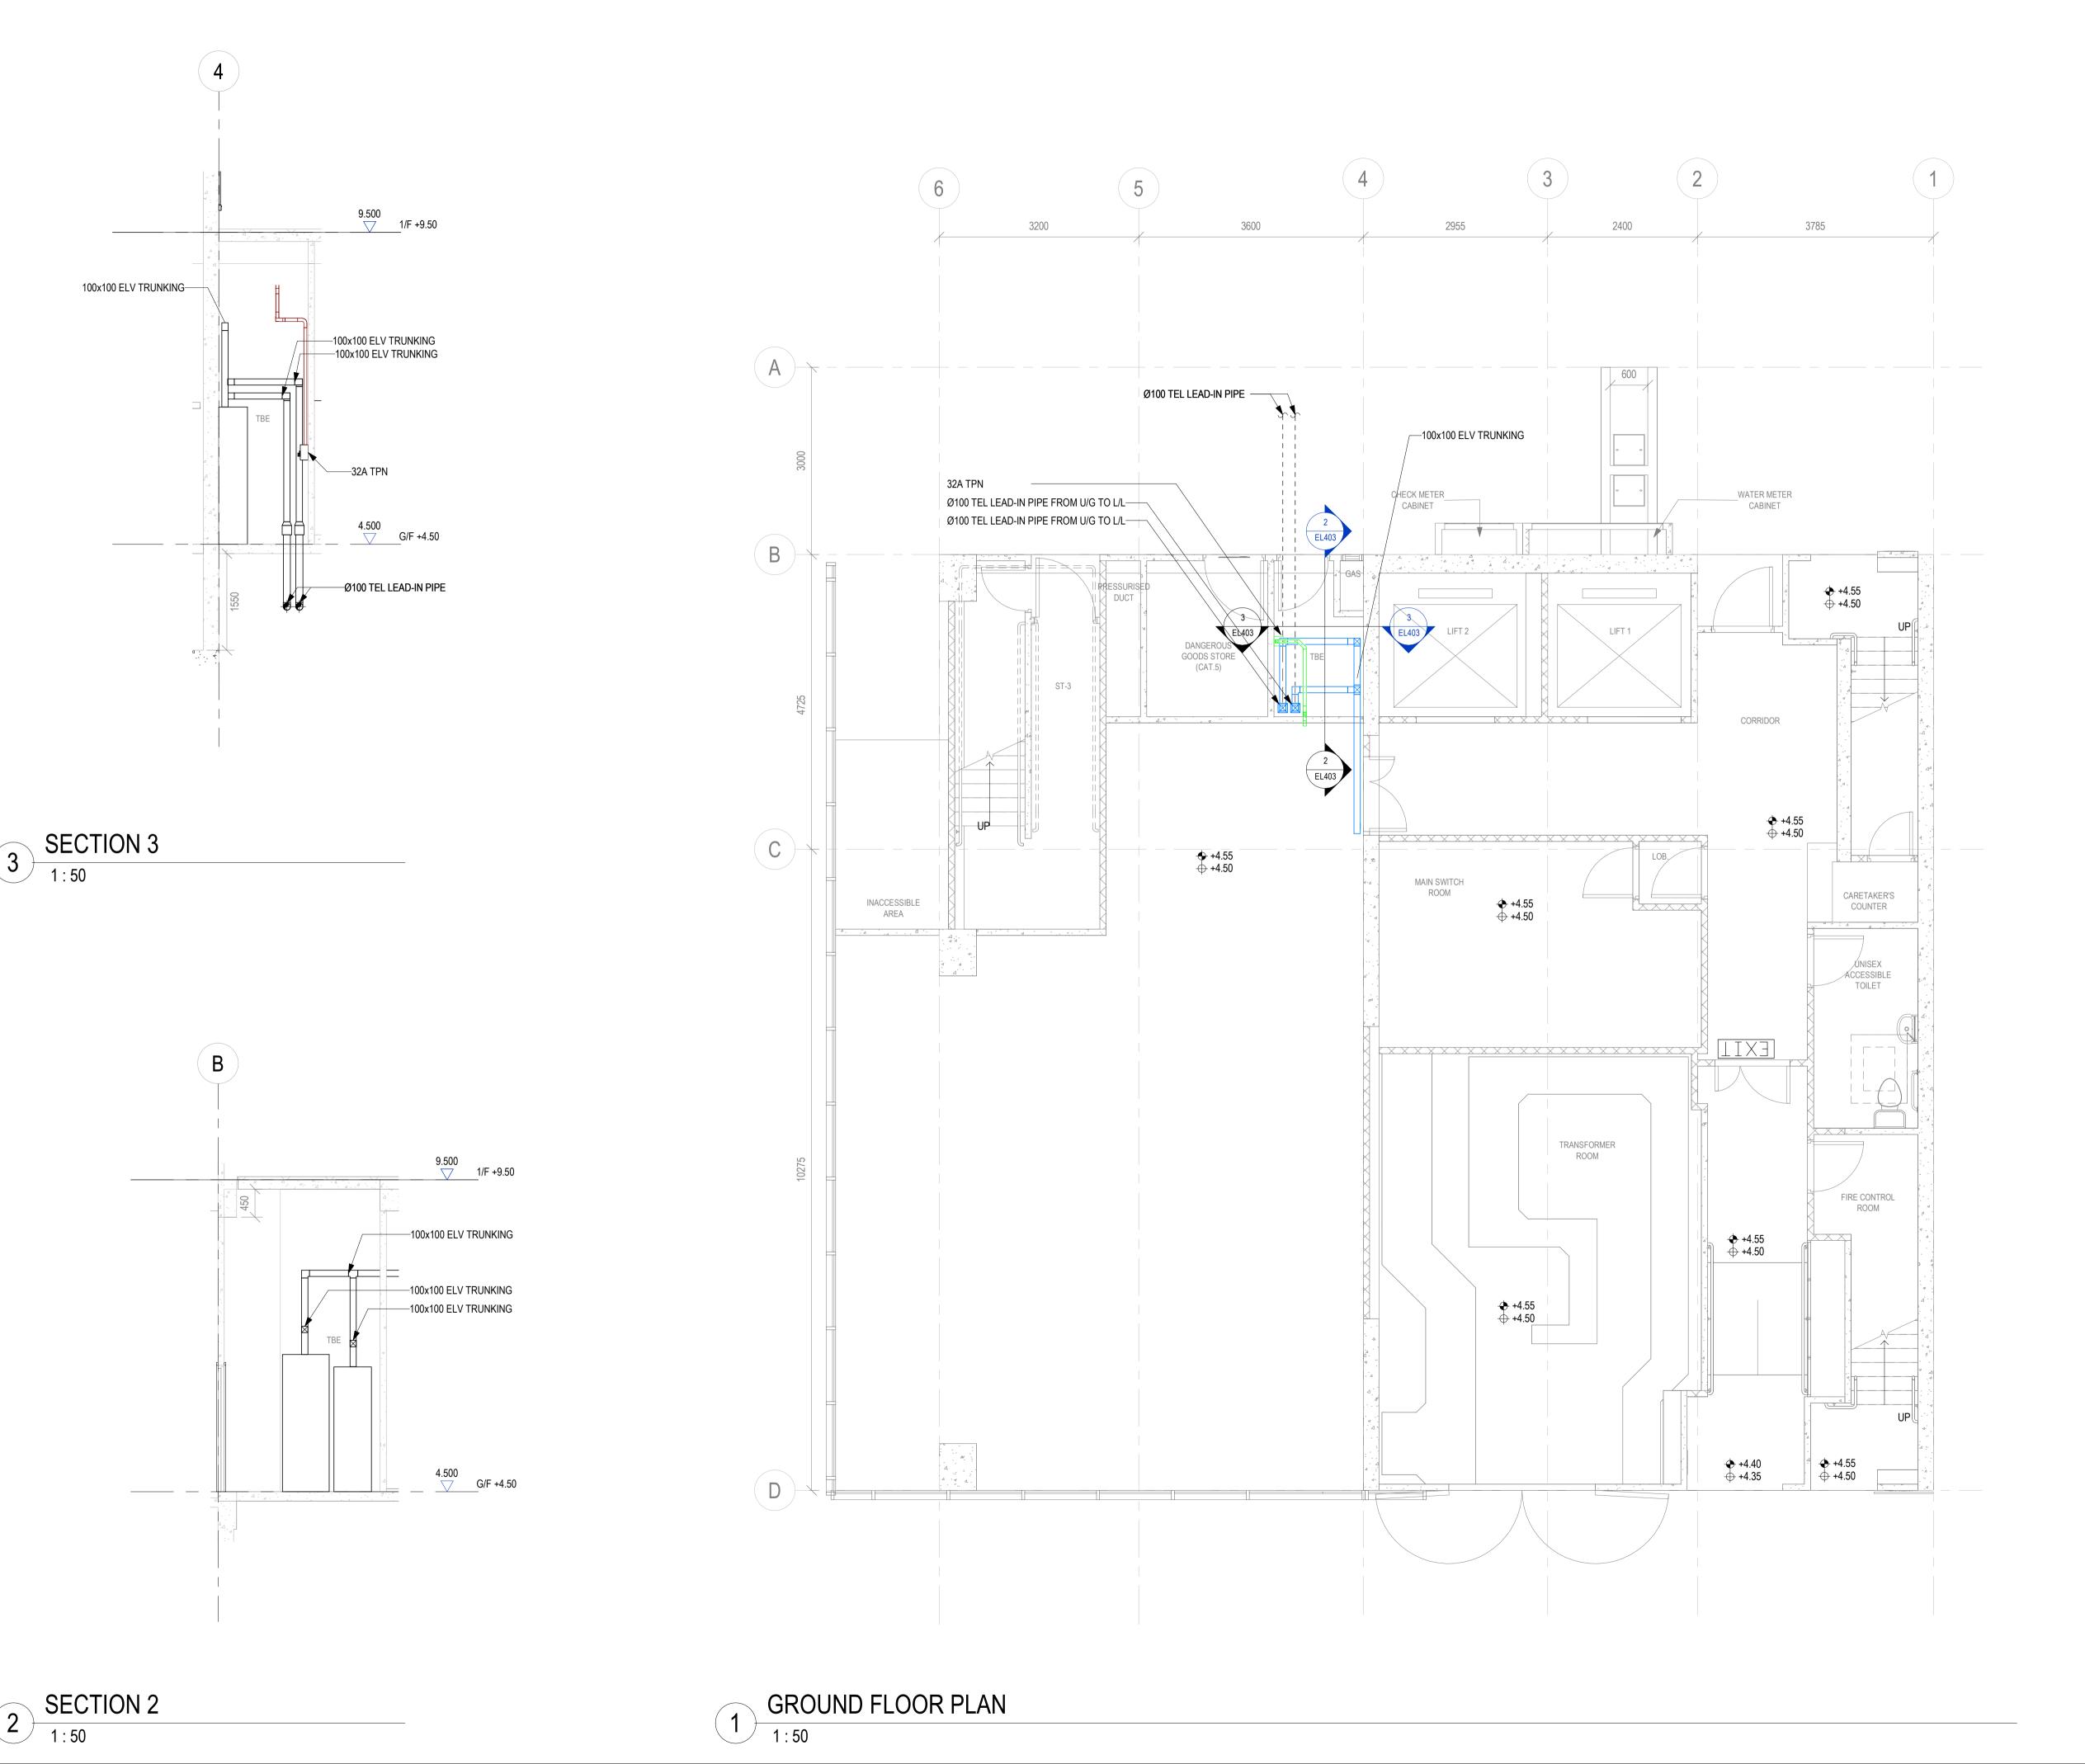

B.D.REFERENCE F.S.D.REFERENCE W.W.O.REFERENCE DO NOT SCALE DRAWINGS. ALL DIMENSIONS SHALL BE VERIFIED ON SITE. This is a simulated project aiming to include as many different MEP systems and provisions as possible within one sample building project so that MEP drawings can be produced to illustrate the various drawing requirements and techniques. It shall be noted that professional MEP designs complying to prevailing regulations or design criteria are NOT the purpose of this drawing set and thus the provisions illustrated may appear to be over provided or unreasonably located. Please do not take the system designs as reference. Blue colour stands for "Not directly generated by BIM system but by manual input" QR Code on drawing is an innovative idea to bridge between 2D drawings and 3D BIM model/2D BIM presentations when a Cloud Platform such as CDE is available. CLIENT LOGO CONSTRUCTION INDUSTRY COUNCIL 建造業議會 CONSULTANT LOGO CONSTRUCTION INDUSTRY COUNCIL 建造業議會 DO NOT SCALE DRAWINGS. ALL DIMENSIONS SHALL BE VERIFIED ON SITE APPOINTING PARTY / CLIENT REVIEW & ACCEPT T - ACCEPTED (TIME) A - REVIEWED & ACCEPTED B - REVIEWED & ACCEPTED WITH COMMENTS C - DO NOT USE LEAD CONSULTANT / LEAD CONTRACTOR REVIEW & AUTHORISATION A - REVIEWED & AUTHORISED B - REVIEWED & AUTHORISED WITH COMMENTS C - DO NOT USE 1ST SUBMISSION 08-03-2021 DATE DESCRIPTION NAME AND DESIGNATION DATE APPROVED APPROVER CHECKED DESIGNED DESIGNER **BIM MODELLER** CIC SAMPLE PROJECT TBE ROOM LAYOUT AT LEVEL GF PXXXXX PURPOSE OF ISSUE PLANNING SUBMISSION DRAWING NO. PXXXXX/EL403

PRINTED BY: 11/11/2021


PLOT DRV:
MODELNAME:


GENERAL NOTES

- ALL DIMENSION OF OPENINGS THROUGH STRUCTURE FOR HALL BUTTONS, HALL INDICATOR ETC... SHALL BE PROVIDED BY LIFT CONT'R IT IS THE RESPONSIBILITY OF THE LIFT CONT'R TO TAKE MEASURES TO ENSURE THAT THE POWER FACTOR OF THE INSTALLATION SHALL NOT BE LESS THAN 0.85 LAGGING AT ALL CONDITIONS OF OPERATION IN THE EVENT OF NORMAL TNB POWER SUPPLY FAILURE, SUPPLY WILL BE AVAILABLE FROM STANDBY GENERATOR SET AND LIFT CONTROL SEQUENCE SHALL BE AS SCHEDULED UNDER:
 - ON THE AVAILABILITY OF EMERGENCY GENSET SUPPLY REGARDLESS OF LOCATION OF THE LIFT, IT SHALL BE BROUGHT DOWN FIRST TO THE LOWEST DISCHARGE FLOOR AND SHALL BE AVAILABLE FOR USE BY THE FIREMAN SEQUENTIALLY FOR 50% OF LIFTS IN EACH COREIN SIMULTANEOUSLY
 - IN THE EVENT OF FIRE & TNB FAILURE, ALL THE LIFTS SHALL BE

- A MILD STEEL CAT LADDER SHALL BE PROVIDED IN EACH OF THE LIFT PIT FOR MAINTENANCE PURPOSES BY THE LIFT SUPPLIER.
- THE ENTRANCE DOOR OF LIFT MOTOR ROOM SHALL BE **EXHIBITED A NOTICE AS FOLLOWS:-**
- " DANGEROUS
- MACHINERY ROOM ONLY AUTHORIZED PERSONNEL ALLOWED "
- 2x36W FLUORESCENT SURFACE MOUNTED C/W WEATHERPROOF POLYCARBONATE COVER (LTG) AND 13A SPN 240V FLUSH METALCALD S/S/O (SP) WITH CABLING IN CONDUIT/TRUNKING FROM LIFT MOTOR ROOM DB (BY LIFT CONTRACTOR)
- ALL LIFT SHALL BE AC VARIABLE VOLTAGE VARIABLE FREQUENCY (ACVVF) GEARED TYPE
- ALL LIFT DOOR OPENING AND CLOSING SPEED SHALL NOT BE LESS THAN 2.2m/s AND SHALL COMPLY TO SAFETY REQUIREMENTS

	DRAWING LIST_EMS	
DRAWING NUMBER	DRAWING TITLE	REVISION
EMS001	GENERAL NOTES, LEGENDS, ABBREVIATION AND DRAWING LIST	0
EMS101	L&S LAYOUT PLAN AT LEVEL GF, L01, L02, L03	0
EMS102	L&S LAYOUT PLAN AT L04-L15, RF, URF, TRF	0
EMS400	LIFT SHAFT PLAN DETAIL & SECTION	0

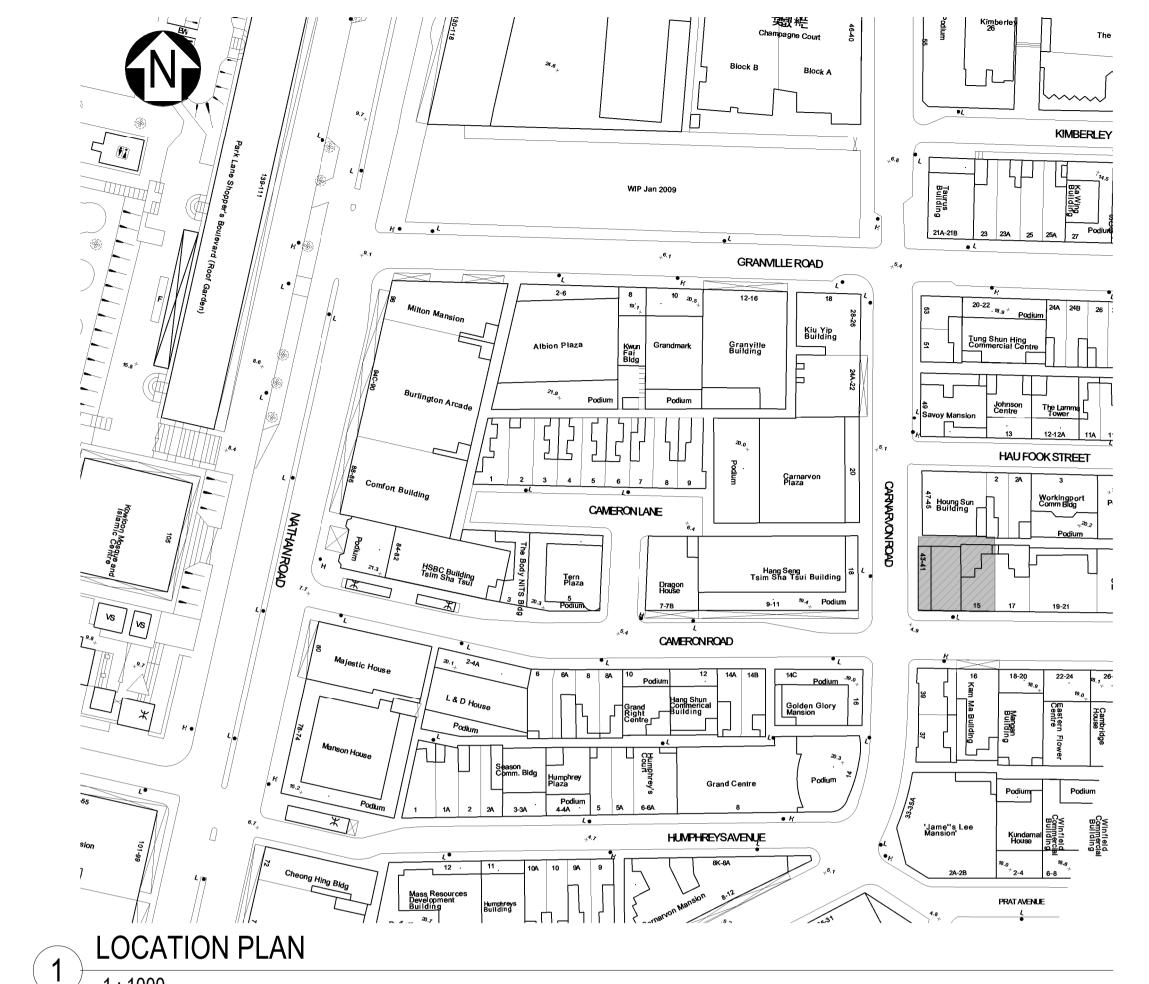

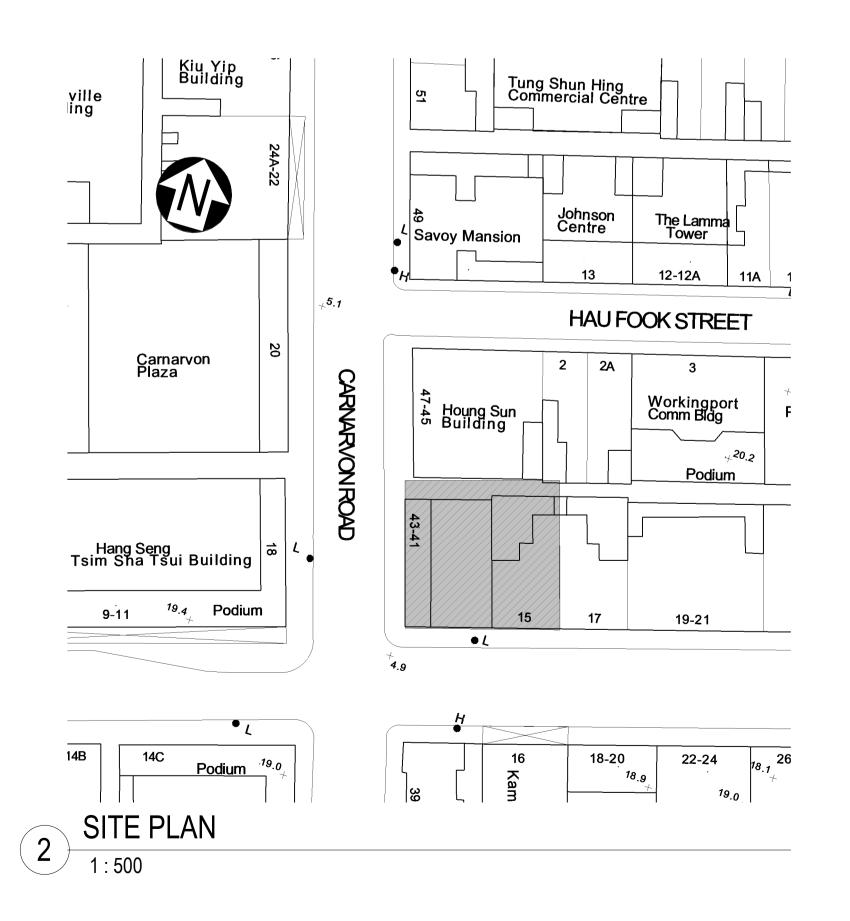

B.D.REFERENCE F.S.D.REFERENCE W.W.O.REFERENCE

This is a simulated project aiming to include as many different MEP systems and provisions as possible within one sample building project so that MEP drawings can be produced to illustrate the various drawing requirements and techniques.

DO NOT SCALE DRAWINGS. ALL DIMENSIONS SHALL BE VERIFIED ON SITE.

It shall be noted that professional MEP designs complying to prevailing regulations or design criteria are NOT the purpose of this drawing set and thus the provisions illustrated may appear to be over provided or unreasonably located. Please do not take the system designs as reference.

Blue colour stands for "Not directly generated by BIM system but by manual input"

QR Code on drawing is an innovative idea to bridge between 2D drawings and 3D BIM model/2D BIM presentations when a Cloud Platform such as CDE is available.



CONSULTANT LOGO CONSTRUCTION INDUSTRY COUNCIL 建造業議會

DO NOT SCALE DRAWINGS. ALL DIMENSIONS SHALL BE VERIFIED ON SITE APPOINTING PARTY / CLIENT REVIEW & ACCEPT

T - ACCEPTED (TIME) A - REVIEWED & ACCEPTED B - REVIEWED & ACCEPTED WITH COMMENTS C - DO NOT USE

LEAD CONSULTANT / LEAD CONTRACTOR REVIEW & AUTHORISATION

A - REVIEWED & AUTHORISED B - REVIEWED & AUTHORISED WITH COMMENTS C - DO NOT USE

DATE ID


1ST SUBMISSION 08-03-2021 DESCRIPTION DATE NAME AND DESIGNATION DATE DD/MM/YYYY APPROVED CHECKED DD/MM/YYYY CHECKER DESIGNER DD/MM/YYYY DESIGNED BIM MODELLER DD/MM/YYYY

CIC SAMPLE PROJECT

GENERAL NOTES, LEGENDS, ABBREVIATION AND DRAWING LIST

PURPOSE OF ISSUE
PLANNING SUBMISSION As indicated A1 DRAWING NO.

PXXXXX/EMS001

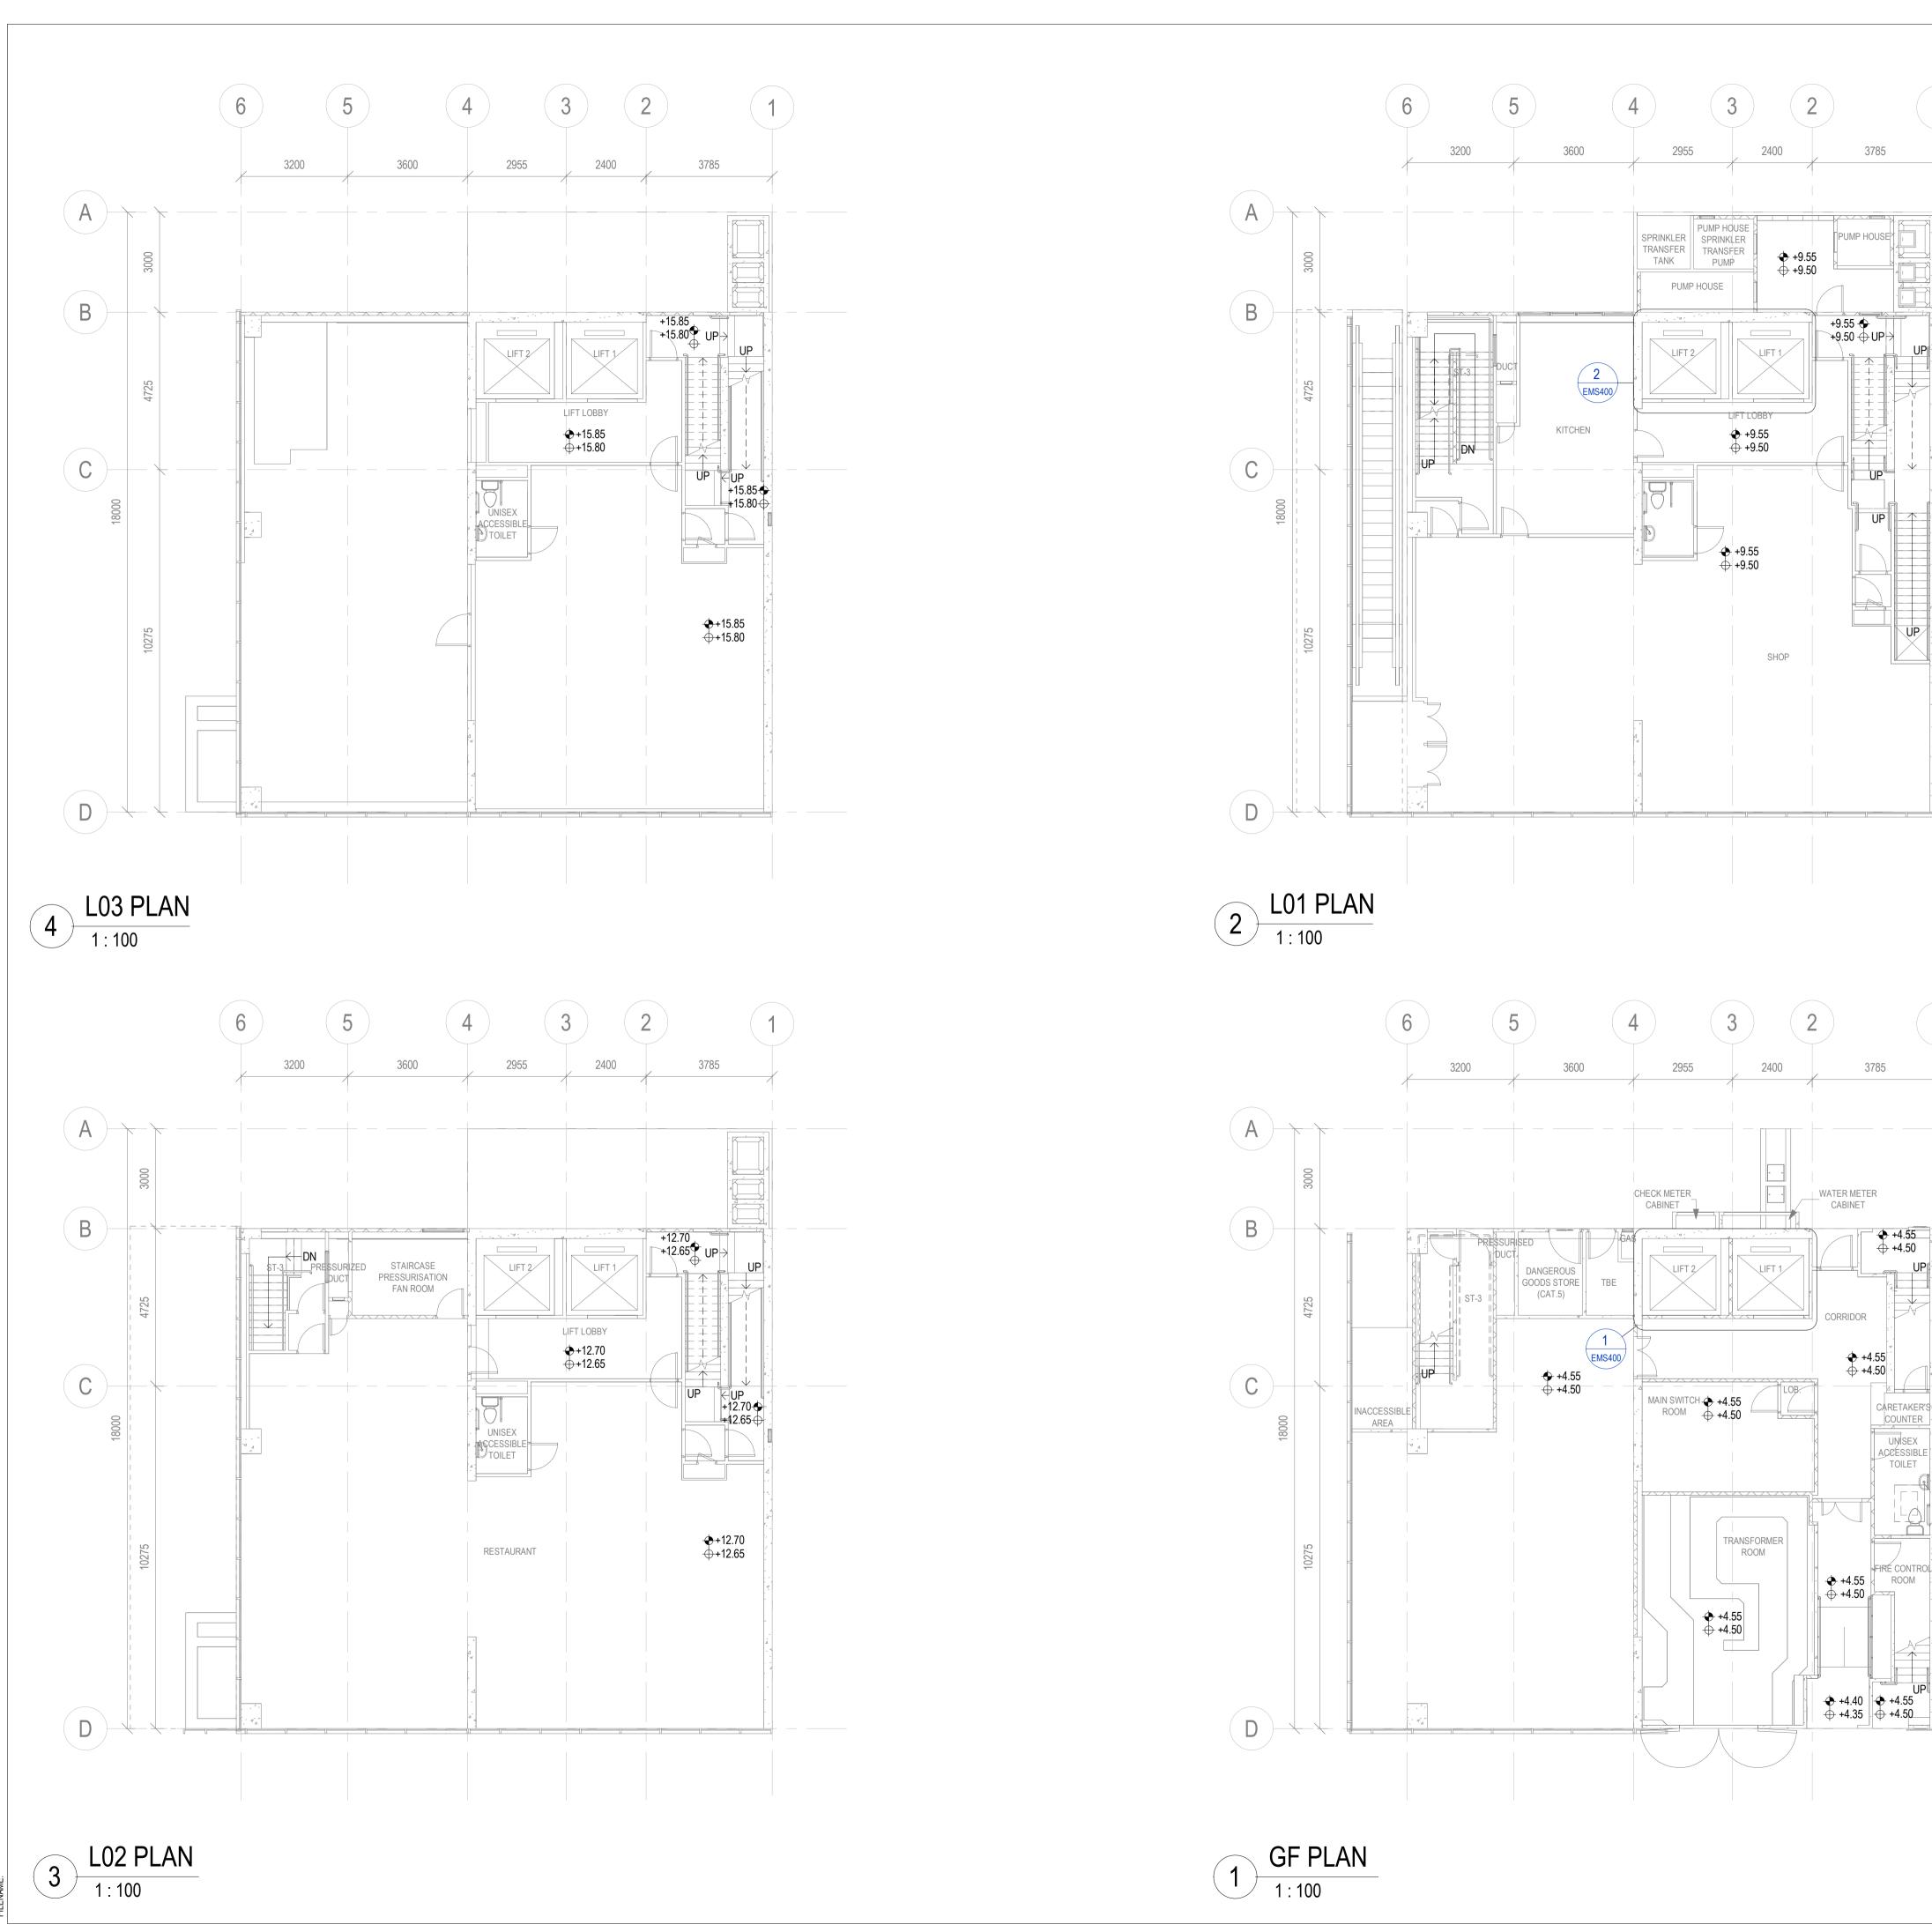

F.S.D.REFERENCE W.W.O.REFERENCE DO NOT SCALE DRAWINGS. ALL DIMENSIONS SHALL BE VERIFIED ON SITE. This is a simulated project aiming to include as many different MEP systems and provisions as possible within one sample building project so that MEP drawings can be produced to illustrate the various drawing requirements and techniques. It shall be noted that professional MEP designs complying to prevailing regulations or design criteria are NOT the purpose of this drawing set and thus the provisions illustrated may appear to be over provided or unreasonably located. Please do not take the system designs as reference. Blue colour stands for "Not directly generated by BIM system but by manual input" QR Code on drawing is an innovative idea to bridge between 2D drawings and 3D BIM model/2D BIM presentations when a Cloud Platform such as CDE is available. CONSTRUCTION INDUSTRY COUNCIL 建造業議會 CONSTRUCTION INDUSTRY COUNCIL 建造業議會 DO NOT SCALE DRAWINGS. ALL DIMENSIONS SHALL BE VERIFIED ON SITE APPOINTING PARTY / CLIENT REVIEW & ACCEPT T - ACCEPTED (TIME) A - REVIEWED & ACCEPTED B - REVIEWED & ACCEPTED WITH COMMENTS C - DO NOT USE AUTHORISATION A - REVIEWED & AUTHORISED B - REVIEWED & AUTHORISED WITH COMMENTS C - DO NOT USE DATE ID 1ST SUBMISSION 08-03-2021 DATE DESCRIPTION NAME AND DESIGNATION DATE DD/MM/YYYY DD/MM/YYYY DESIGNER DD/MM/YYYY BIM MODELLER DD/MM/YYYY CIC SAMPLE PROJECT L&S LAYOUT PLAN AT LEVEL GF, PXXXXX PXXXXX/EMS101

B.D.REFERENCE

CLIENT LOGO


CONSULTANT LOGO

LEAD CONSULTANT / LEAD CONTRACTOR REVIEW &

APPROVED DESIGNED

L01, L02, L03

PURPOSE OF ISSUE PLANNING SUBMISSION DRAWING NO.

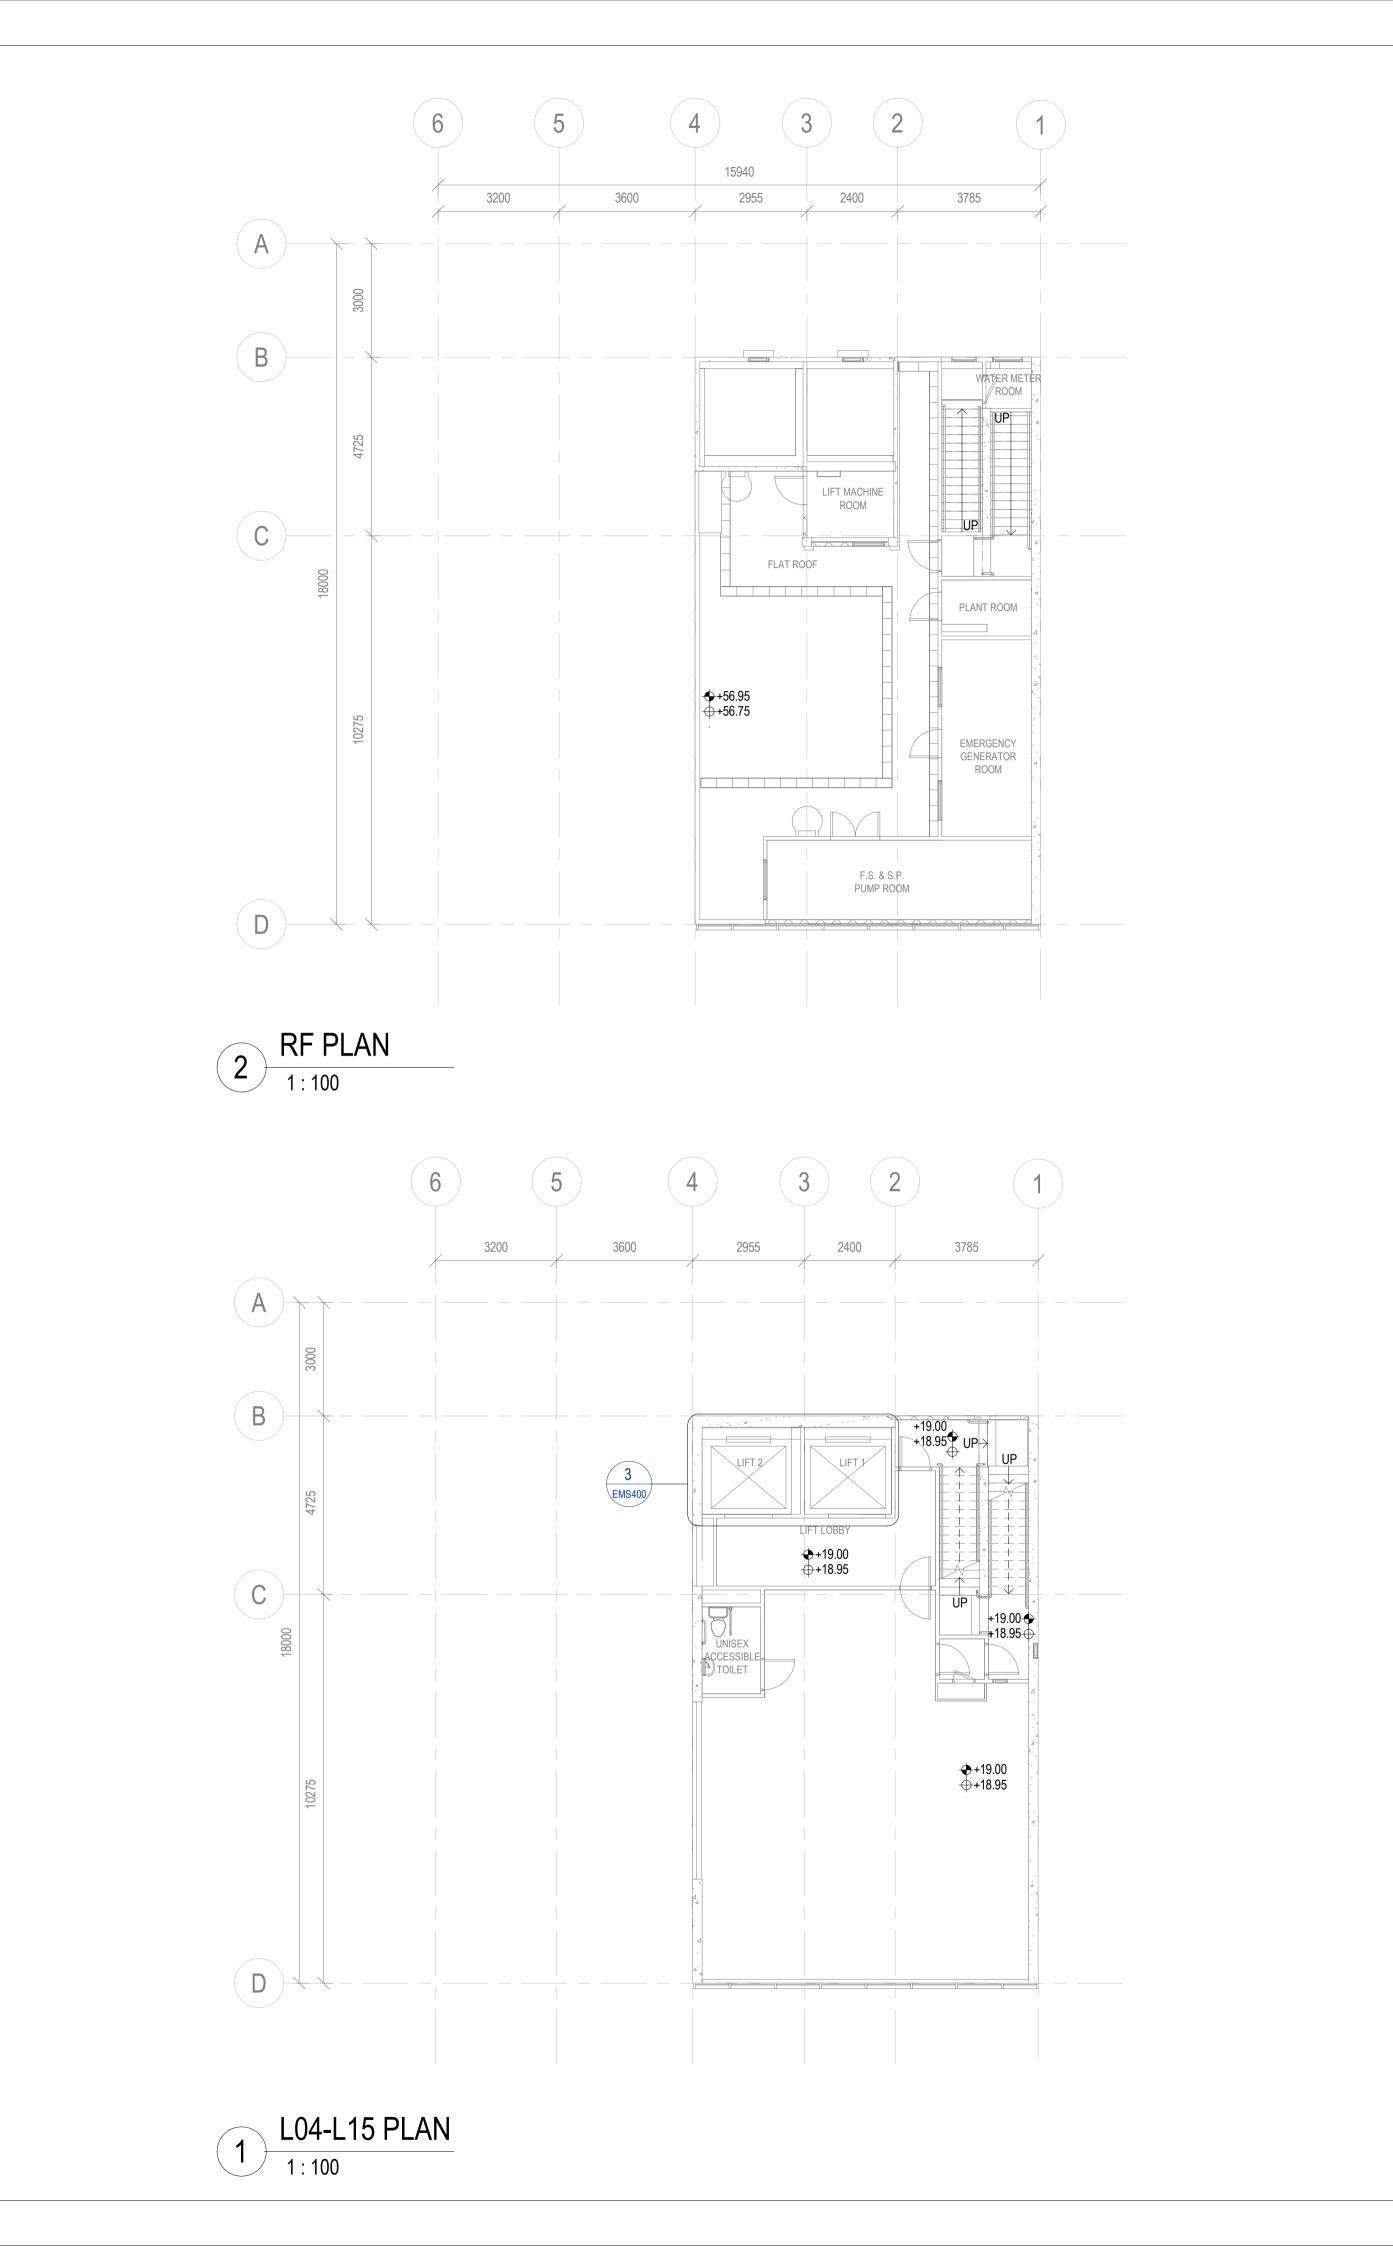

B.D.REFERENCE

F.S.D.REFERENCE

W.W.O.REFERENCE

DO NOT SCALE DRAWINGS. ALL DIMENSIONS SHALL BE VERIFIED ON SITE.

This is a simulated project aiming to include as many different MEP systems and provisions as possible within one sample building project so that MEP drawings can be produced to illustrate the various drawing requirements and techniques.

It shall be noted that professional MEP designs

criteria are NOT the purpose of this drawing set and thus the provisions illustrated may appear to be over provided or unreasonably located. Please do

complying to prevailing regulations or design

not take the system designs as reference.

BIM system but by manual input"

is available.

CLIENT LOGO

CONSULTANT LOGO

Blue colour stands for "Not directly generated by

QR Code on drawing is an innovative idea to bridge between 2D drawings and 3D BIM model/2D BIM

presentations when a Cloud Platform such as CDE

CONSTRUCTION INDUSTRY COUNCIL

建造業議會

CONSTRUCTION INDUSTRY COUNCIL

建造業議會

DO NOT SCALE DRAWINGS. ALL DIMENSIONS SHALL BE VERIFIED ON SITE APPOINTING PARTY / CLIENT REVIEW & ACCEPT

B - REVIEWED & ACCEPTED WITH COMMENTS

LEAD CONSULTANT / LEAD CONTRACTOR REVIEW &

B - REVIEWED & AUTHORISED WITH COMMENTS

DESCRIPTION

NAME AND DESIGNATION

L&S LAYOUT PLAN AT L04-L15, RF,

PXXXXX

PXXXXX/EMS102

PURPOSE OF ISSUE PLANNING SUBMISSION

08-03-2021

DATE

DATE

DD/MM/YYYY

DD/MM/YYYY

DD/MM/YYYY

DD/MM/YYYY

T - ACCEPTED (TIME)

C - DO NOT USE

C - DO NOT USE

AUTHORISATION

1ST SUBMISSION

APPROVED APPROVER

CHECKER

DESIGNER

CIC SAMPLE PROJECT

BIM MODELLER

CHECKED

DESIGNED

DRAWN

URF, TRF

DRAWING NO.

DATE ID

A - REVIEWED & ACCEPTED

A - REVIEWED & AUTHORISED

3200

3600

2955

1,500 LITRES R.C. WATER TANK FOR FLUSHING

R.C. WATER TANK FOR FIRE SERVICES

4,300 LITRES R.C. WATER TANK FOR

+60.90


2400


3785

124 000 LITRES

R.C. SPRINKLER WATER TANK

URF PLAN

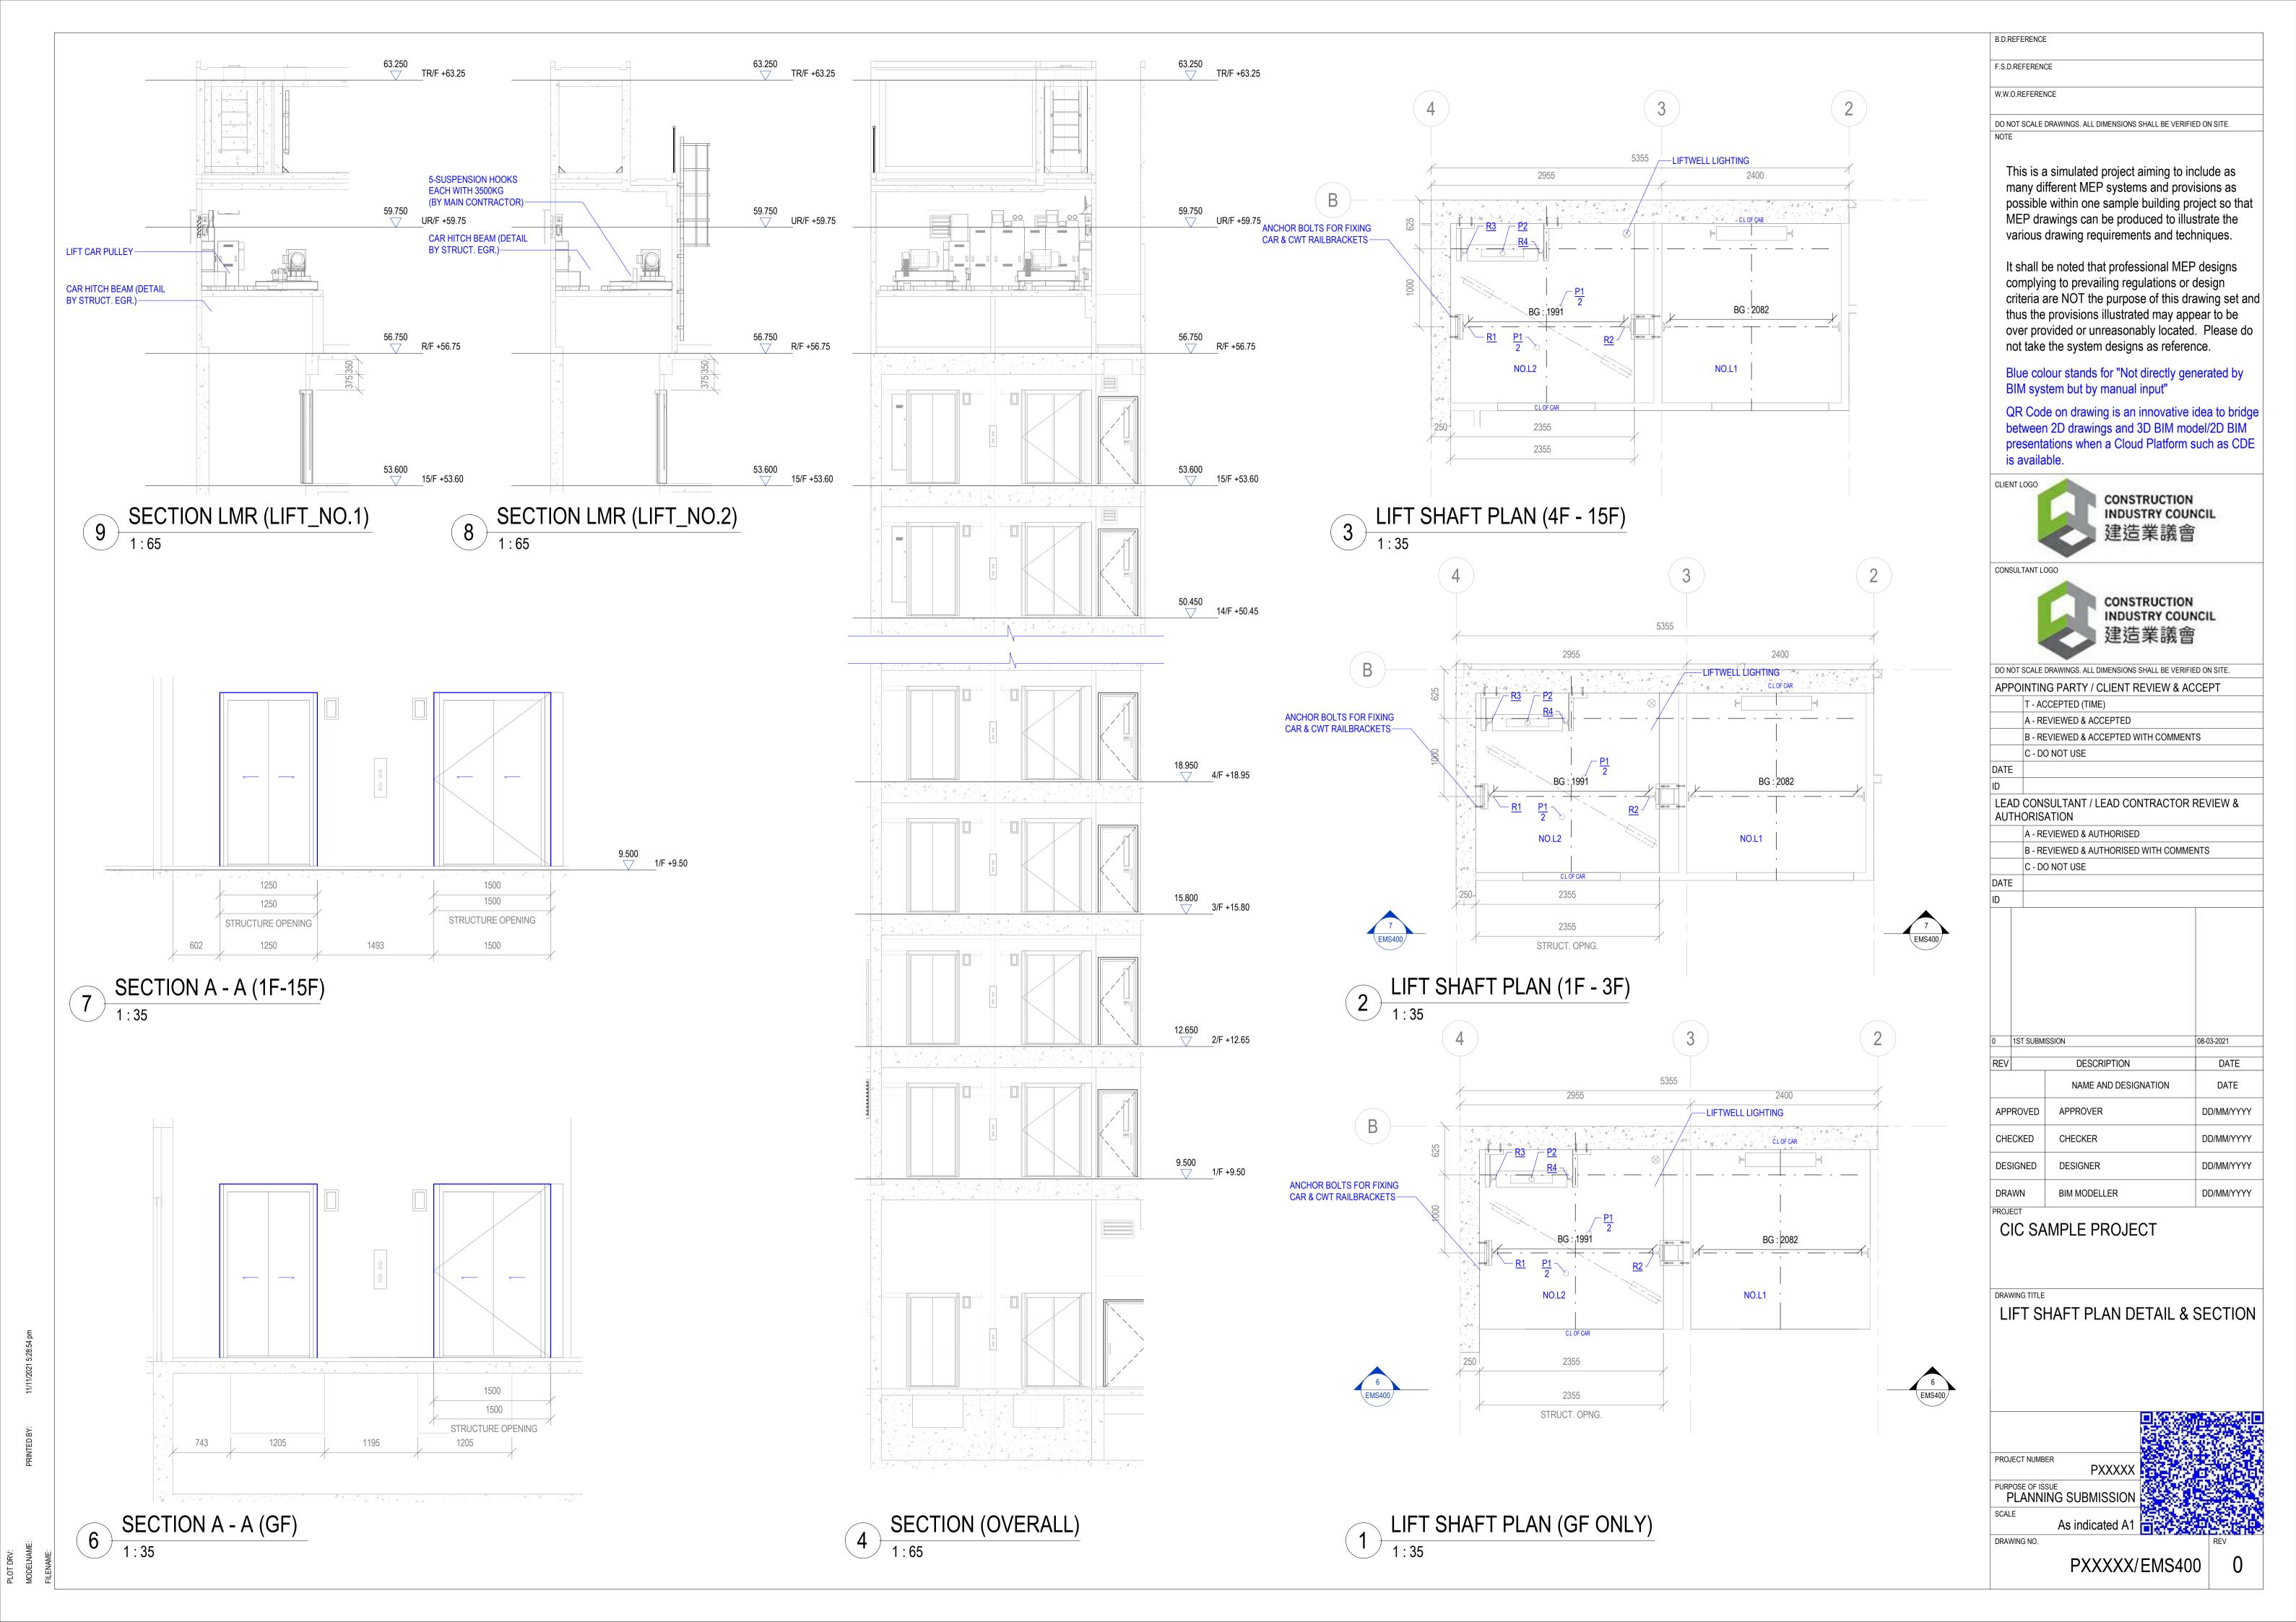

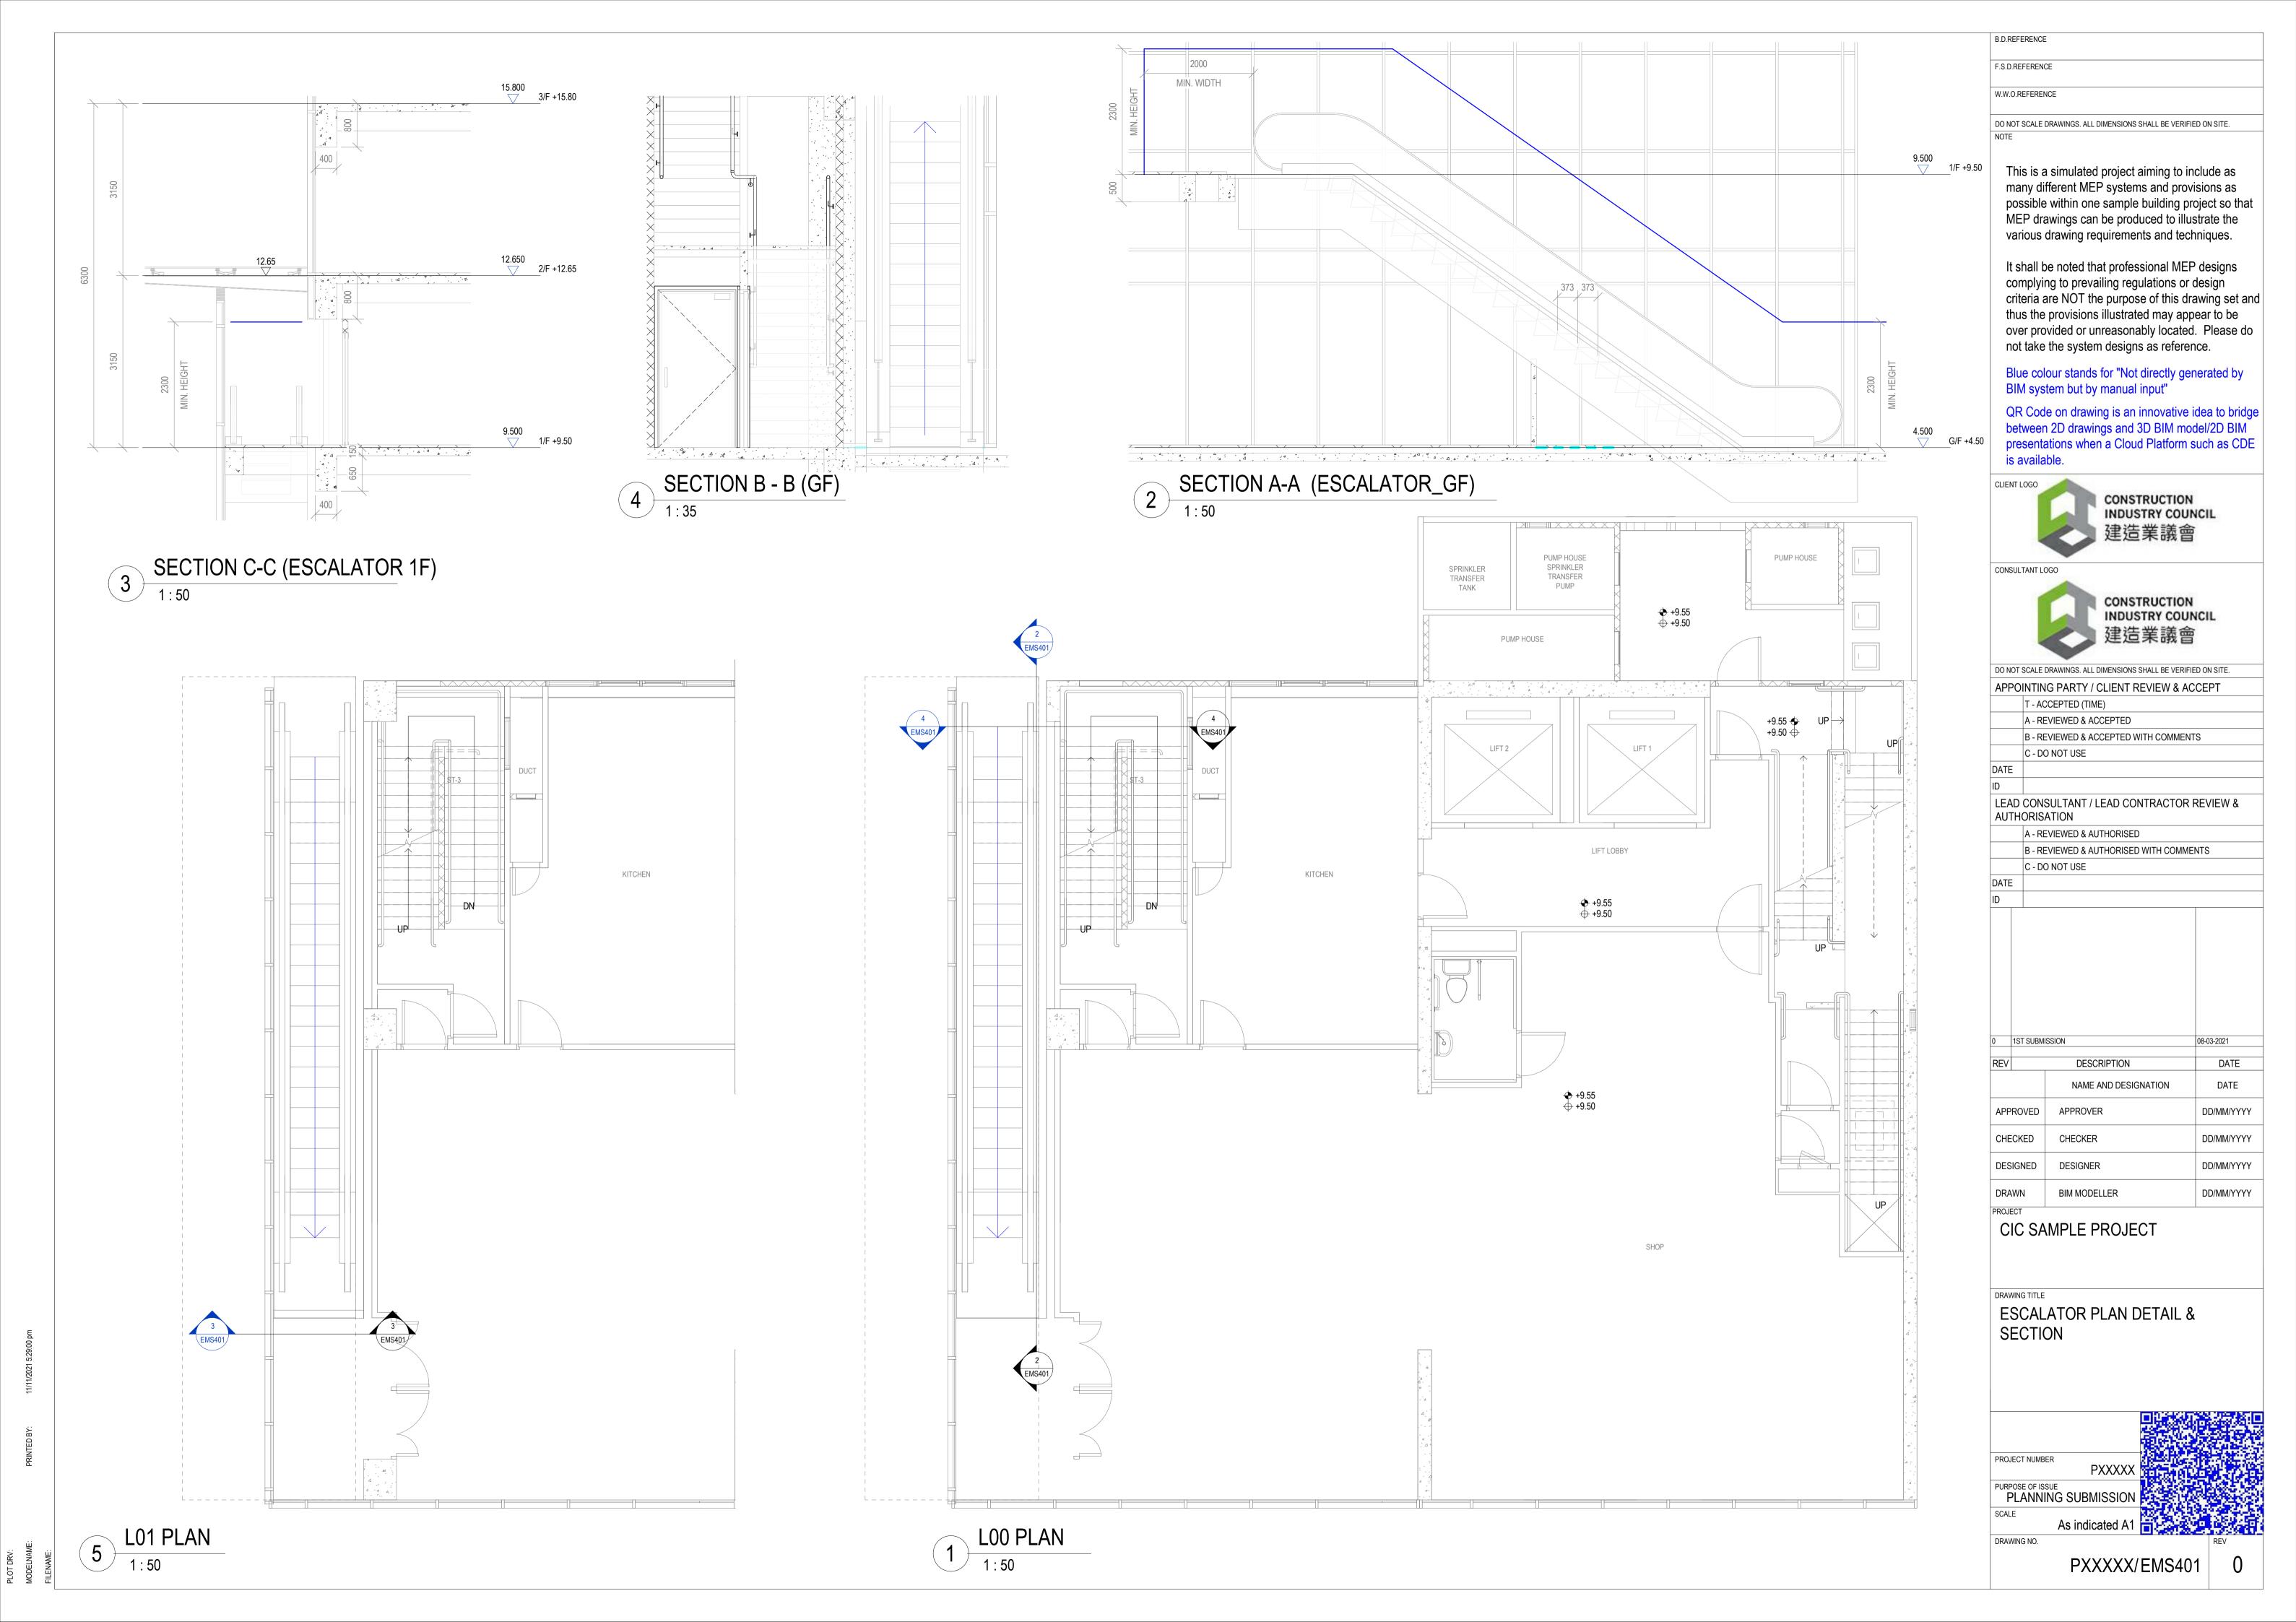

ABBREVIATION PROVING PIPE PERMANENT TESTING AND **AUTOMATIC AIR VENT HOSE REEL** DRAINAGE FACILITIES COMPLETE WITH FLOW METER AND ORIFICE PLATE ASSEMBLY FIRE HYDRANT COMPLETE WITH 13A FUSE SPUR UNIT **FROM ABOVE BOUNDARY LINE** SPRINKLER CONTROL VALVE SET FROM BELOW SPRINKLER 4.5kg Co2 FIRE EXTINGUISHER TO BELOW FIXED FIRE PUMP ZONE SUBSIDIARY STOP VALVE C/W MONITORING DEVICE SPRINKLER TRANSFER PUMP T TO B TOP TO BOTTOM STP WATER MOTOR ALARM GONG FIRE SERVICES SPRINKLER PUMP ANTI - POLLUTION VALVE C/W MONITORING HIGH LEVEL FS TRANSFER PUMP STOP VALVE C/W MONITORING DEVICE FIRE SERVICE COMMUNICATION CENTRE LOW LEVEL

L TO R

UNDERGROUND

LEFT TO RIGHT

GLASS REINFORCED PLASTIC

FIRE SERVICES NOTES

GLOBE VALVE

DIRECT READING FLOW METER

THE FIRE SERVICE INSTALLATIONS ARE PROVIDED IN ACCORDANCE WITH THE REQUIREMENTS AND SPECIFICATIONS OF THE CURRENT EDITION OF THE CODES OF PRACTICE FOR MINIMUM FIRE SERVICE INSTALLATIONS AND EQUIPMENT AND INSPECTION, TESTING AND MAINTENANCE OF INSTALLATIONS AND EQUIPMENT AND THE CURRENT ISSUE OF THE FSD CIRCULAR LETTERS. THE PARTICULARS OF THE FIRE SERVICE INSTALLATIONS TO BE PROVIDED FOR THE BUILDING ARE AS FOLLOWS:-

AUTOMATIC SPRINKLER SYSTEM DESIGNED TO OH(I) IN ACCORDANCE WITH "LPC RULES INCORPORATING BS EN 12845:2003 FOR AUTOMATIC SPRINKLER INSTALLATIONS" TO BE PROVIDED FOR ALL AREAS INCLUDING STAIRCASES, SEATING AREA, KITCHEN, PANTRY AND UNISEX TOILETSBUT EXCLUDE CONSUMER ELECTRICAL EQUIPMENT /MECHANICAL PLANT ROOM AS INDICATED ON THE DRAWINGS. SPRINKLER ANNUNCIATION PANEL TO BE PROVIDED AT G/F FIRE CONTROL CENTRE AS INDICATED ON THE DRAWINGS. ALARM SIGNAL TO BE TRANSMITTED TO F.S. COMMUNICATION CENTRE VIA DIRECT TELEPHONE LINK. WATER SUPPLY TO SPRINKLER TANK TO BE SINGLE END FEED. CAPACITY OF SPRINKLER TANK TO BE 37m3.

SPRINKLER SYSTEM WILL NOT BE PROVIDED FOR ALL EXTERNAL CANOPIES WHERE GOODS ARE NOT STORED OR HANDLED IN ACCORDANCE WITH FSD CIRCULAR NO.3/2006, LIST TWO ITEM 2.93.

2) EMERGENCY POWER SUPPLY

a. THE FLECTRICITY SUPPLIES TO ALL EMERGENCY FLECTRICAL FOLIPMENT TO BE FED FROM THE INCOMING POWER SUPPLY BY THE POWER COMPANY AT

TO BE PROVIDED THROUGHOUT THE ENTIRE BUILDING AND FOR ALL EXIT SIGNS AND BACKED UP BY SELF CONTAINED/SECONDARY BATTERY

a. SUFFICIENT EXIT OF SELF CONTAINED BATTERY TYPE, TO BE PROVIDED AT LOCATIONS AS INDICATED ON THE DRAWINGS.

MANUALLY OPERATED FIRE ALARM SYSTEM COMPRISING MANUAL BREAK-GLASS AND ALARM BELL TO BE PROVIDED AT EACH HOSE REEL LOCATION AS INDICATED ON THE DRAWINGS. THE SYSTEM TO BE LINKED TO THE AUTOMATIC FIRE ALARM SYSTEM AND FS COMMUNICATION CENTRE VIA DIRECT TELEPHONE LINK.

VISUAL FIRE ALARM SYSTEM TO BE PROVIDED FOR THE AREA WHICH IS INTENDED TO BE ACCESSIBLE TO PUBLIC AS INDICATED ON THE DRAWINGS IN ACCORDANCE WITH FSD CIRCULAR LETTERS 2/2012 OF BS 5839-1:2002+A2:2008 AND BARRIER FREE ACCESS 2008 CODE, AND THE ALARM SIGNAL SHALL FORM PART OF THE FIRE ALARM SYSTEM.

FIRE ALARM CONTROL PANEL TO BE PROVIDED AT LOCATION AS INDICATED ON THE DRAWINGS.

6) FIRE DETECTION SYSTEM

AND ALARM SYSTEMS FOR THE PROTECTION OF PROPERTY" (LPC RULES) AND BS 5839-1:2002+A2:2008 WITH MODIFICATIONS AS REQUIRED IN FSD. CIRCULAR LETTER NO. 1/2002 & 2/2012 TO BE PROVIDED FOR AREAS NOT PROTECTED BY AUTOMATIC SPRINKLER SYSTEM. HEAT DETECTION SYSTEM TO BE PROVIDED FOR CONSUMER ELECTRICAL EQUIPMENT/MECHANICAL PLANT/TBE ROOM. AUTOMATIC FIRE ALARM PANEL TO BE PROVIDED AT G/F FIRE CONTROL CENTRE AS INDICATED ON THE DRAWINGS. ALARM SIGNAL TO BE TRANSMITTED TO F.S. COMMUNICATION CENTRE VIA DIRECT TELEPHONE LINK.

7) FIRE HYDRANT / HOSE REEL INSTALLATION

TO BE PROVIDED AT LOCATIONS AS INDICATED ON THE DRAWINGS. CAPACITY OF THE WATER TANK TO BE 27m3. SINGLE OUTLET TYPE HYDRANTS TO BE PROVIDED. HOSE REEL TO BE PROVIDED THAT EVERY PART OF THE BUILDING CAN BE REACHED BY A LENGTH OF NOT MORE THAN 30m HOSE REEL TUBING.

8) PORTABLE HAND OPERATED APPROVED APPLIANCES TO BE PROVIDED AT LOCATIONS AS INDICATED ON THE DRAWINGS.

NOMINALI PIPE SIZE

Ø150 & BELOW (ABOVE GROUND)

9) VENTILATION/AIR-CONDITIONING CONTROL SYSTEM NOT TO BE PROVIDED FOR ALL BUILDINGS.

10) ADDITIONAL REQUIREMENTS

ALL LININGS FOR ACOUSTIC AND THERMAL INSULATION PURPOSES IN DUCTING AND CONCEALED LOCATIONS SHALL BE TESTED IN ACCORDANCE WITH CODE OF PRACTICE FOR FIRE SAFETY IN BUILDINGS 2011 (COP FOR F.S.B.) SUB SECTION E15.1.

ALL LININGS FOR ACOUSTIC, THERMAL INSULATION AND DECORATIVE PURPOSES WITHIN PROTECTED MEANS OF ESCAPE SHALL BE TESTED IN ACCORDANCE WITH CODE OF PRACTICE FOR FIRE SAFETY IN BUILDINGS 2011 (FSB 2011) SUB SECTION E13.2.

PIPE SCHEDULE


PIPE SPECIFICATION


GALVANIZED MILD STEEL PIPE OF AT LEAST MEDIUM GRADE TO BS EN 10255:2004 OR ISO 65:1981 FOR SCREWING TO BS EN 10226-1:2004 OF ISO

<u>7-1:1994 PIPE THREADS. FITTINGS SHALL BE TO BS EN 10241:2000 OR BS EN</u>

SPRINKLER SCHEDULE				
ZONE	NO. OF TOTAL SPR. HEAD			
<u>G/F +4.50</u>	<u>30</u>			
<u>1/F +9.50</u>	<u>50</u>			
<u>2/F +12.65</u>	<u>1</u>			
2/F +12.65	<u>44</u>			
<u>2/F +12.65</u>	<u>6</u>			
<u>3/F +15.80</u>	<u>30</u>			
<u>4/F +18.95</u>				
<u>5/F +22.10</u>	FOR RE			
<u>6/F +25.25</u>	FUNIL			
<u>7/F +28.40</u>	<u> </u>			
<u>8/F +31.55</u>	<u>30</u>			
<u>9/F +34.70</u>	<u>30</u>			
<u>10/F +37.85</u>	<u>30</u>			
<u>11/F +41.00</u>	<u>30</u>			
<u>12/F +44.15</u>	<u>30</u>			
<u>12/F +44.15</u>	<u>6</u>			
<u>13/F +47.30</u>	<u>30</u>			
<u>14/F +50.45</u>	<u>30</u>			
<u>15/F +53.60</u>	<u>16</u>			
Total	<u>513</u>			


	DRAWING LIST DRAWING TITLE	REVISION
FS001	LEGENDS, ABBREVIATION AND GENERAL NOTES	0
FS100	SCHEMATIC	0
FS101	F.S. LAYOUT PLAN AT LEVEL GF, L01, L02, L03	0
FS102	F.S. LAYOUT PLAN AT LEVEL L04-L15, RF, URF, TRF	\0
FS400	F.S. ROOF SPRINKLER PUMP ROOM AT LEVEL RF	0
FS401	F.S. DANGEROUS GOOD STORE LAYOUT AT LEVEL GF	0
FS500	F.S. STATIC SMOKE EXTRACTION PLAN	0
FS501	F.S. STATIC SMOKE EXTRACTION SECTION	0

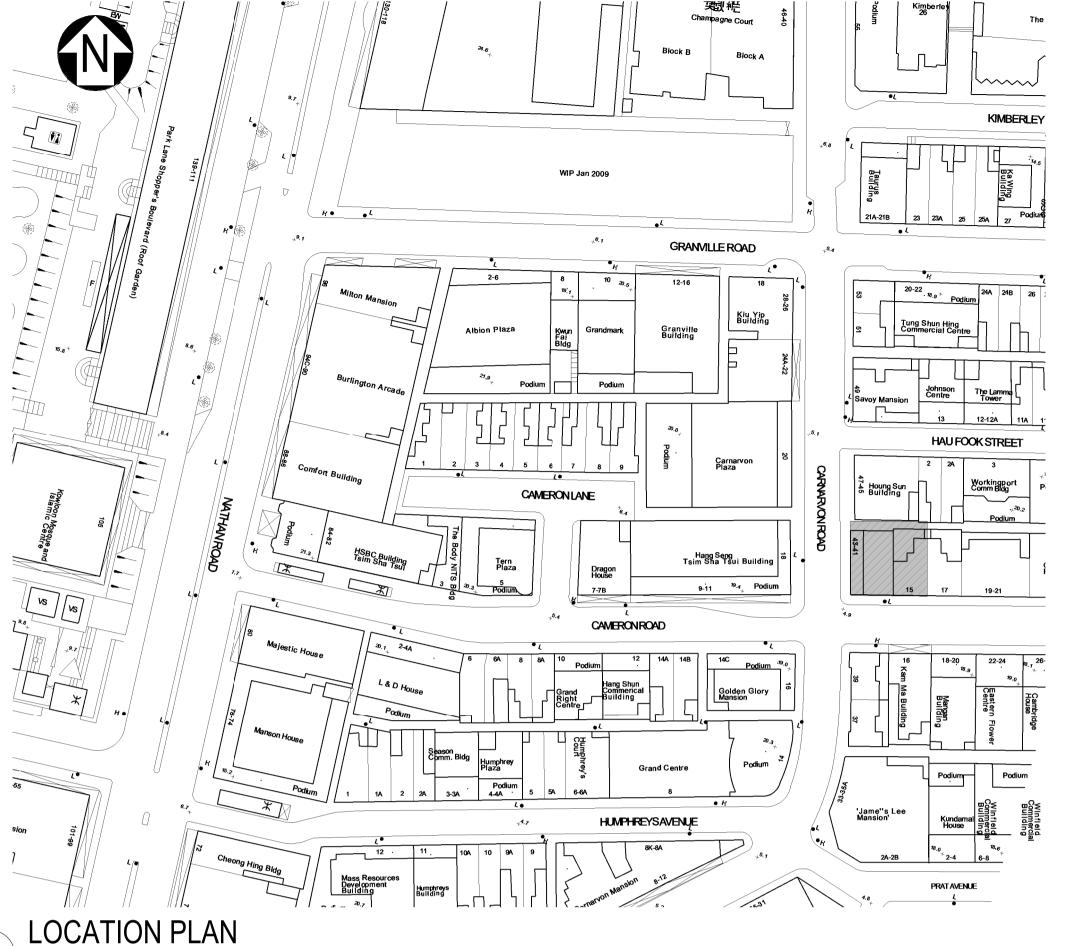


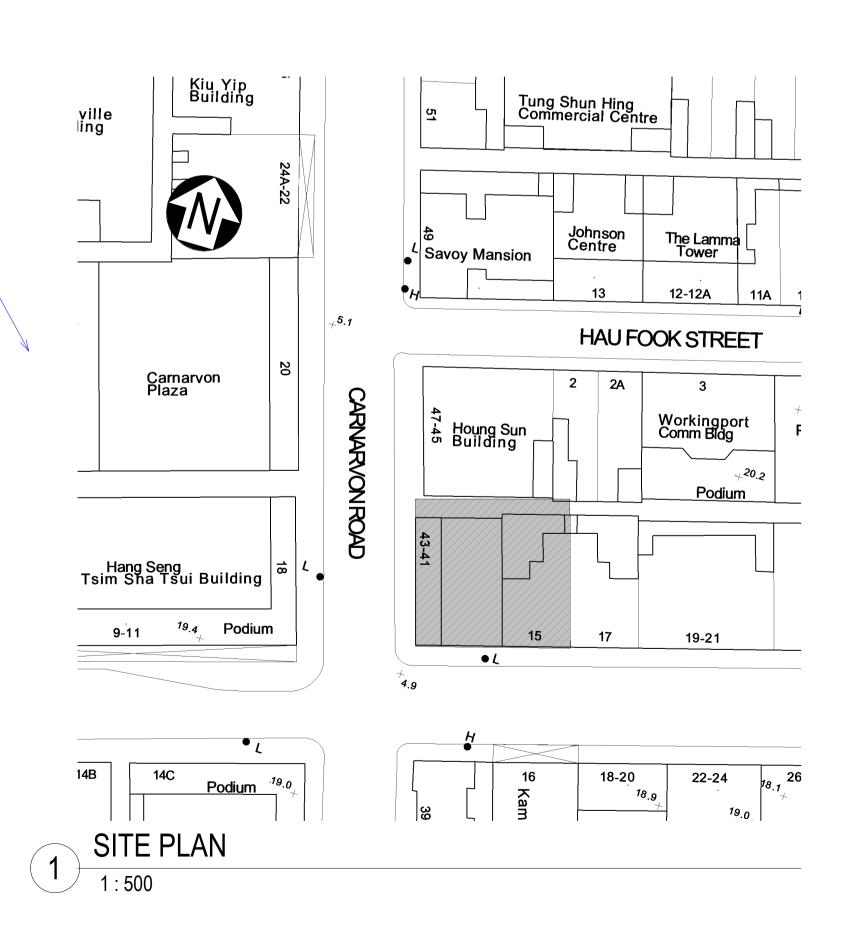


F.S.D.REFERENCE W.W.O.REFERENCE DO NOT SCALE DRAWINGS. ALL DIMENSIONS SHALL BE VERIFIED ON SITE. This is a simulated project aiming to include as many different MEP systems and provisions as possible within one sample building project so that MEP drawings can be produced to illustrate the various drawing requirements and techniques. It shall be noted that professional MEP designs complying to prevailing regulations or design criteria are NOT the purpose of this drawing set and thus the provisions illustrated may appear to be over provided or unreasonably located. Please do not take the system designs as reference. Blue colour stands for "Not directly generated by BIM system but by manual input" QR Code on drawing is an innovative idea to bridge between 2D drawings and 3D BIM model/2D BIM presentations when a Cloud Platform such as CDE is available. CLIENT LOGO CONSTRUCTION INDUSTRY COUNCIL 建造業議會 CONSULTANT LOGO CONSTRUCTION INDUSTRY COUNCIL 建造業議會 DO NOT SCALE DRAWINGS. ALL DIMENSIONS SHALL BE VERIFIED ON SITE APPOINTING PARTY / CLIENT REVIEW & ACCEPT T - ACCEPTED (TIME) A - REVIEWED & ACCEPTED B - REVIEWED & ACCEPTED WITH COMMENTS C - DO NOT USE LEAD CONSULTANT / LEAD CONTRACTOR REVIEW & **AUTHORISATION** A - REVIEWED & AUTHORISED B - REVIEWED & AUTHORISED WITH COMMENTS C - DO NOT USE DATE 08-03-2021 1ST SUBMISSION DESCRIPTION DATE NAME AND DESIGNATION DATE APPROVED APPROVER DD/MM/YYYY CHECKED CHECKER DD/MM/YYYY DESIGNED DESIGNER DD/MM/YYYY DRAWN **BIM MODELLER** DD/MM/YYYY CIC SAMPLE PROJECT LEGENDS, ABBREVIATION AND **GENERAL NOTES**


B.D.REFERENCE

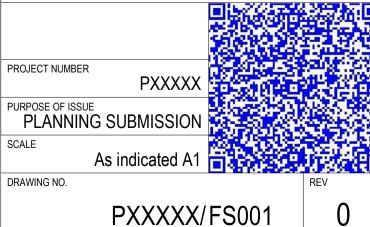


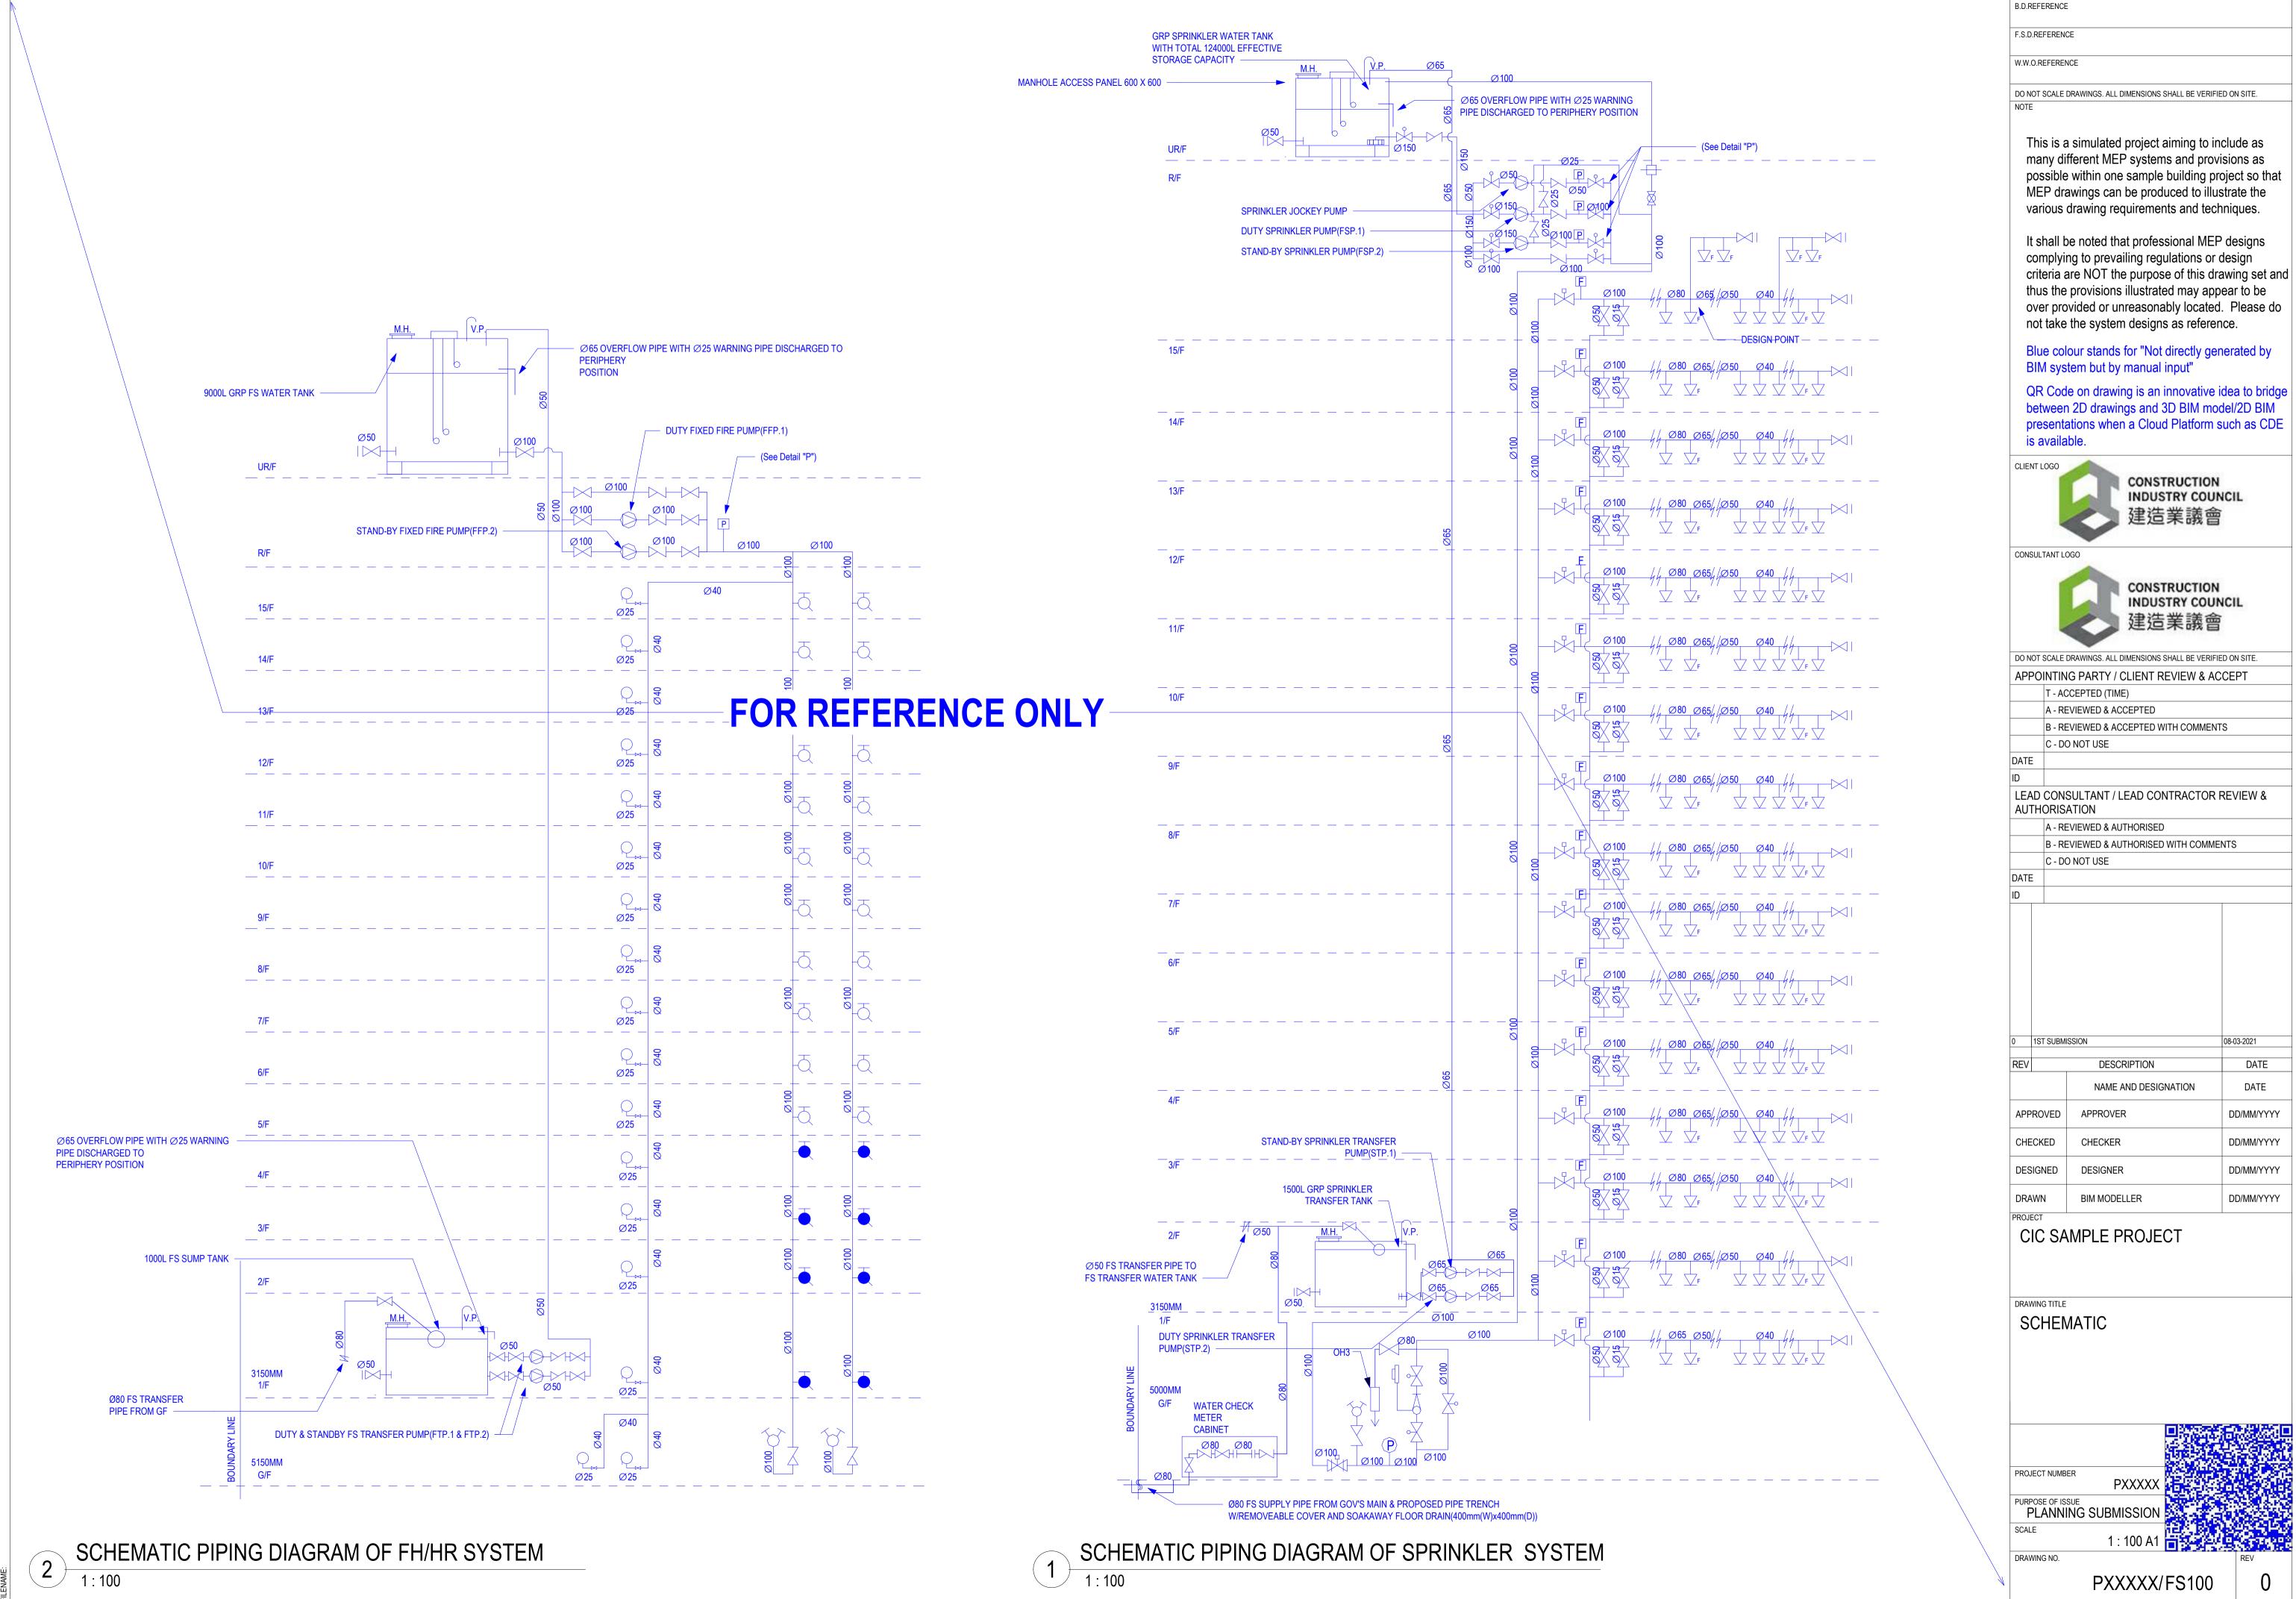

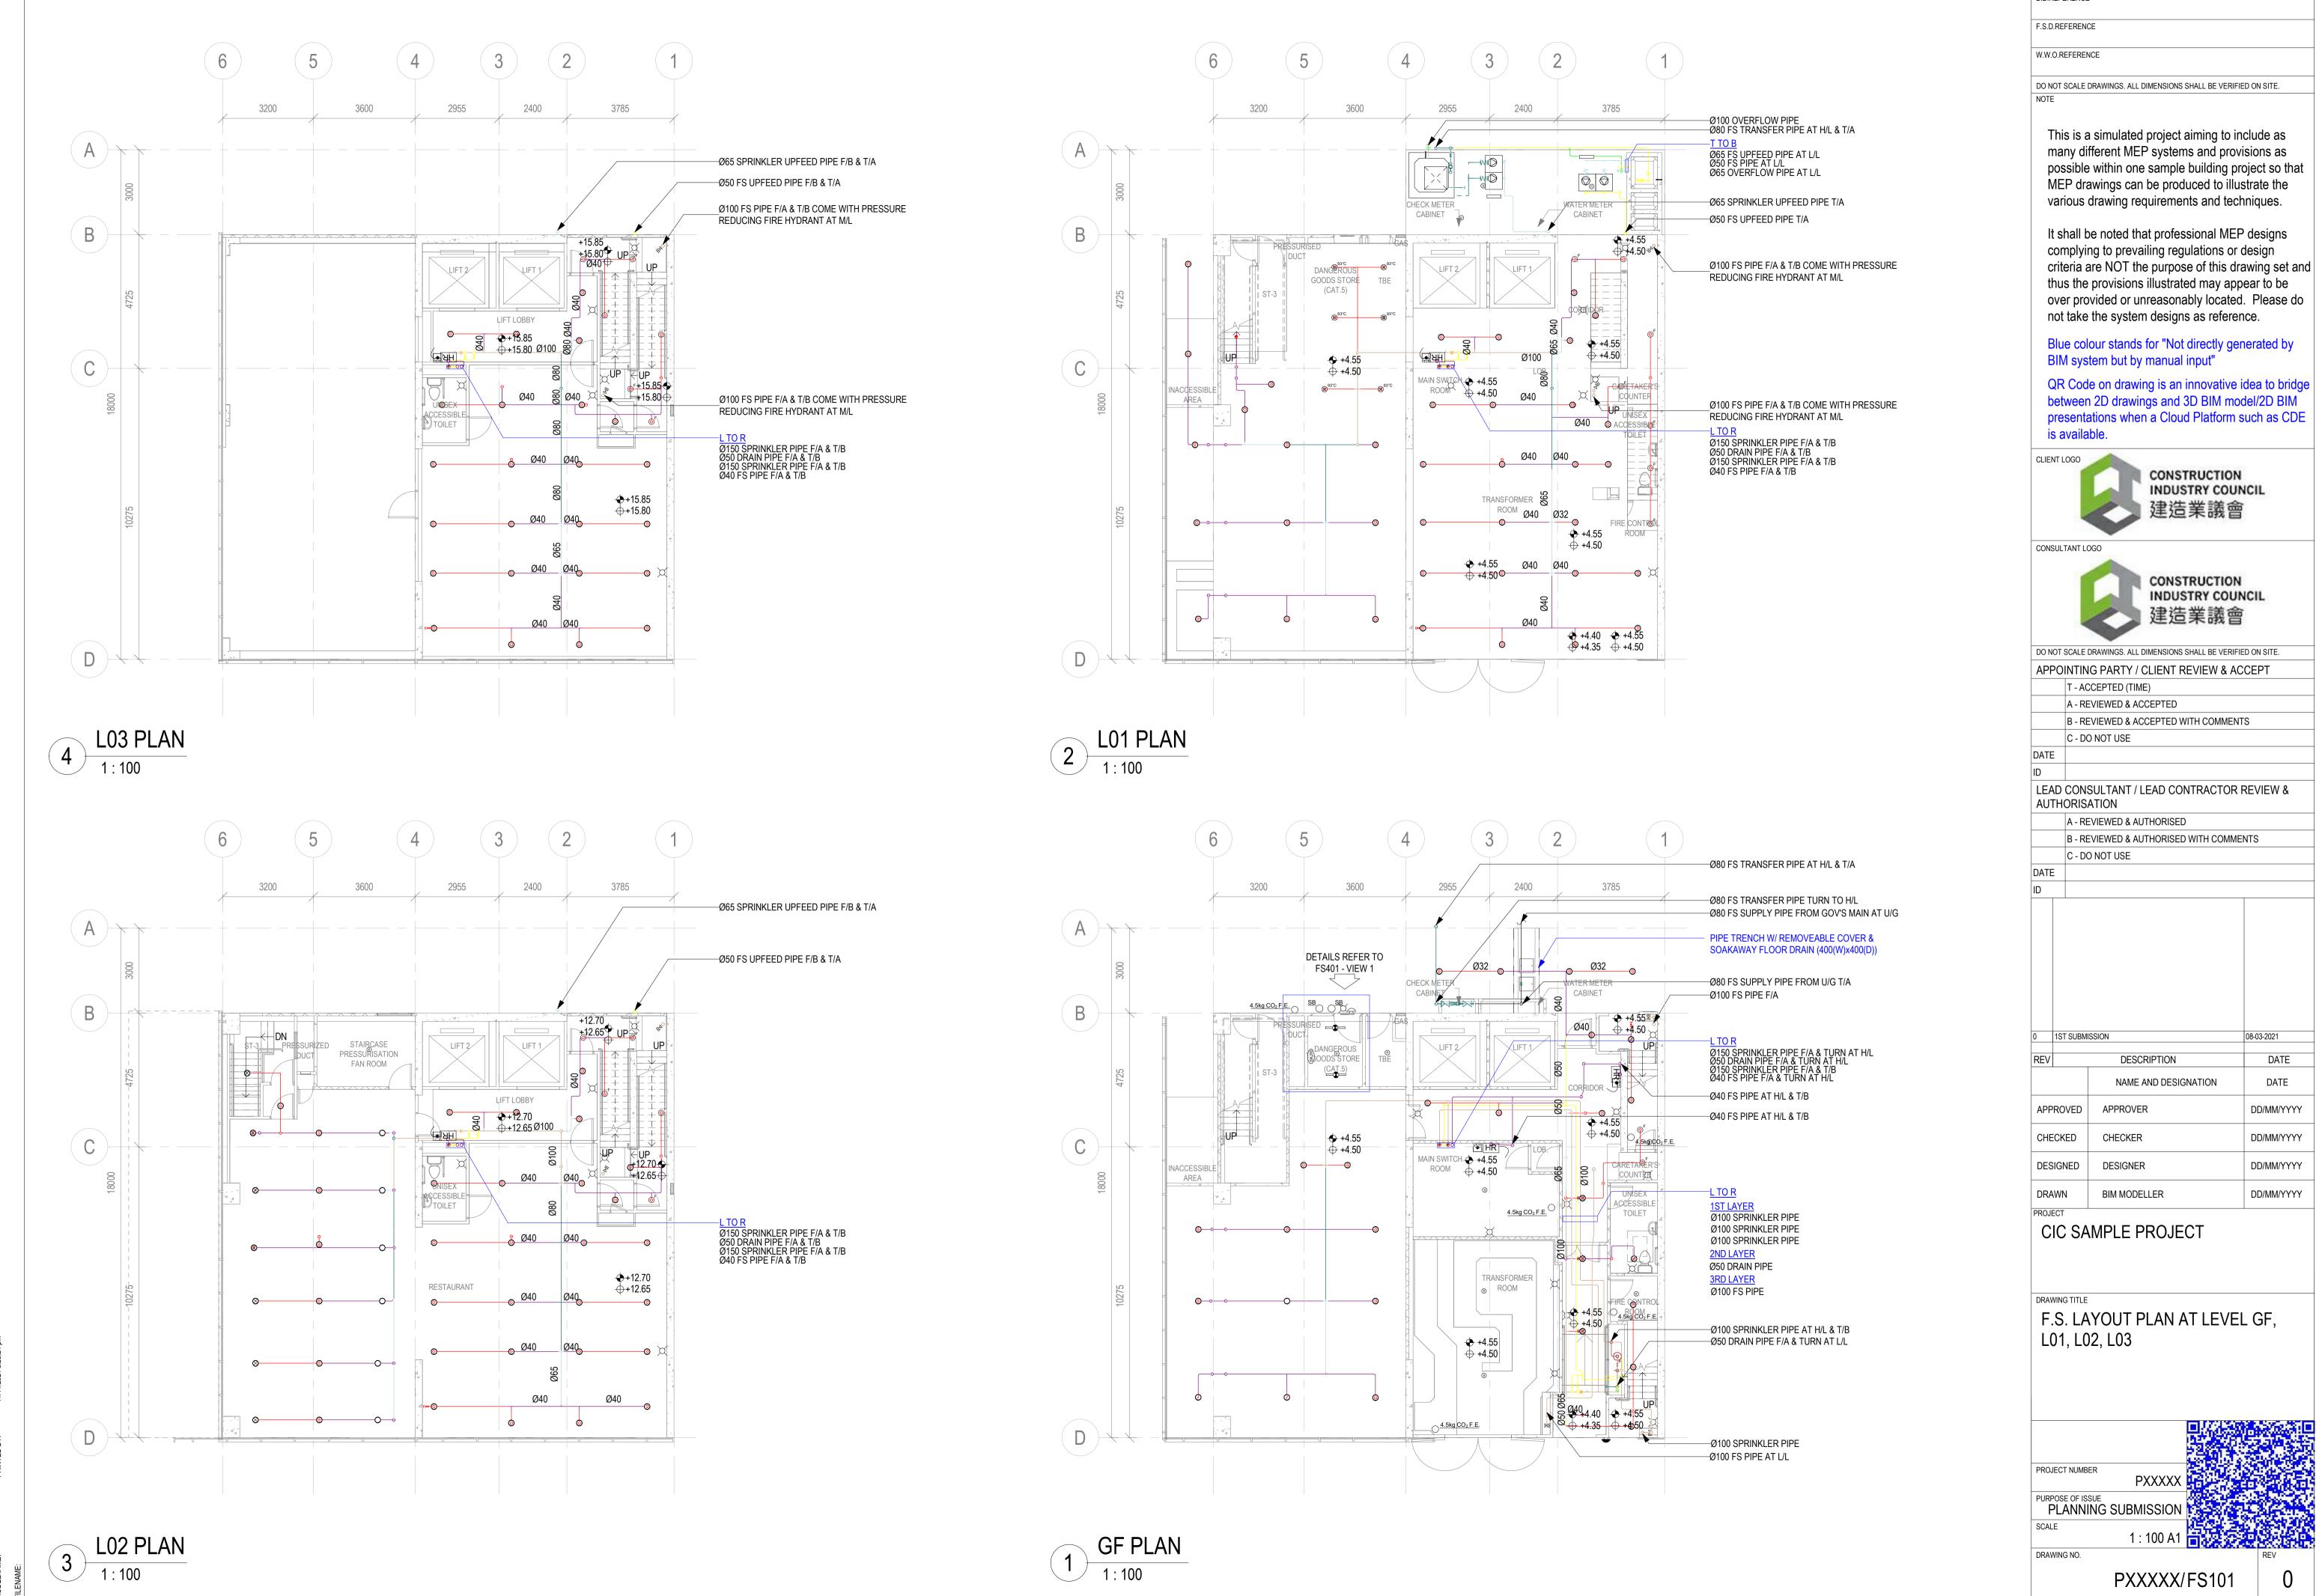


B.D.REFERENCE

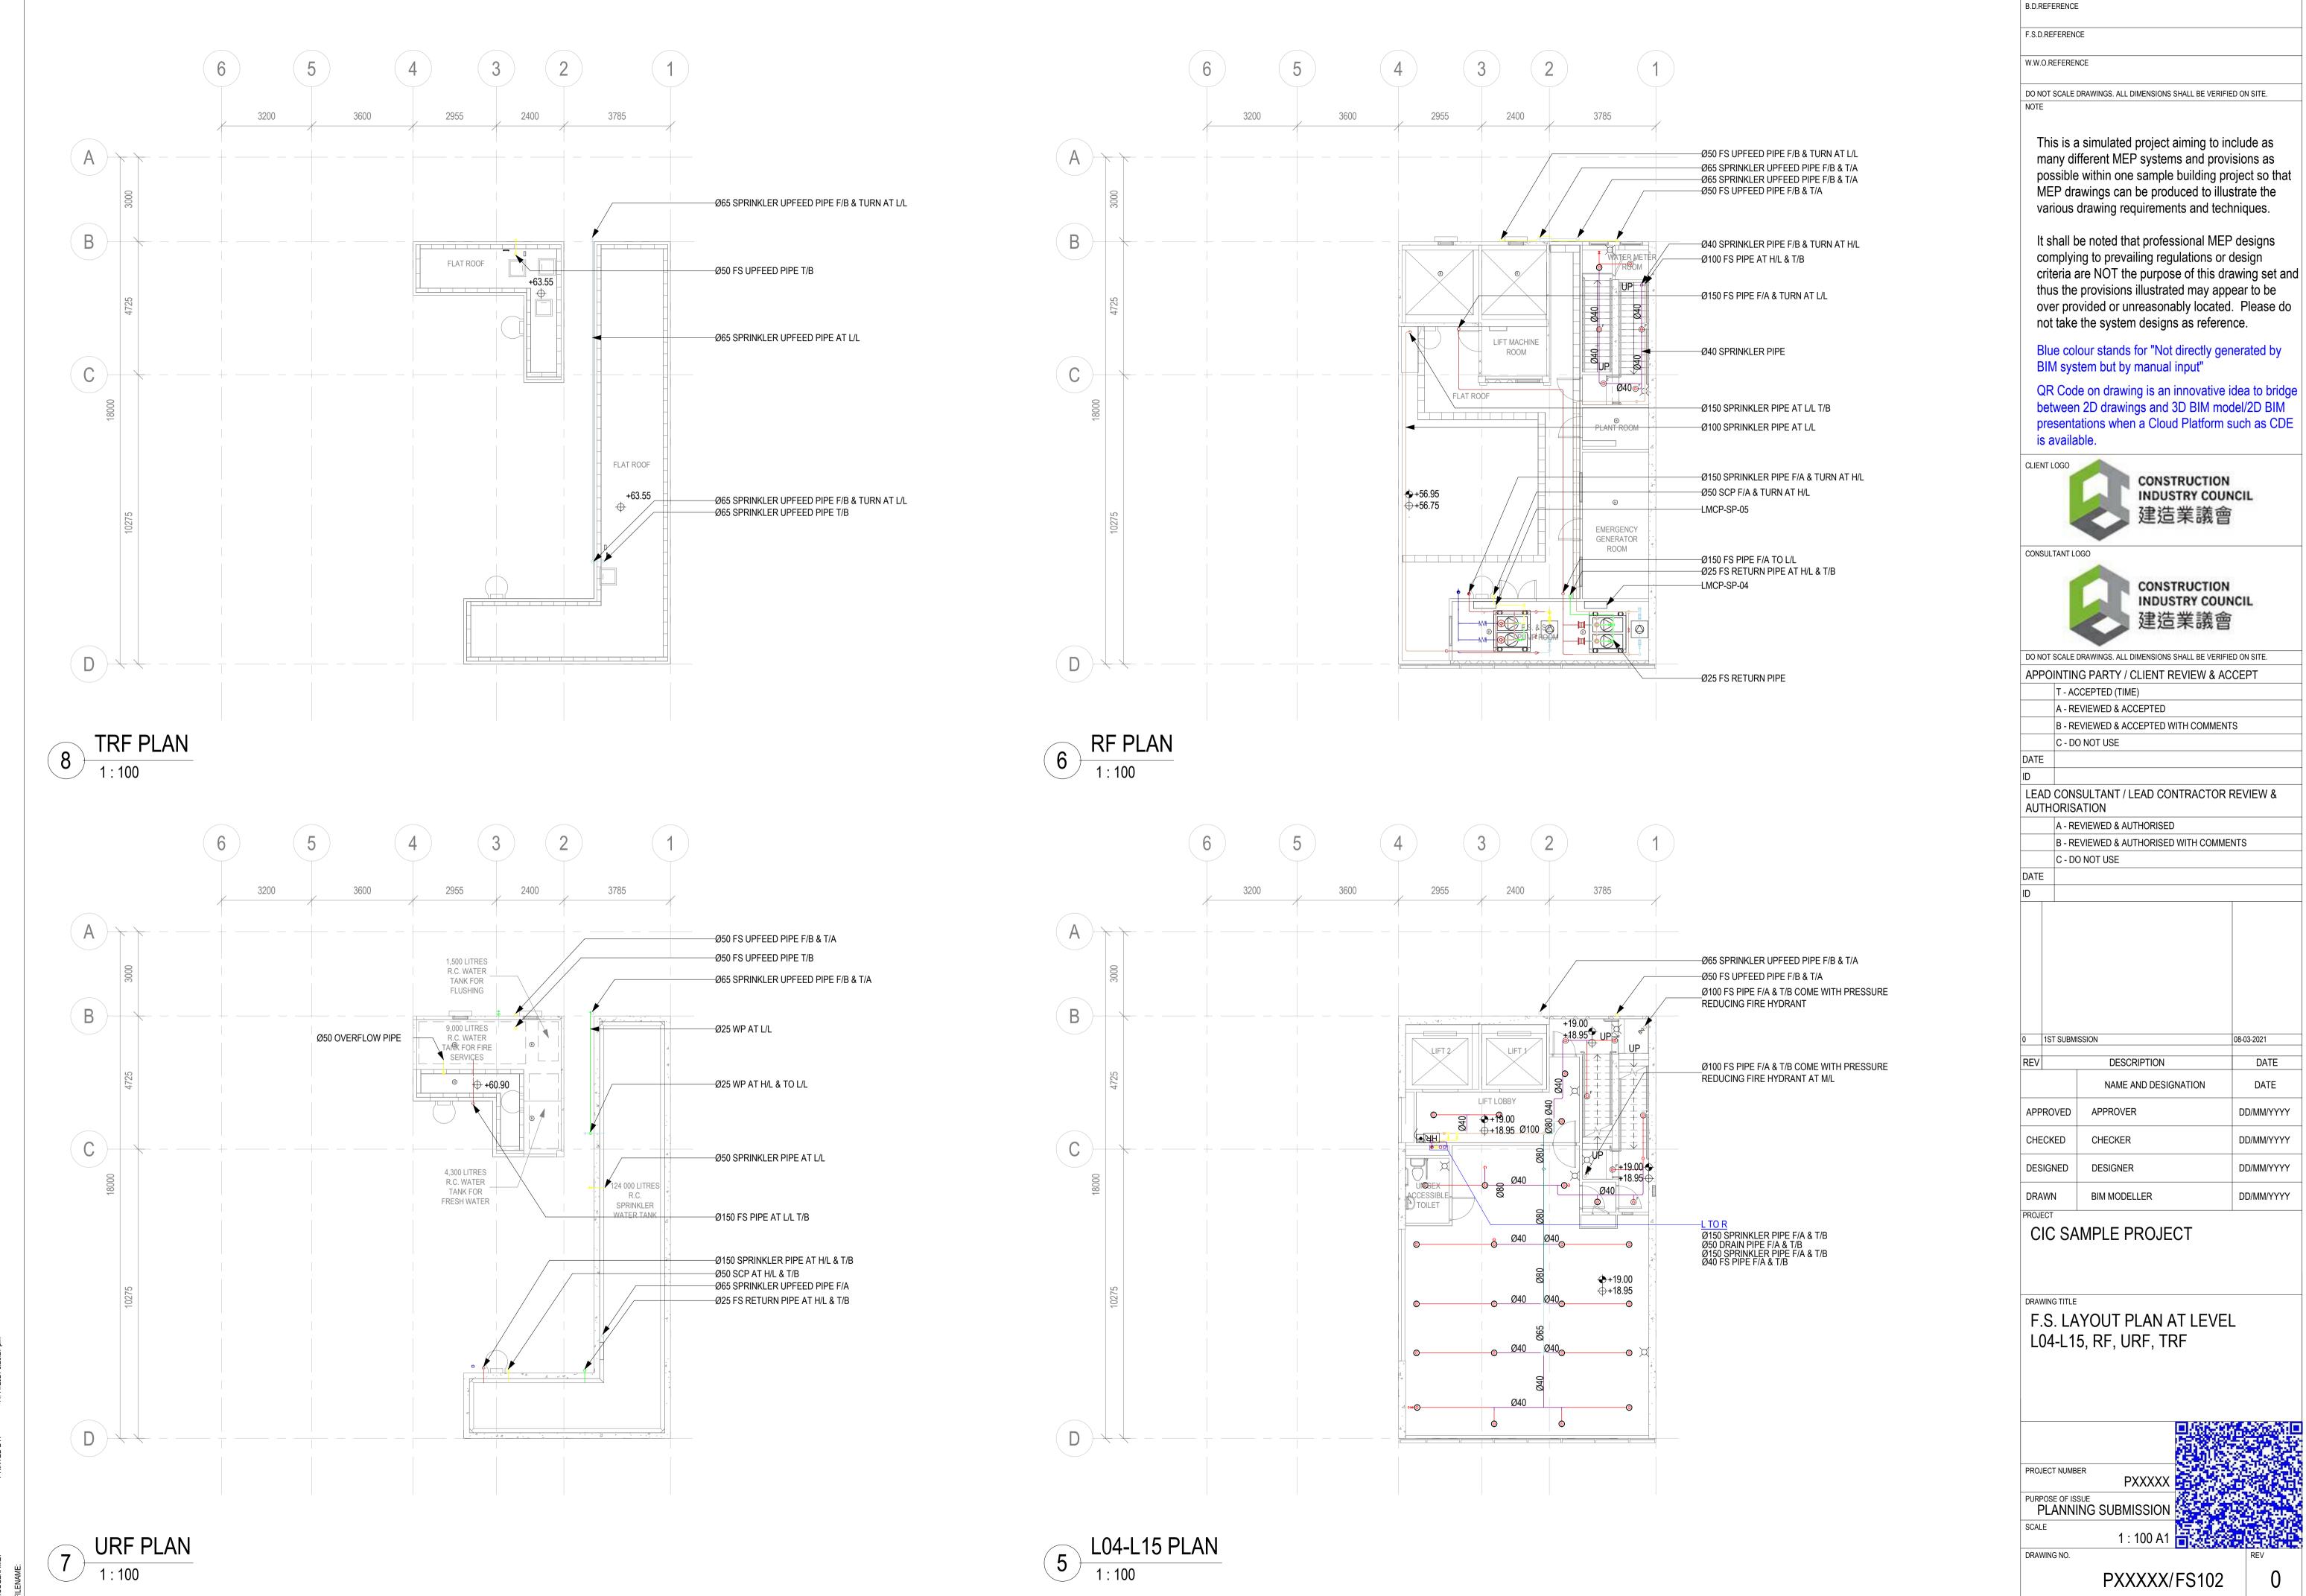

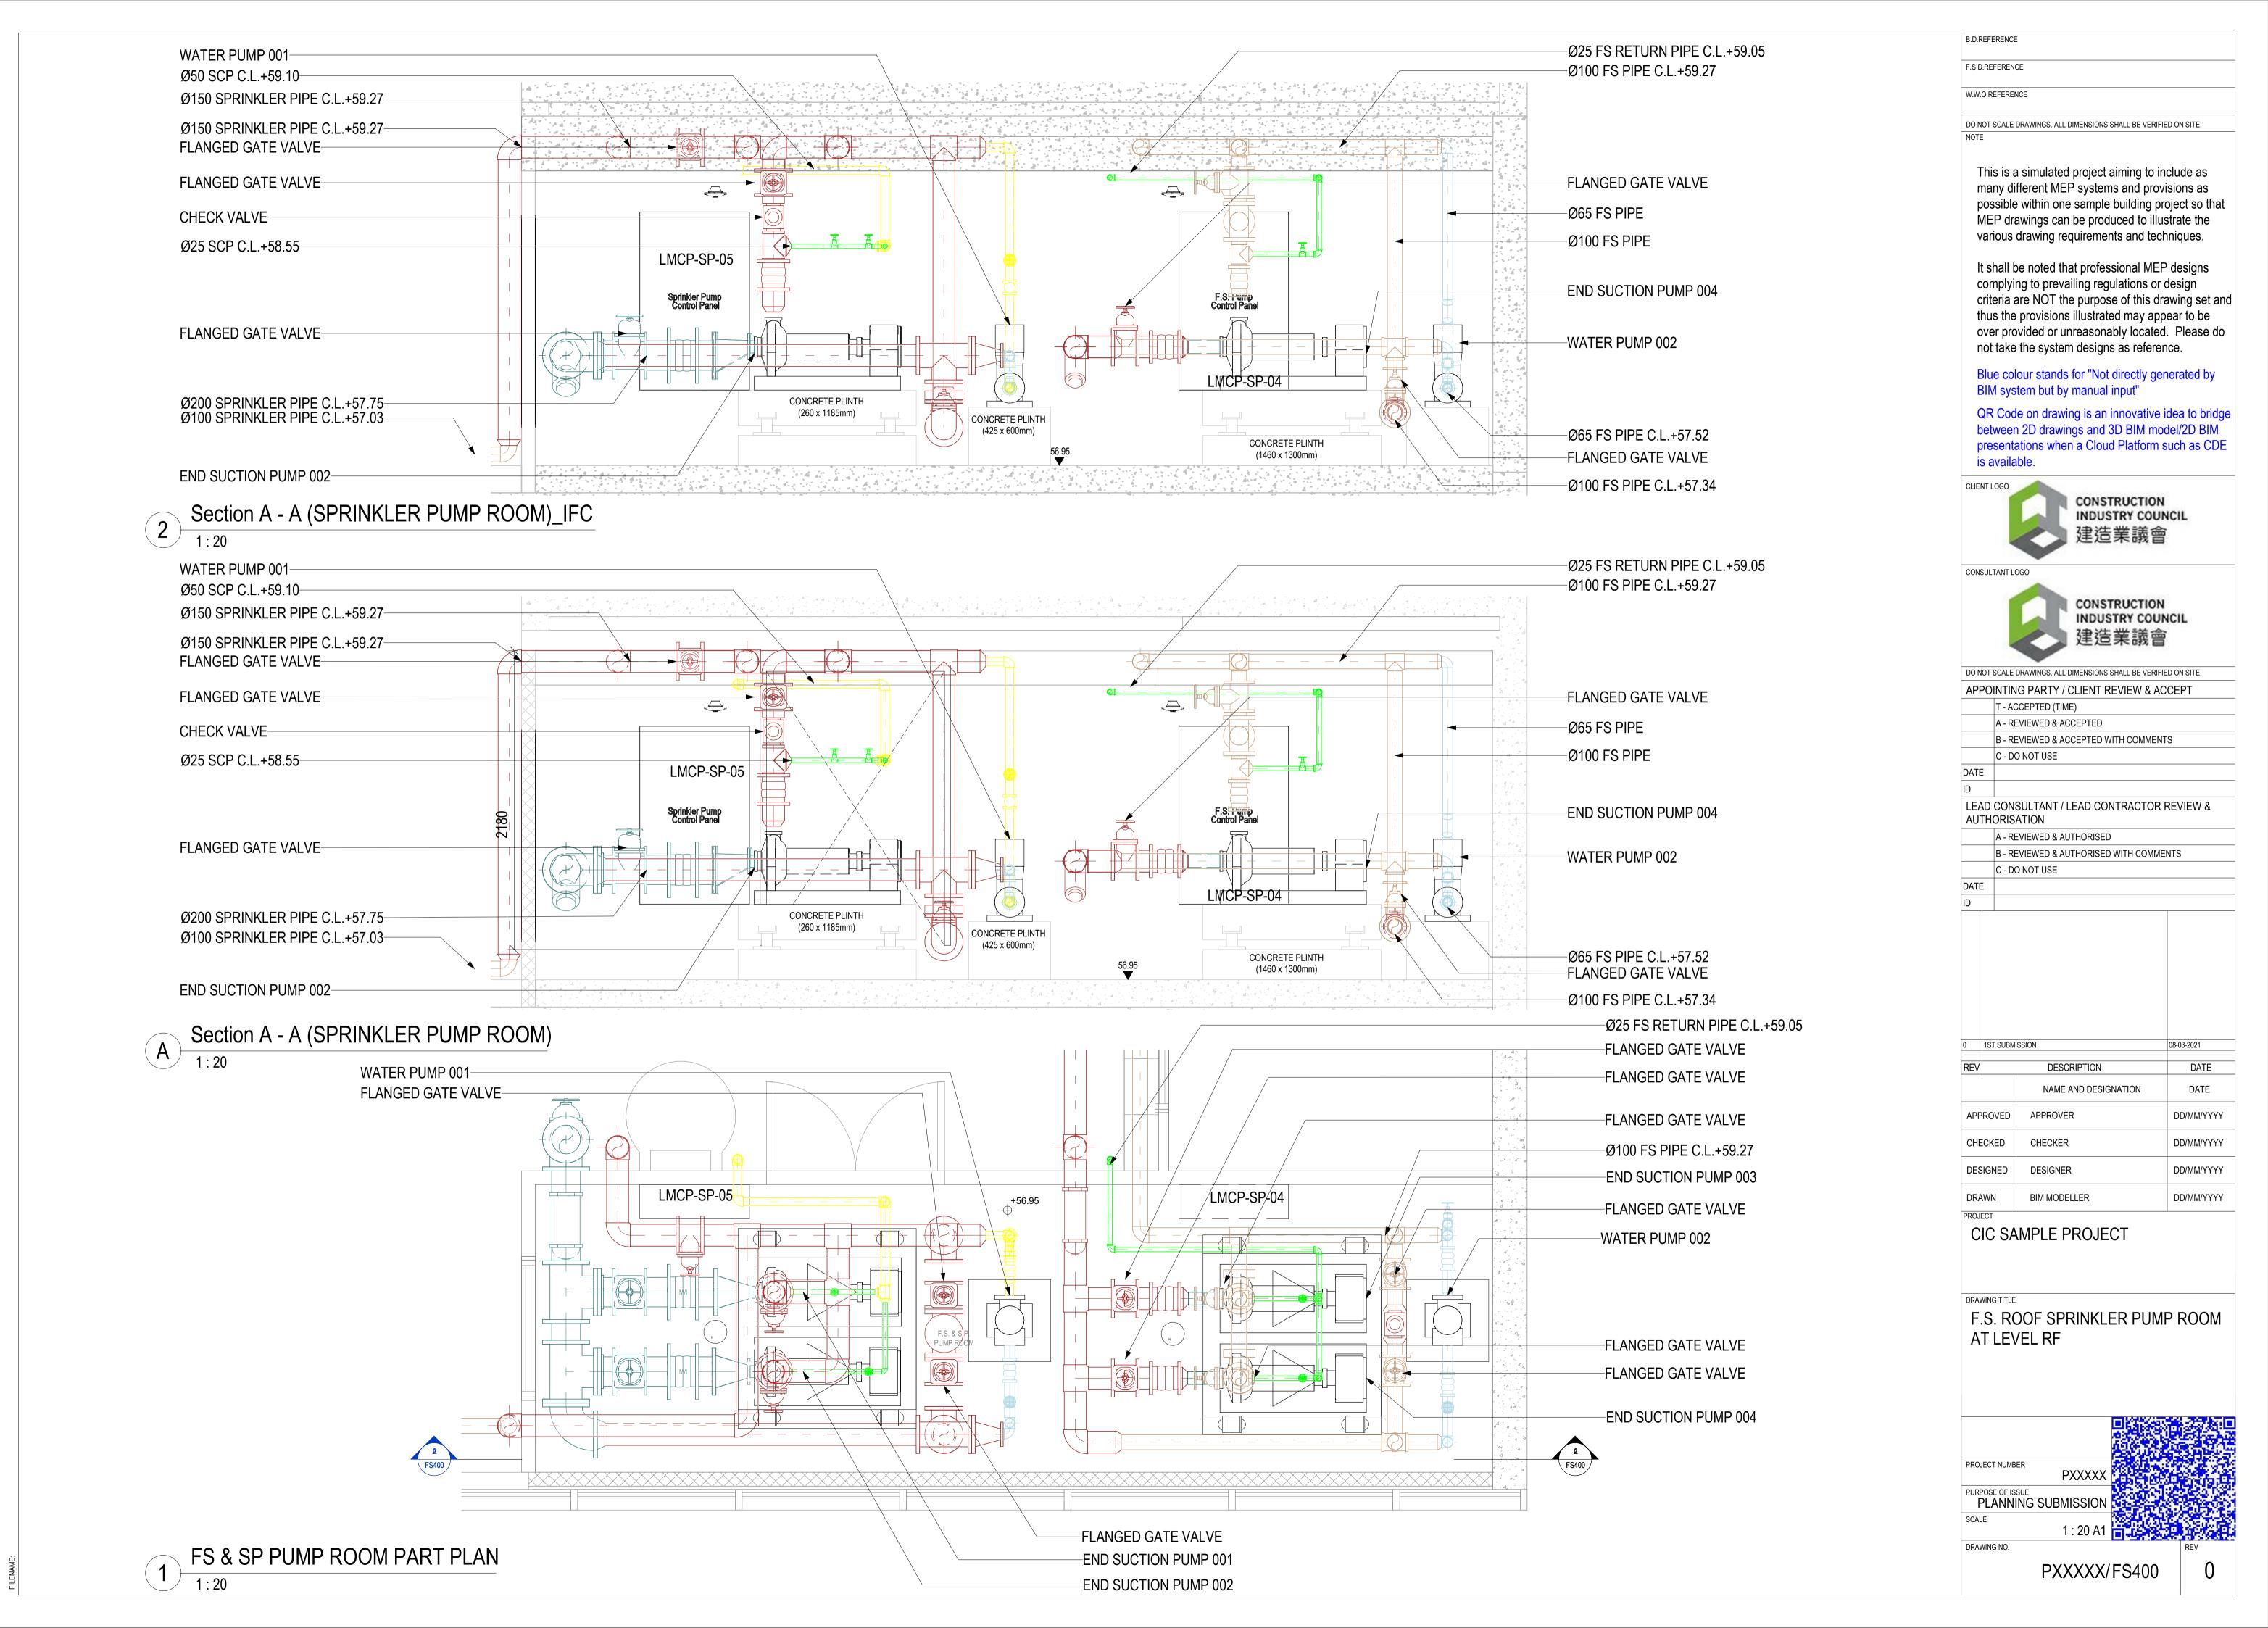


ME:


OELNAME:

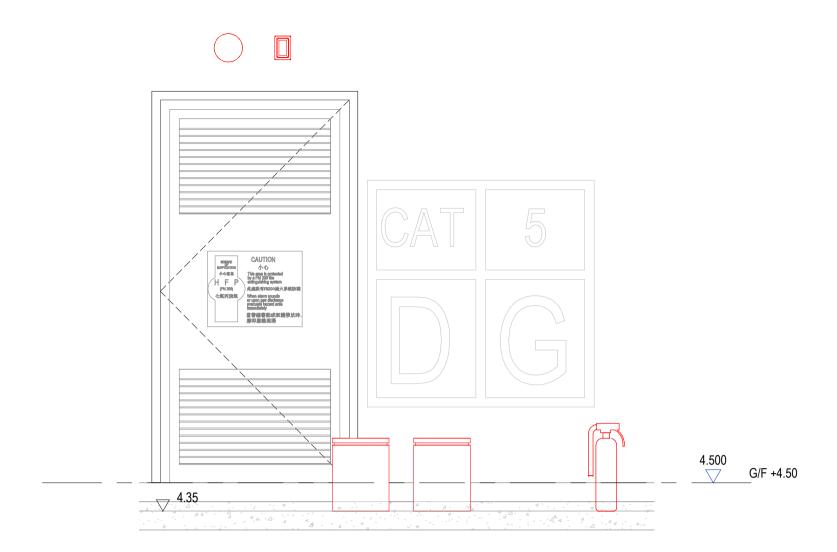



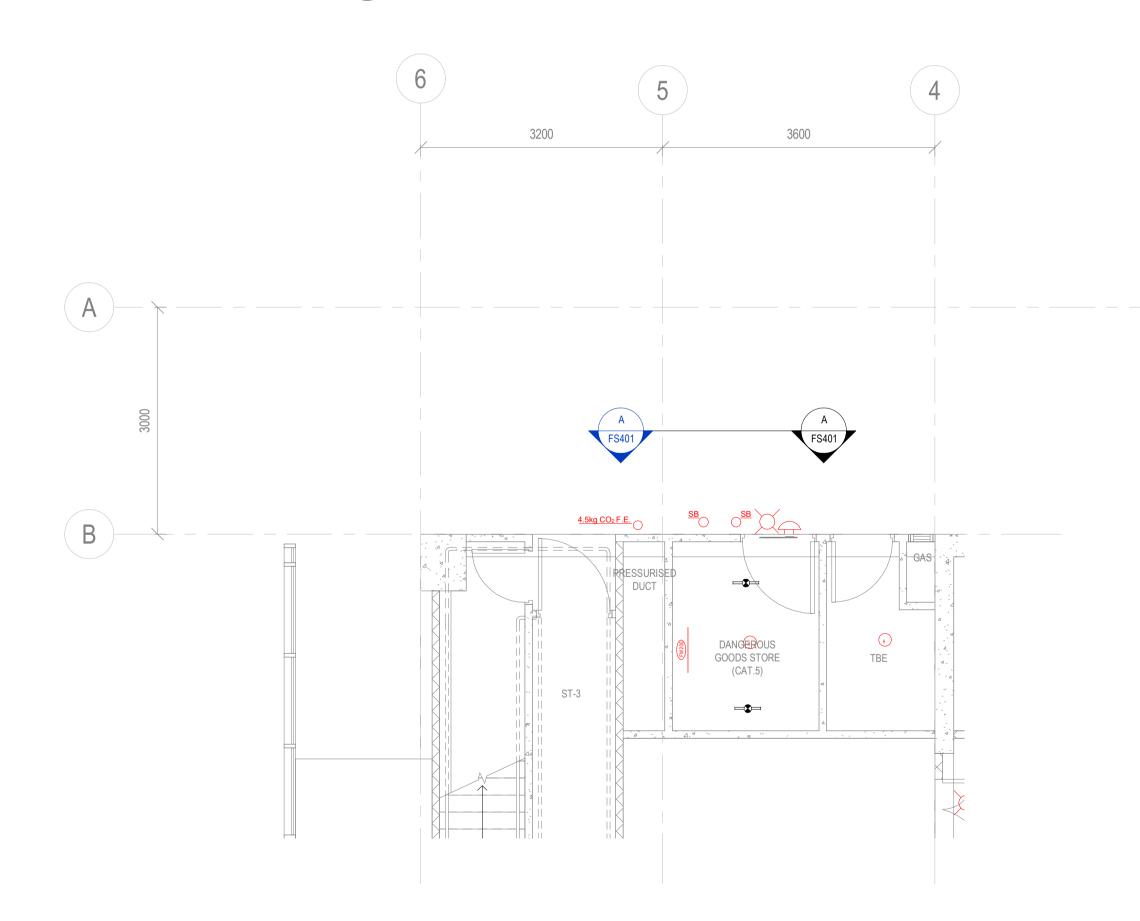

GF DANGEROUS GOOD STORE PART PLAN

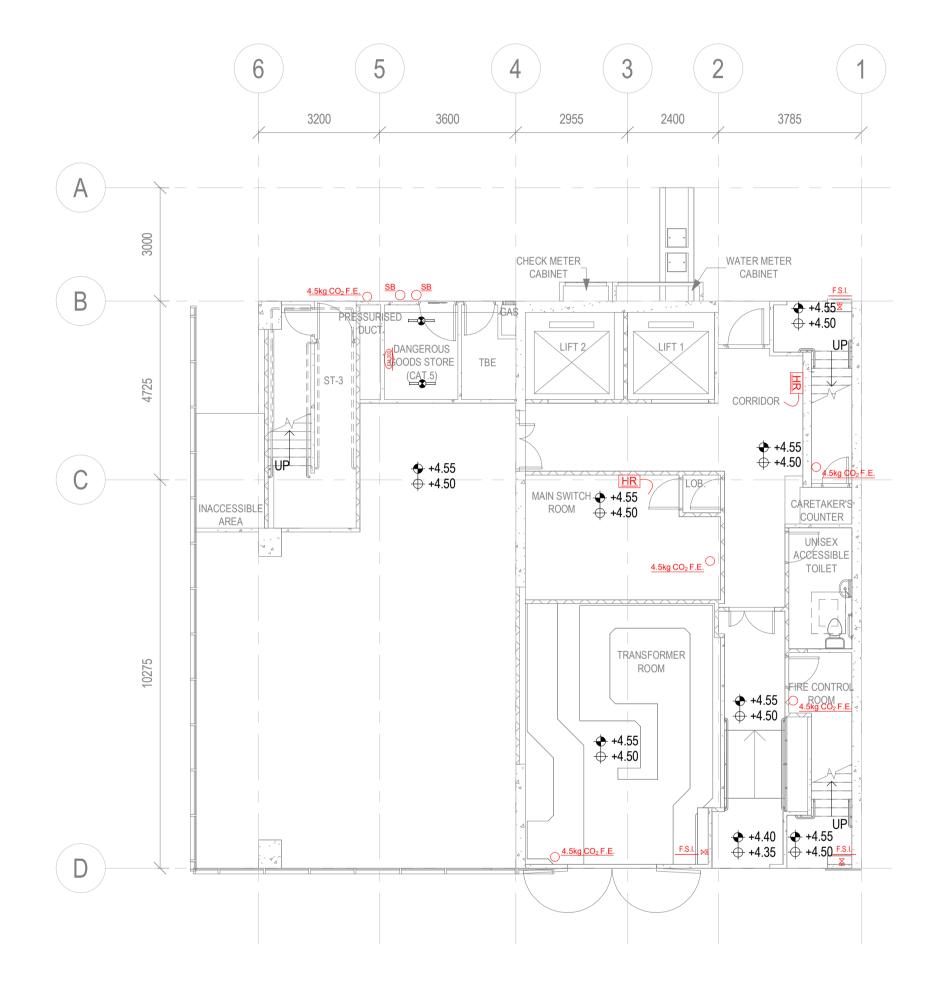

1 GF PLAN
1:100

F.S.D.REFERENCE W.W.O.REFERENCE DO NOT SCALE DRAWINGS. ALL DIMENSIONS SHALL BE VERIFIED ON SITE. This is a simulated project aiming to include as many different MEP systems and provisions as possible within one sample building project so that MEP drawings can be produced to illustrate the various drawing requirements and techniques. It shall be noted that professional MEP designs complying to prevailing regulations or design criteria are NOT the purpose of this drawing set and thus the provisions illustrated may appear to be over provided or unreasonably located. Please do not take the system designs as reference. Blue colour stands for "Not directly generated by BIM system but by manual input" QR Code on drawing is an innovative idea to bridge between 2D drawings and 3D BIM model/2D BIM presentations when a Cloud Platform such as CDE is available. CLIENT LOGO CONSTRUCTION INDUSTRY COUNCIL 建造業議會 CONSULTANT LOGO CONSTRUCTION INDUSTRY COUNCIL 建造業議會 DO NOT SCALE DRAWINGS. ALL DIMENSIONS SHALL BE VERIFIED ON SITE. APPOINTING PARTY / CLIENT REVIEW & ACCEPT T - ACCEPTED (TIME) A - REVIEWED & ACCEPTED B - REVIEWED & ACCEPTED WITH COMMENTS C - DO NOT USE LEAD CONSULTANT / LEAD CONTRACTOR REVIEW & AUTHORISATION A - REVIEWED & AUTHORISED B - REVIEWED & AUTHORISED WITH COMMENTS C - DO NOT USE DATE ID 1ST SUBMISSION 08-03-2021 DESCRIPTION NAME AND DESIGNATION APPROVED DD/MM/YYYY CHECKED CHECKER DD/MM/YYYY DESIGNED DESIGNER DD/MM/YYYY DRAWN **BIM MODELLER** DD/MM/YYYY CIC SAMPLE PROJECT F.S. DANGEROUS GOOD STORE LAYOUT AT LEVEL GF

B.D.REFERENCE

PXXXXX/FS401

PXXXXX


As indicated A1

PURPOSE OF ISSUE PLANNING SUBMISSION


DRAWING NO.

DATE

DATE

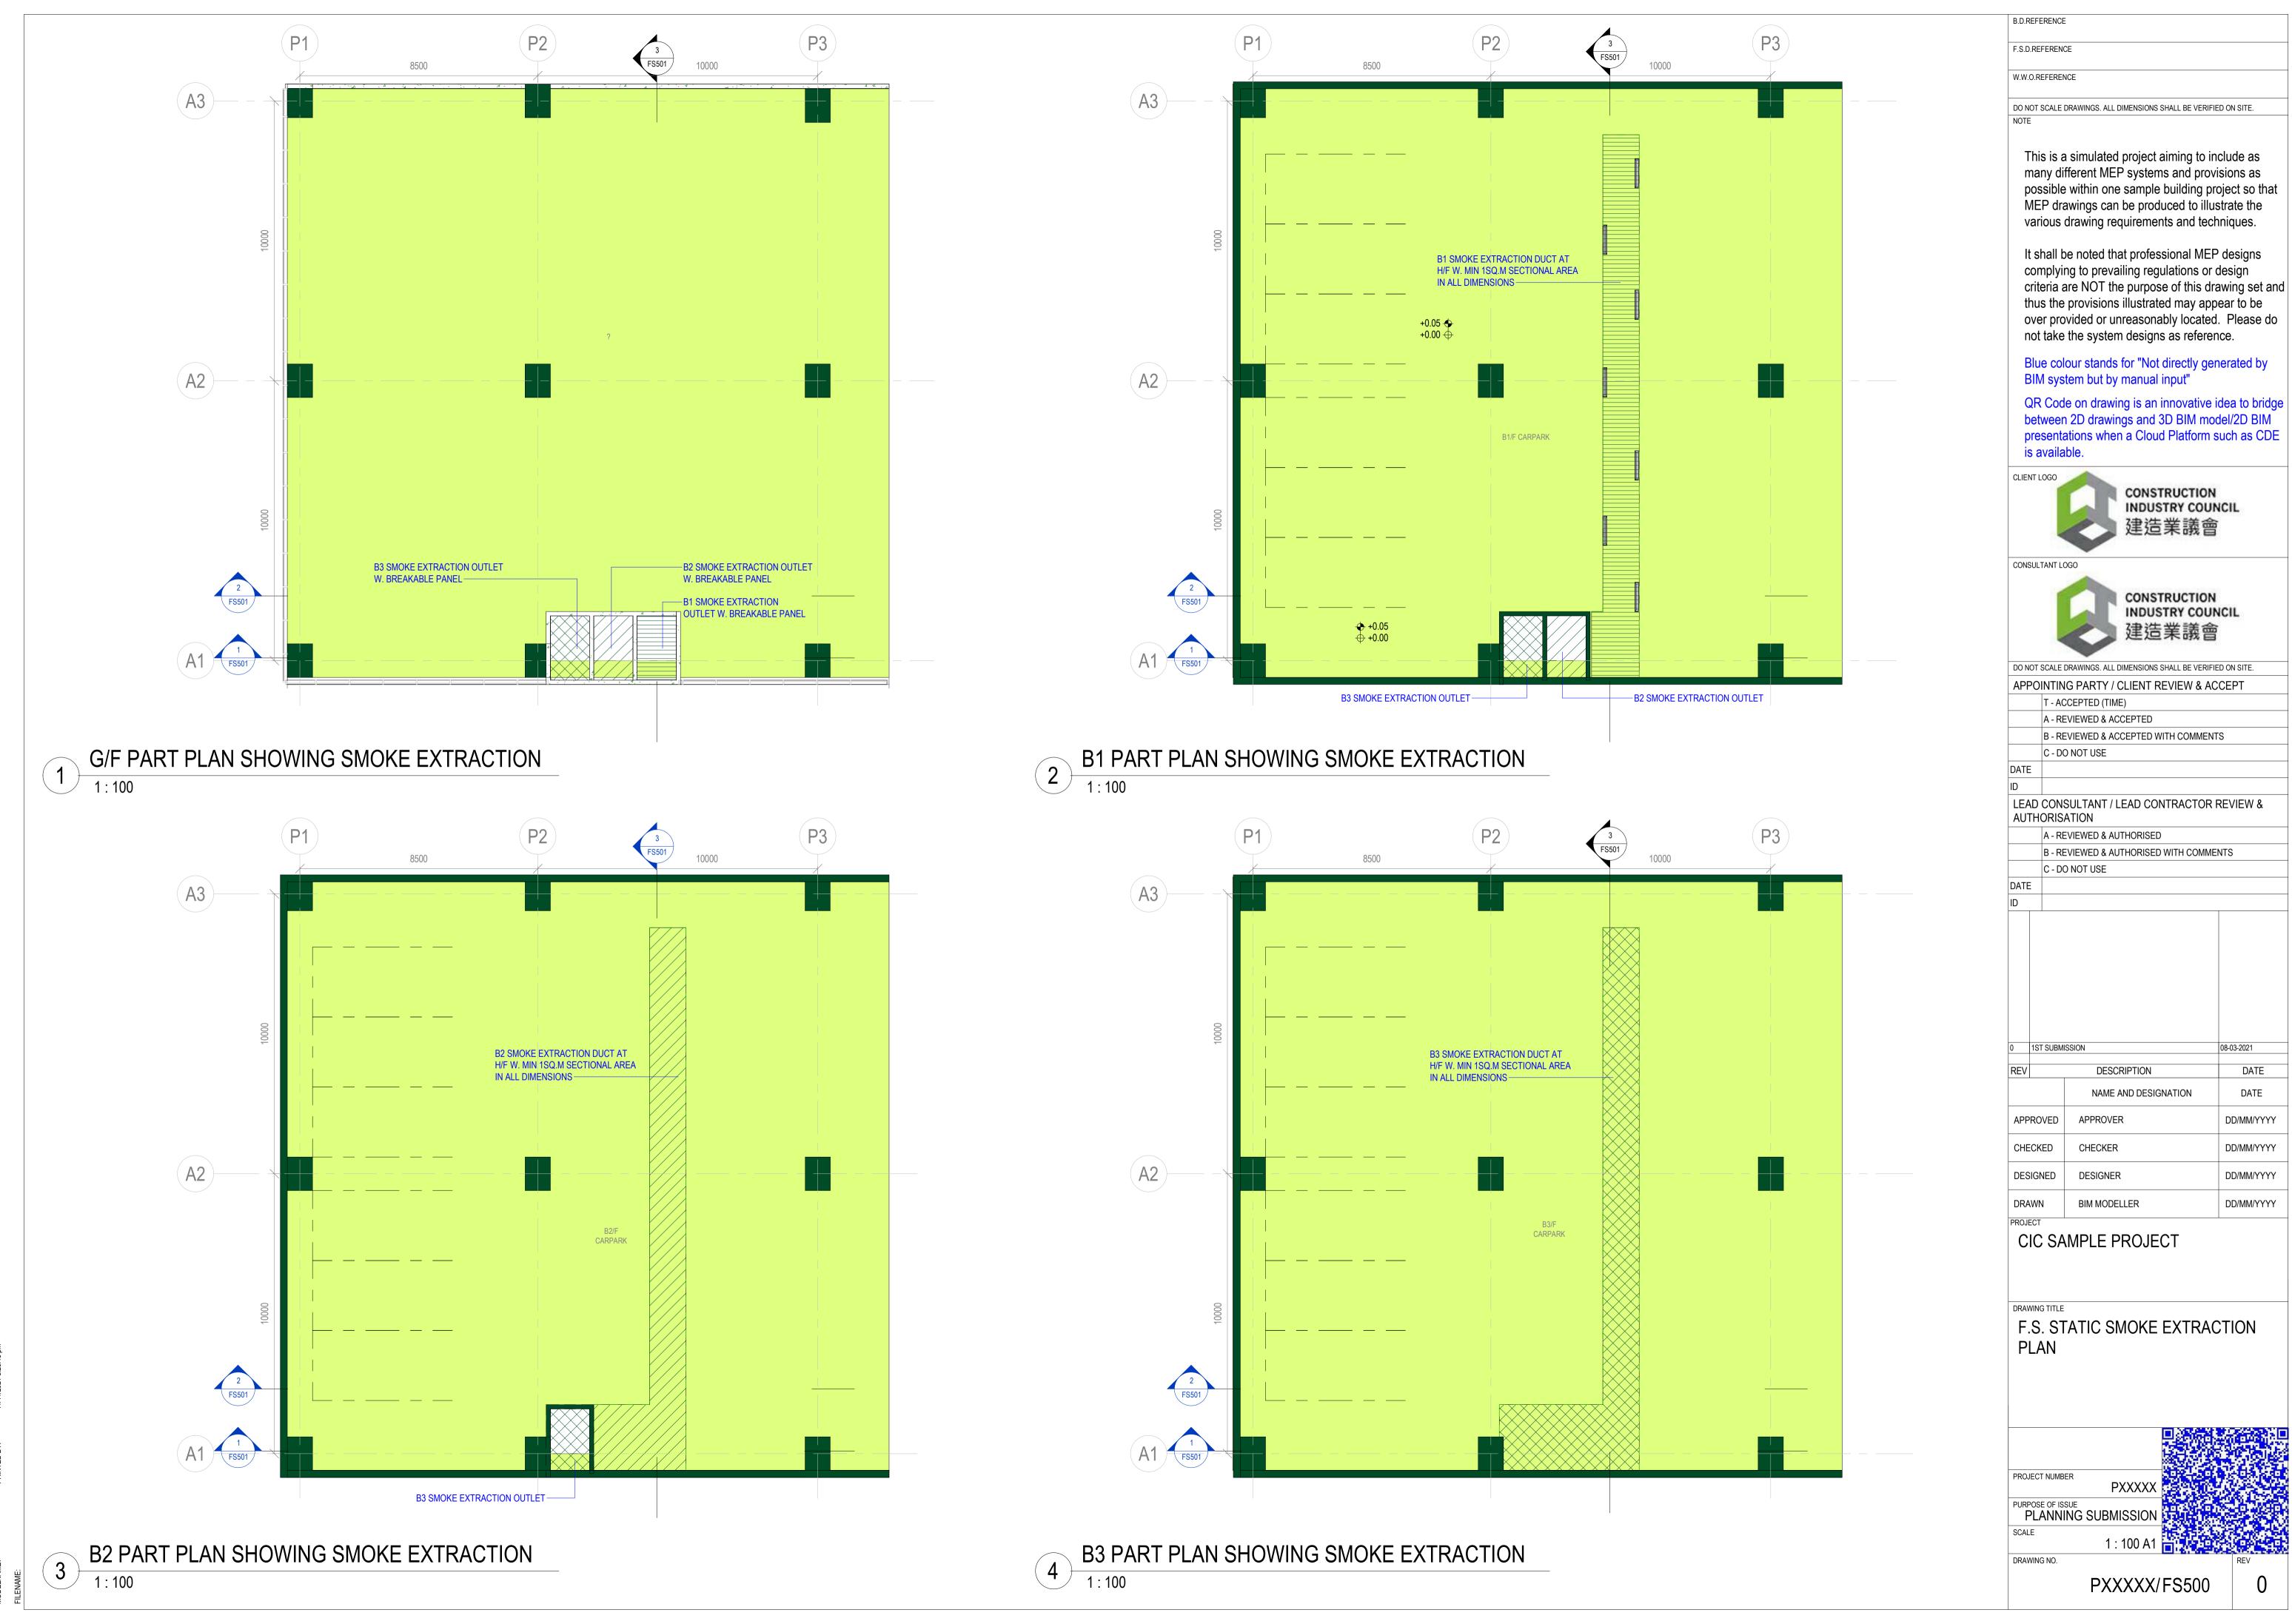

SECTION THROUGH SMOKE EXTRACTION DUCT

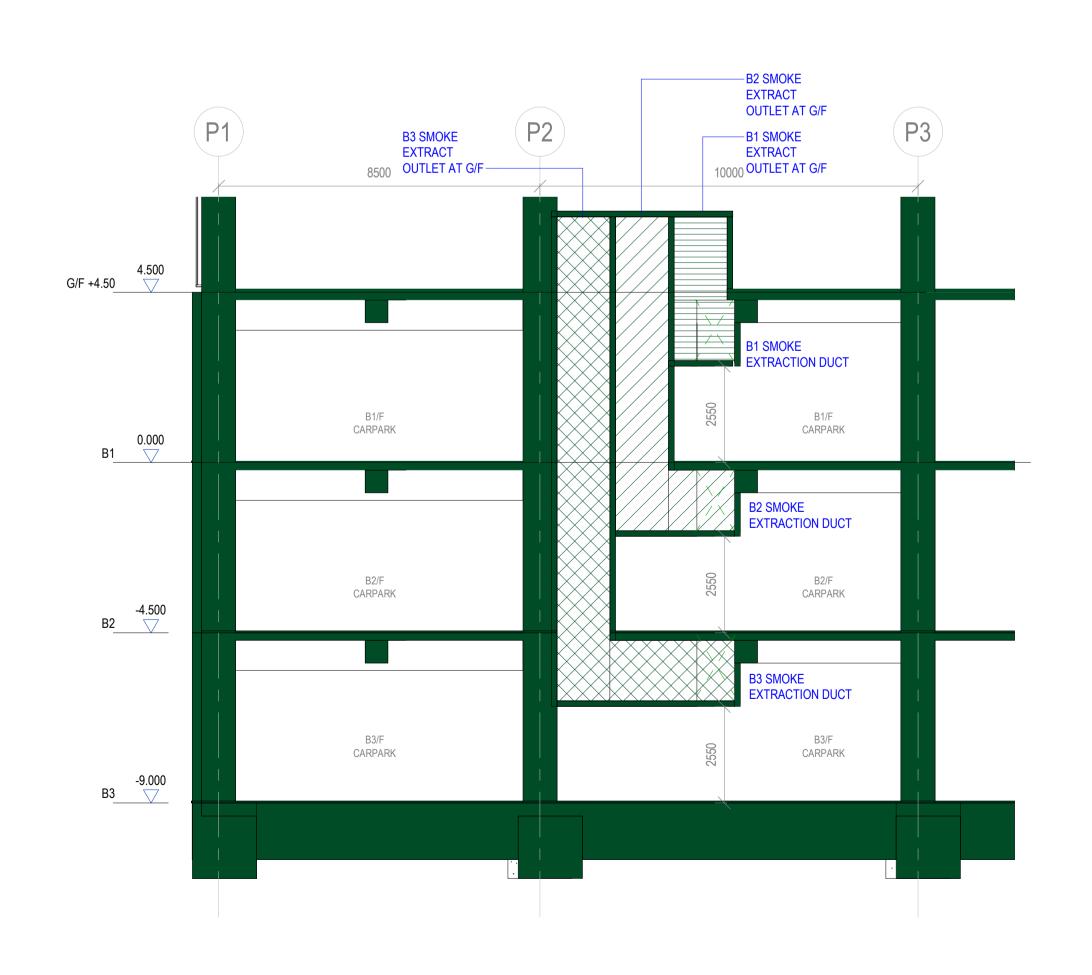

SECTION THROUGH SMOKE EXTRACTION DUCT

G/F +4.50 B1 SMOKE EXTRACTION DUCT -1M X 1M SMOKE B1/F CARPARK **EXTRACTION LOUVRE** 0.000 B1______ B2 SMOKE EXTRACTION DUCT -1M X 1M SMOKE EXTRACTION LOUVRE B2/F CARPARK B3/F CARPARK -1M X 1M SMOKE **EXTRACTION LOUVRE** -9.000 B3

10000

SMOKE EXTRACTION DUCT

OUTLET AT G/F

10000

SECTION THROUGH SMOKE EXTRACTION DUCT

BREAKABLE SMOKE EXTRACTION PANEL AT G/F

F.S.D.REFERENCE W.W.O.REFERENCE DO NOT SCALE DRAWINGS. ALL DIMENSIONS SHALL BE VERIFIED ON SITE.

This is a simulated project aiming to include as many different MEP systems and provisions as possible within one sample building project so that MEP drawings can be produced to illustrate the various drawing requirements and techniques.

B.D.REFERENCE

It shall be noted that professional MEP designs complying to prevailing regulations or design criteria are NOT the purpose of this drawing set and thus the provisions illustrated may appear to be over provided or unreasonably located. Please do not take the system designs as reference.

Blue colour stands for "Not directly generated by BIM system but by manual input"

QR Code on drawing is an innovative idea to bridge between 2D drawings and 3D BIM model/2D BIM presentations when a Cloud Platform such as CDE is available.







DO NOT SCALE DRAWINGS. ALL DIMENSIONS SHALL BE VERIFIED ON SITE. APPOINTING PARTY / CLIENT REVIEW & ACCEPT

AFFOINTING FAILT / CLILINT INLVILW & ACCLET
T - ACCEPTED (TIME)
A - REVIEWED & ACCEPTED
B - REVIEWED & ACCEPTED WITH COMMENTS
C - DO NOT USE
C - DO NOT USE

DATE ID

LEAD CONSULTANT / LEAD CONTRACTOR REVIEW & AUTHORISATION

A - REVIEWED & AUTHORISED B - REVIEWED & AUTHORISED WITH COMMENTS

C - DO NOT USE

DATE ID

REV		DESCRIPTION	DATE
		NAME AND DESIGNATION	DATE
APPRO	VED	APPROVER	DD/MM/YYYY
CHECK	ED	CHECKER	DD/MM/YYYY
DESIGN	NED	DESIGNER	DD/MM/YYYY
DRAWN	ı	BIM MODELLER	DD/MM/YYYY

08-03-2021

1ST SUBMISSION

CIC SAMPLE PROJECT

F.S. STATIC SMOKE EXTRACTION SECTION



PXXXXX/FS501

UNDER GROUND FOR Ø80mm AND ABOVE FOR ABOVE Ø54, (FOR POTABLE WATER) DUCTILE IRON PIPE TO BS EN 545 CLASS K12. STAINLESS STEEL PIPE TO BS 3605 PART 2 IN 316 GRADE. FOR BELOW Ø80mm, FOR Ø54 AND BELOW, (FOR POTABLE WATER) STAINLESS STEEL PIPE TO BS 4127 IN 316 GRADE. STAINLESS STEEL PIPE TO BS EN 10312 (EQUIVALENT BS 4127) SERIES 1 IN GRADE 316 FOR Ø80mm AND ABOVE, (FOR CLEANSING & IRRIGATION) WITH CONCRETE SURROUND. DUCTILE IRON PIPE TO BS EN 545 CLASS K12. FOR BELOW Ø80mm, (FOR CLEANSING & IRRIGATION)

COPPER PIPE TO BS EN 1057, R250 WITH

CAPILLARY JOINTS.

FOR Ø80 AND ABOV

DUCTILE IRON PIPE TO BS

ABOVE GROUND

ALL CONNECTION JOINTS TO BE PAINTED TO MATCH THE INSULATION COLOR.

b. FLUSHING WATER PIPE

UNDER GROUND FOR Ø80mm AND ABOVE DUCTILE IRON PIPE TO BS EN 545 CLASS K12. FOR BELOW Ø80mm,

UNPLASTICISED POLYVINYL CHLORIDE (uPVC) PIPE TO ISO 4422 : PART 1 & PART 2, (EQUIVALENT BS 3505). CLASS D OR ABOVE WITH FITTING TO ISO 4422: CLASS D OR ABOVE WITH FITTING TO 150 4422 PART 3 (EQUIVALENT BS 4346) WITH 150mm PART 3 (EQUIVALENT BS 4346). MINIMUM THICKNESS OF CONCRETE SURROUND.

ACTUAL INLET LEVEL FOR WATER STORAGE TANKS TO BE DECIDED ON SITE.

c. FIRE SERVICE WATER PIPE

ABOVE GROUND
HOT DIP ZINC COATED GALVANIZED STEEL PIPE DUCTILE IRON PIPE TO BS EN 545 CLASS K12. TO BS EN 10255. 3. WATER POINT(S) FOR PLANTER TO BE PROVIDED WITH LOCKING DEVICE AND INSTALLED AT 1000mm HIGH ABOVE GROUND LEVEL

5. ALL WATER METERS TO BE SITED ABOVE GROUND LEVEL HORIZONTALLY AND SUPPLY PIPES BEFORE THE METERS AT GROUND LEVEL TO BE LAID IN EXPOSED MANNER. 6. ALL WATER METERS TO BE LOCATED IN BETWEEN 300mm TO 1500mm ABOVE GROUND LEVEL.

THE LOCATION OF BRANCH VALVES AND THE CONTROL VALVES SERVING THE GROUP OF SUPPLY POINTS TO BE REFERRED TO SCHEMATIC DIAGRAM OF WATER SUPPLY. 8. NO WATER PIPE SHALL BE EMBEDDED IN LOAD BEARING STRUCTURAL ELEMENTS SUCH AS COLUMNS, BEAMS AND SLABS IN

9. THE WATER PIPES THROUGH STRUCTURAL ELEMENTS TO BE PROTECTED BY SLEEVING WITH PROPRIETARY FIRE STOP OF 2 HOURS

FIRE RESISTANCE PERIOD (F.R.P.). 10. ALL PIPES BRANCH OFF FROM PIPE DUCT MUST BE PROVIDED WITH FIRE RESISTANCE COLLAR.

11. ALL EXPOSED PIPES TO BE PAINTED WITH THE COLOUR MATCHED TO WALLS OR CEILINGS. 12. MATCHING COVER FOR VALVE PITS TO BE 450x450mm CLEAR OPENING HEAVY DUTY GALVANISED MILD STEEL DOUBLE SEAL RECESSED COVER & FRAME FOR 60mm TH. BLOCK PAVIOR INFILL TO SUIT GALVANISED TO 11.5 TONNES SLOW MOVING WHEEL LOADS (SMWL), BS

729 AND WITH STAINLESS STEEL LABEL SHOWING AT THE CORNER (TO BE ADVISED BY SUPERVISOR OFFICER). 13. INDIVIDUAL STOP VALVES SHALL BE PROVIDED AT ALL DRAW-OFF POINTS OR AT A SERIES OF DRAW-OFF POINTS IF SITUATED CLOSE

14. VALVE: PIPES GREATER THAN (OR EQUAL) Ø50mm GATE VALVE TO BE USED, LESS THAN Ø50mm STOP COCK TO BE USED, UNLESS OTHERWISE SPECIFIED.

15. DRAIN-OFF PIPES AT ALL WATER STORAGE TANKS SHOULD BE PROPERLY PLUGGED OFF.

16. EXCEPT PLANT ROOM AREAS, ALL PLUMBING PIPES UNLESS INSTALLED WITHIN FALSE CEILING, LEDGE WALL OR PIPE DUCTS, TO BE EMBEDDED IN NON-STRUCTURAL WALLS OR FLOOR SCREED WHENEVER PRACTICABLE.

17. FIBREGLASS WATER TANK TO BE MADE OF NON-TOXIC MATERIAL AND APPROVED BY WSD.

18. ALL OVERFLOW PIPES AND Ø25 WARNING PIPE TO WATER TANKS TO BE uPVC PIPE AND TO BE PROVIDED WITH A SELF-CLOSING NON-RETURN FLAP AT THE END OF THE PIPES. ALL WARNING PIPE SHALL BE EXTENDED TO OUTSIDE THE PUMP ROOM FOR SUMP CISTERN AND DISCHARGE OVERFLOW WATER TO A CONSPICUOUS POSITION IN A COMMUNAL AREA EASILY VISIBLE AND ACCESSIBLE BY THE

19. WHERE NECESSARY A WARNING PIPE MAY BE INSTALLED IN ADDITION TO AN OVERFLOW PIPE TO CONSPICUOUS POSITION. WARNING PIPE MUST COMPLY WITH ALL OTHER REQUIREMENTS OF AN OVERFLOW PIPE.

20. OPENINGS LEFT IN FIRE RATED WALLS/FLOOR SLABS AFTER CONSTRUCTION OF PIPES AND PIPE SLEEVE PENETRATING THROUGH SUCH WALLS & FLOORS TO BE BACK FILLED WITH APPROVED FIRE RESISTANT MATERIAL TO MAINTAIN THE REQUIRED FRP OF THAT WALL OR

21. THE ACTUAL TEE CONNECTION TO WSD MAINS IS CARRIED OUT BY WATER SUPPLIES DEPARTMENT (WSD)

22. PIPE EXPANSION JOINTS WHETHER OR NOT SHOWN ON THE DRAWINGS SHALL BE PROVIDED FOR ANY PIPES ACROSS BUILDING EXPANSION JOINT. THE CONTRACTOR SHALL VERIFY THE EXACT LOCATION OF BUILDING EXPANSION JOINT ON SITE.

23. EXPANSION JOINTS FOR CABLE CONTAINMENT WHETHER OR NOT SHOWN ON THE DRAWINGS SHALL BE PROVIDED FOR ANY CABLE

CONTAINMENT ACROSS BUILDING EXPANSION JOINT. THE CONTRACTOR SHALL VERIFY THE EXACT LOCATION OF BUILDING EXPANSION

ABBREVIATION

OVERFLOW PIPE

AUTOMATIC AIR VENTILATION

FLOOR SLAB.

FROM BELOW TO ABOVE FOR REFERENCE ONLY N.R.V. LOW LEVEL LOOSE JUMPER TYPE STOPCOCK **UNDER SLAB** P.R.V. PRESSURE REDUCING VALVE

S.C.


F/A

	DRAWING LIST_WS		
DRAWING NUMBER	DRAWING TITLE	REVISION	
PL001	LEGENDS, ABBREVIATION AND GENERAL NOTES	0	
PL100	SCHEMATIC	0	
PL101	PLUMBING LAYOUT PLAN AT LEVEL GF, L01, L02, L03	0	
PL102	PLUMBING LAYOUT PLAN AT LEVEL L04-L15, RF, URF, TRF	0	
PL400	ARRANGMENT OF WATER METER CABINET ATLEVEL GF & RF	0	
PL401	PLUMBING PUMP SERVICES AT L01	0	

FROM ABOVE

STOP COCK

LEGEND

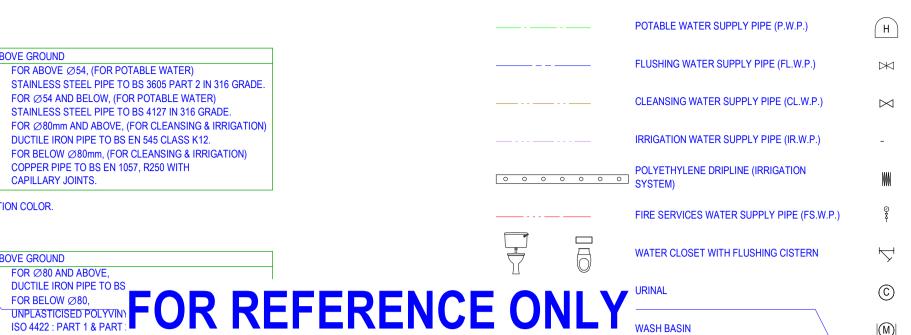

CLEANERS SINK/ MOK WATER DISPENSER WATER TAP LOCKABLE WATER TAP FOR CLEANSING LOCKABLE WATER POINT FOR PLANTER WITH ANTI-VACUUM VALVE AT HIGHEST POINT AND TO BE SITED WITH ITS OUTLET AT LEAST 1m ABOVE GROUND/SOIL LEVEL. LOCKABLE HOSE

AUTOMATIC FLOATING SWITCH

LOOSE JUMPER TYPE STOPCOCK AUTOMATIC AIR RELIEF VALVE C/W Ø20 ISOLATION GATE VALVE **DOUBLE CHECK VALVE** REEL BOX TO BE PROVIDED ASIDE.

INSTANTANEOUS TYPE ELECTRIC UNDERSINK

NON-RETURN VALVE / CHECK VALVE

WATER HEATER (6kW)

FLEXIBLE CONNECTOR

Y-TYPE STRAINER

CHECK METER POSITION

WATER METER (WSD)

FLOW METER

2-WAY MOTORIZED ON-OFF VALVE,

ELECTRICALLY OPERATED C/W DDC CONTROL


PRESSURE GAUGE WITH COCK

STOP COCK

HWL o LEVEL SWITCH PPCOL



LOCATION PLAN

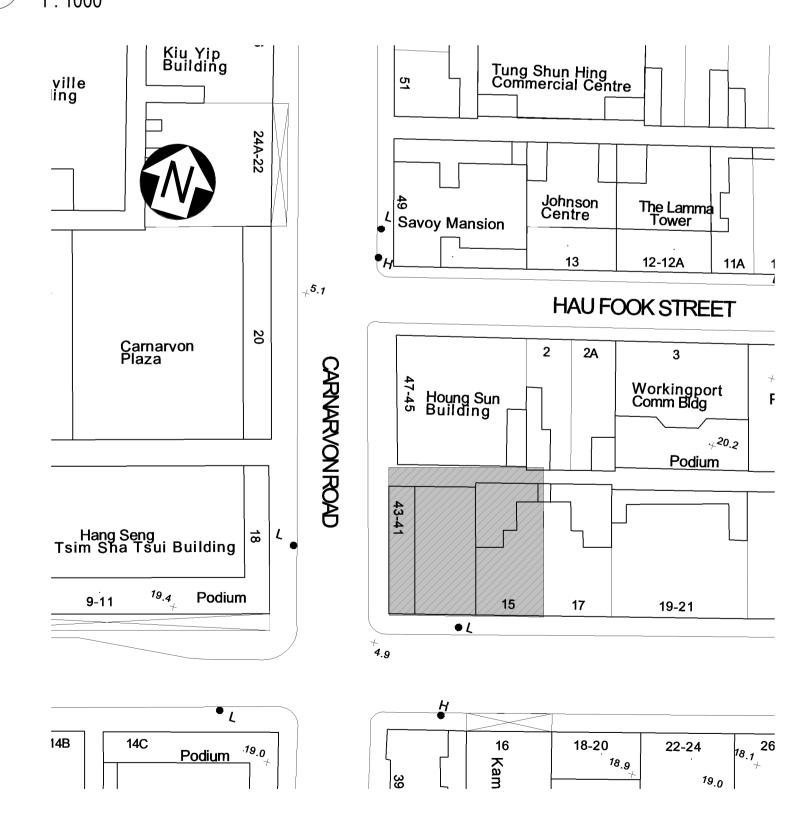

2 SITE PLAN 1:500

B.D.REFERENCE F.S.D.REFERENCE W.W.O.REFERENCE

DO NOT SCALE DRAWINGS. ALL DIMENSIONS SHALL BE VERIFIED ON SITE.

This is a simulated project aiming to include as many different MEP systems and provisions as possible within one sample building project so that MEP drawings can be produced to illustrate the various drawing requirements and techniques.

It shall be noted that professional MEP designs complying to prevailing regulations or design criteria are NOT the purpose of this drawing set and thus the provisions illustrated may appear to be over provided or unreasonably located. Please do not take the system designs as reference.

Blue colour stands for "Not directly generated by BIM system but by manual input"

QR Code on drawing is an innovative idea to bridge between 2D drawings and 3D BIM model/2D BIM presentations when a Cloud Platform such as CDE is available.







	DO NOT	SCALE DRAWINGS. ALL DIMENSIONS SHALL BE VERIFIED ON SITE.
	APPO	INTING PARTY / CLIENT REVIEW & ACCEPT
		T - ACCEPTED (TIME)
Winfield		A - REVIEWED & ACCEPTED
<u> </u>		B - REVIEWED & ACCEPTED WITH COMMENTS
		C - DO NOT USE

DATE	
ID	
	CONSULTANT / LEAD CONTRACTOR REVIEW & ORISATION

	A - REVIEWED & AUTHORISED
	B - REVIEWED & AUTHORISED WITH COMMENTS
	C - DO NOT USE
DATE	


0	1ST SUBM	ISSION	08-03-2021
REV		DESCRIPTION	DATE
		NAME AND DESIGNATION	DATE
APP	ROVED	APPROVER	DD/MM/YYYY
CHE	ECKED	CHECKER	DD/MM/YYYY

APPROVED	APPROVER	DD/MM/YYYY
CHECKED	CHECKER	DD/MM/YYYY
DESIGNED	DESIGNER	DD/MM/YYYY
DRAWN	BIM MODELLER	DD/MM/YYYY
PROJECT		
CIC SA	MPLE PROJECT	

DRAWING TITLE
LEGENDS, ABBREVIATION AND
GENERAL NOTES

PROJECT NUMBER PXXXXX		
PURPOSE OF ISSUE PLANNING SUBMISSION		
SCALE As indicated A1		
DRAWING NO.		REV
DVVVV/	DI 001	\cap


PXXXXX/PL001

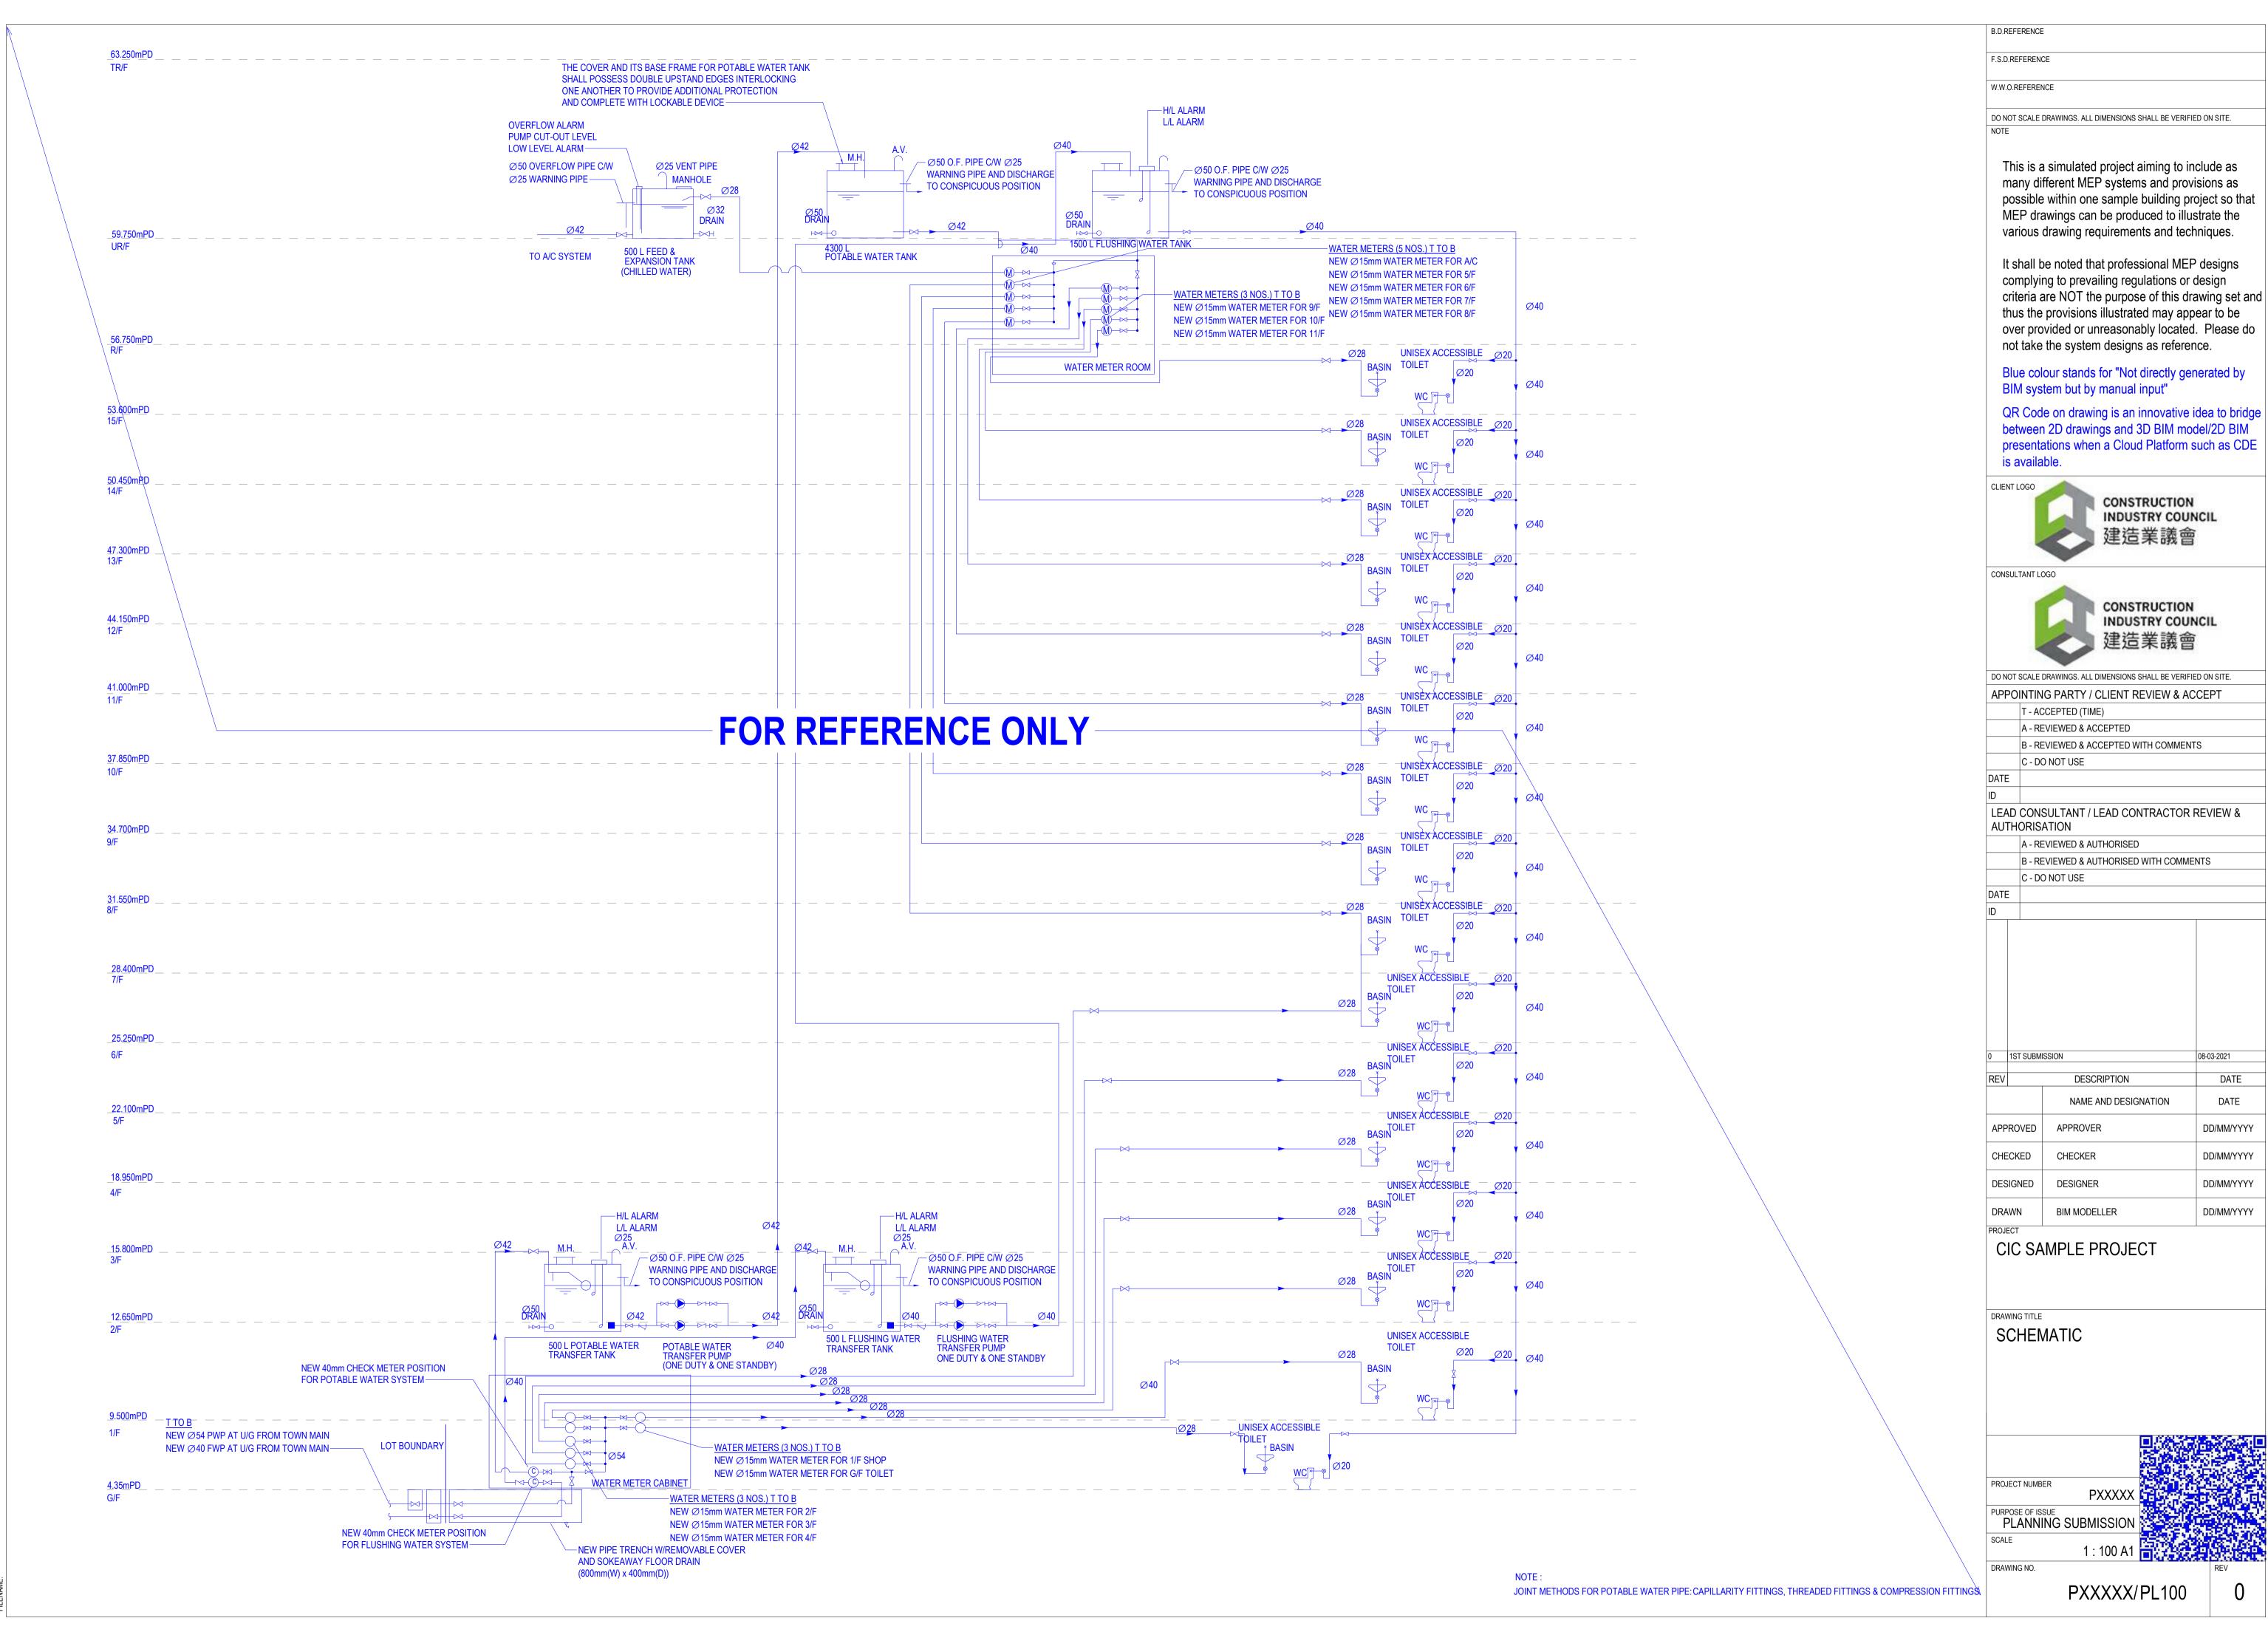

.Y: 11/11/2021 5:30:00


PRINTED BY:

MODELNAME:

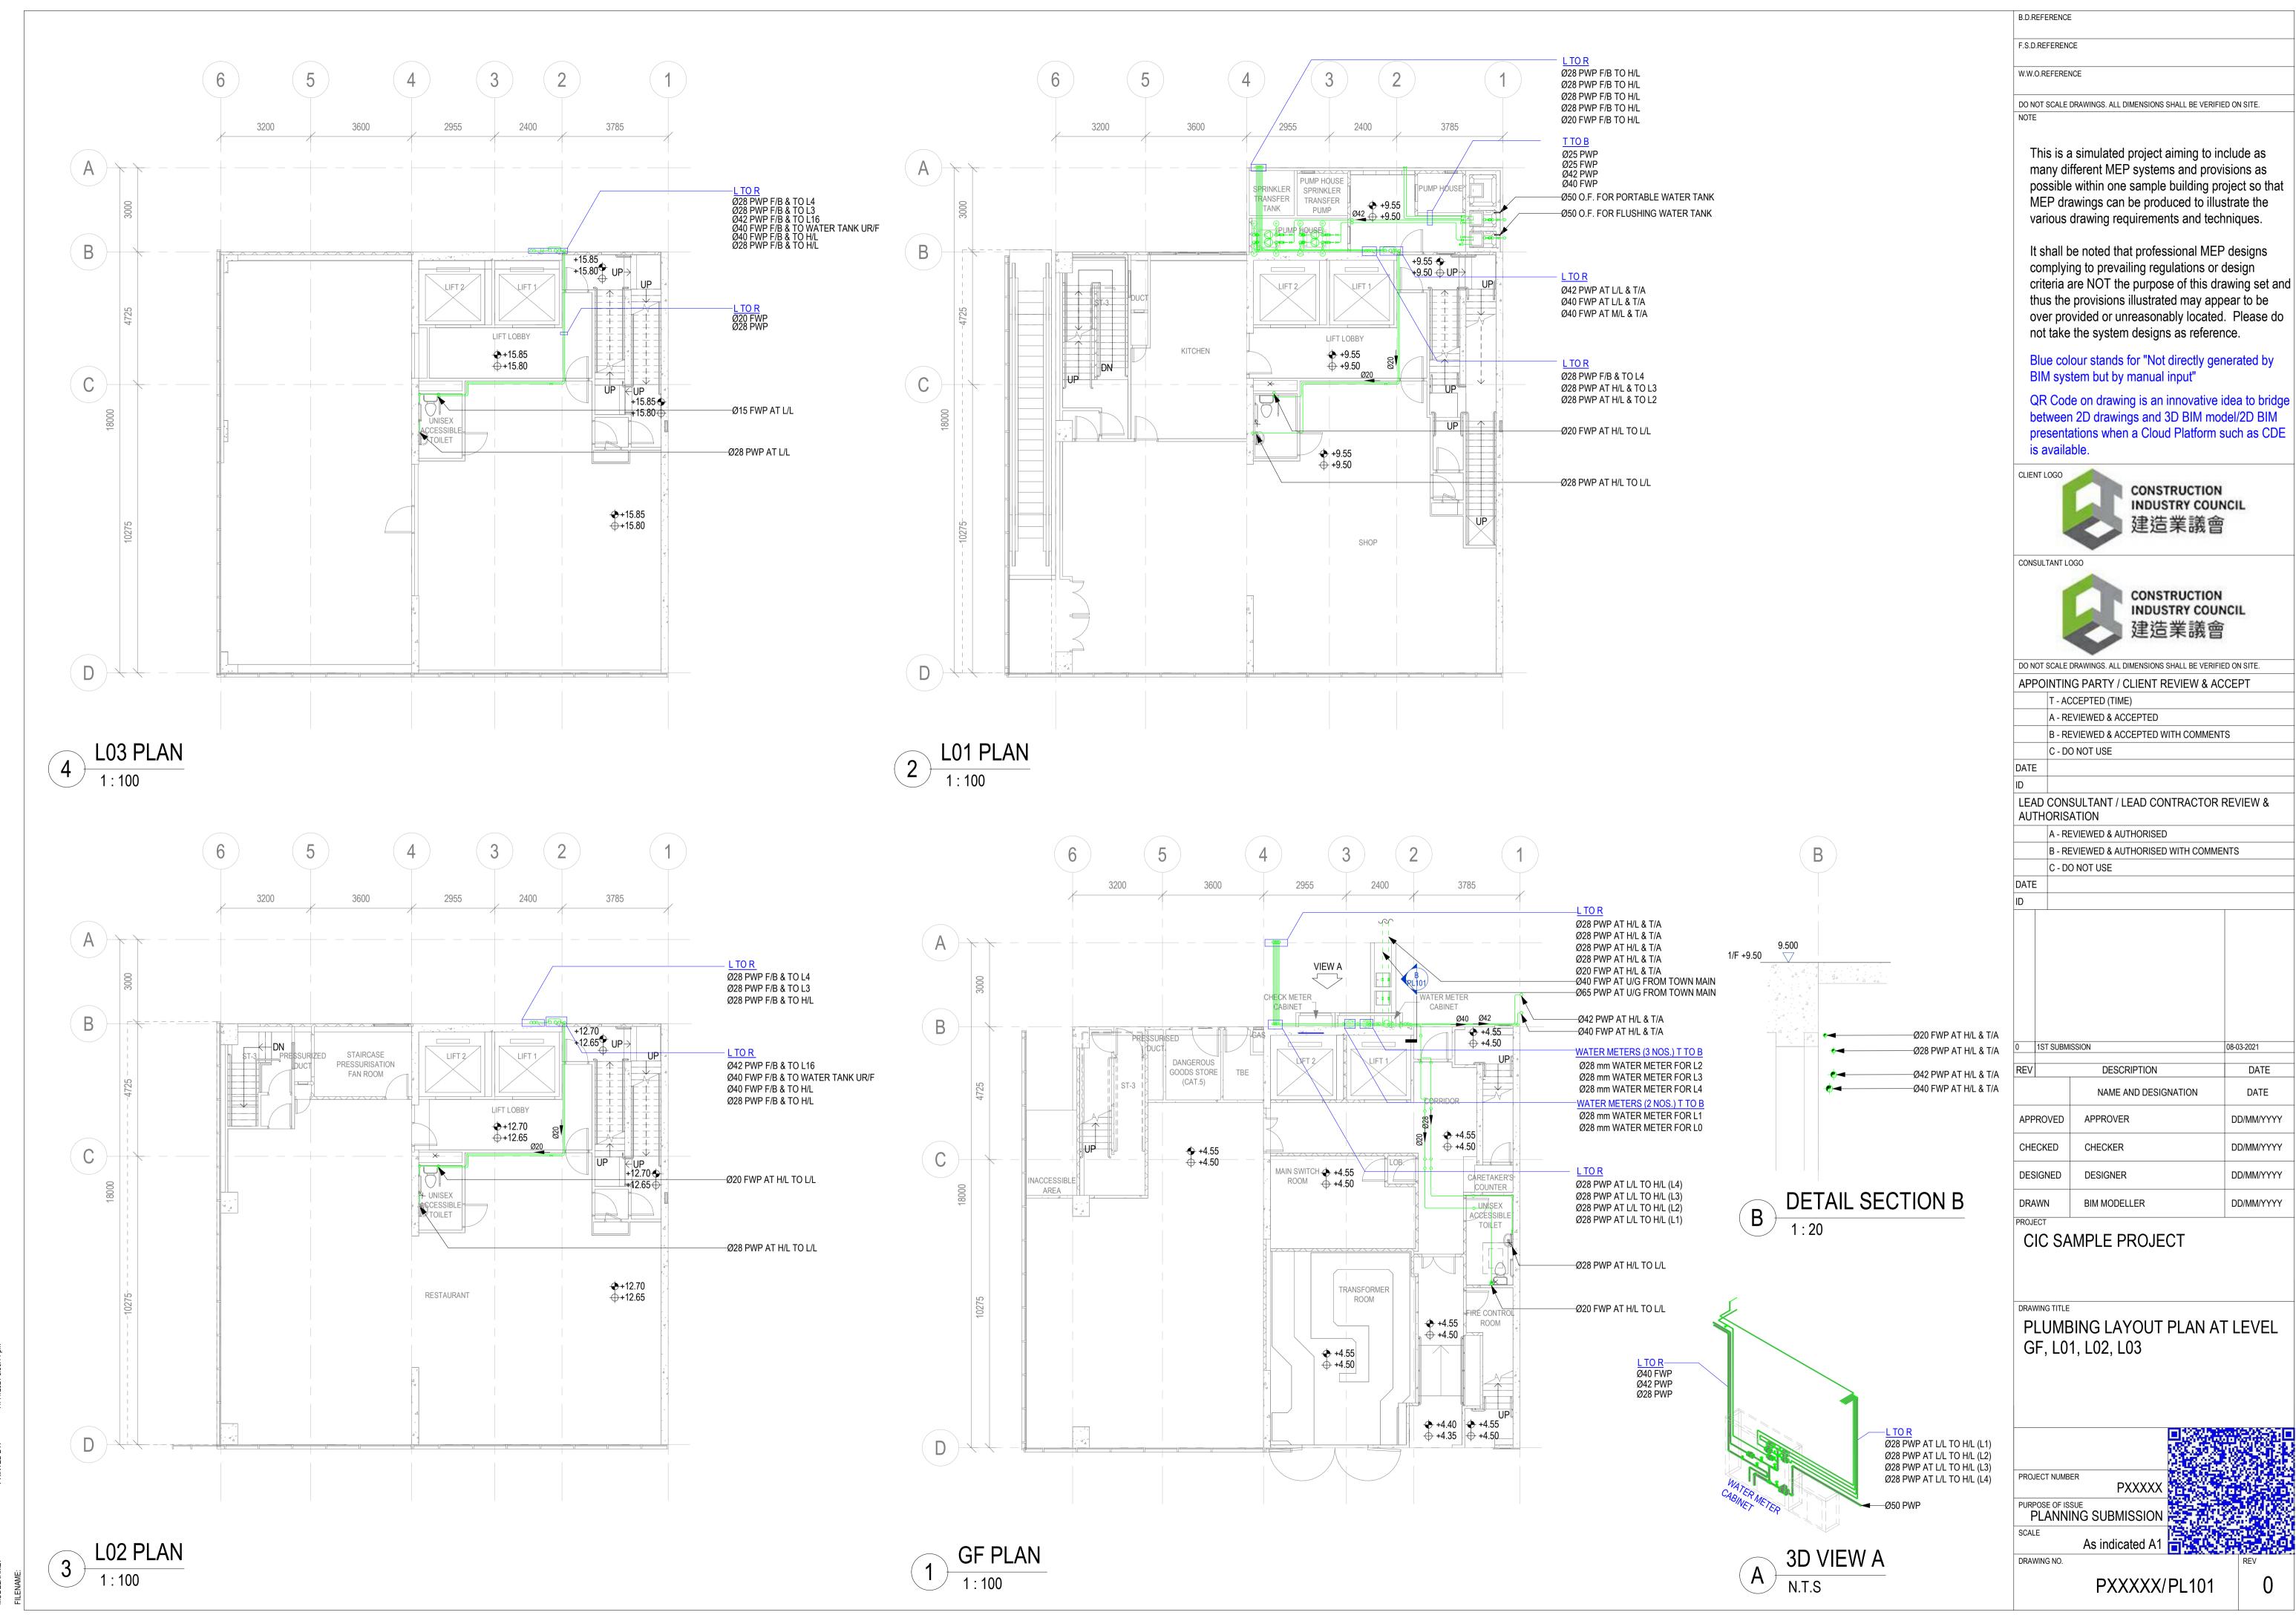


PRINTED BY: 11/11/

OT DRV: ODELNAME:

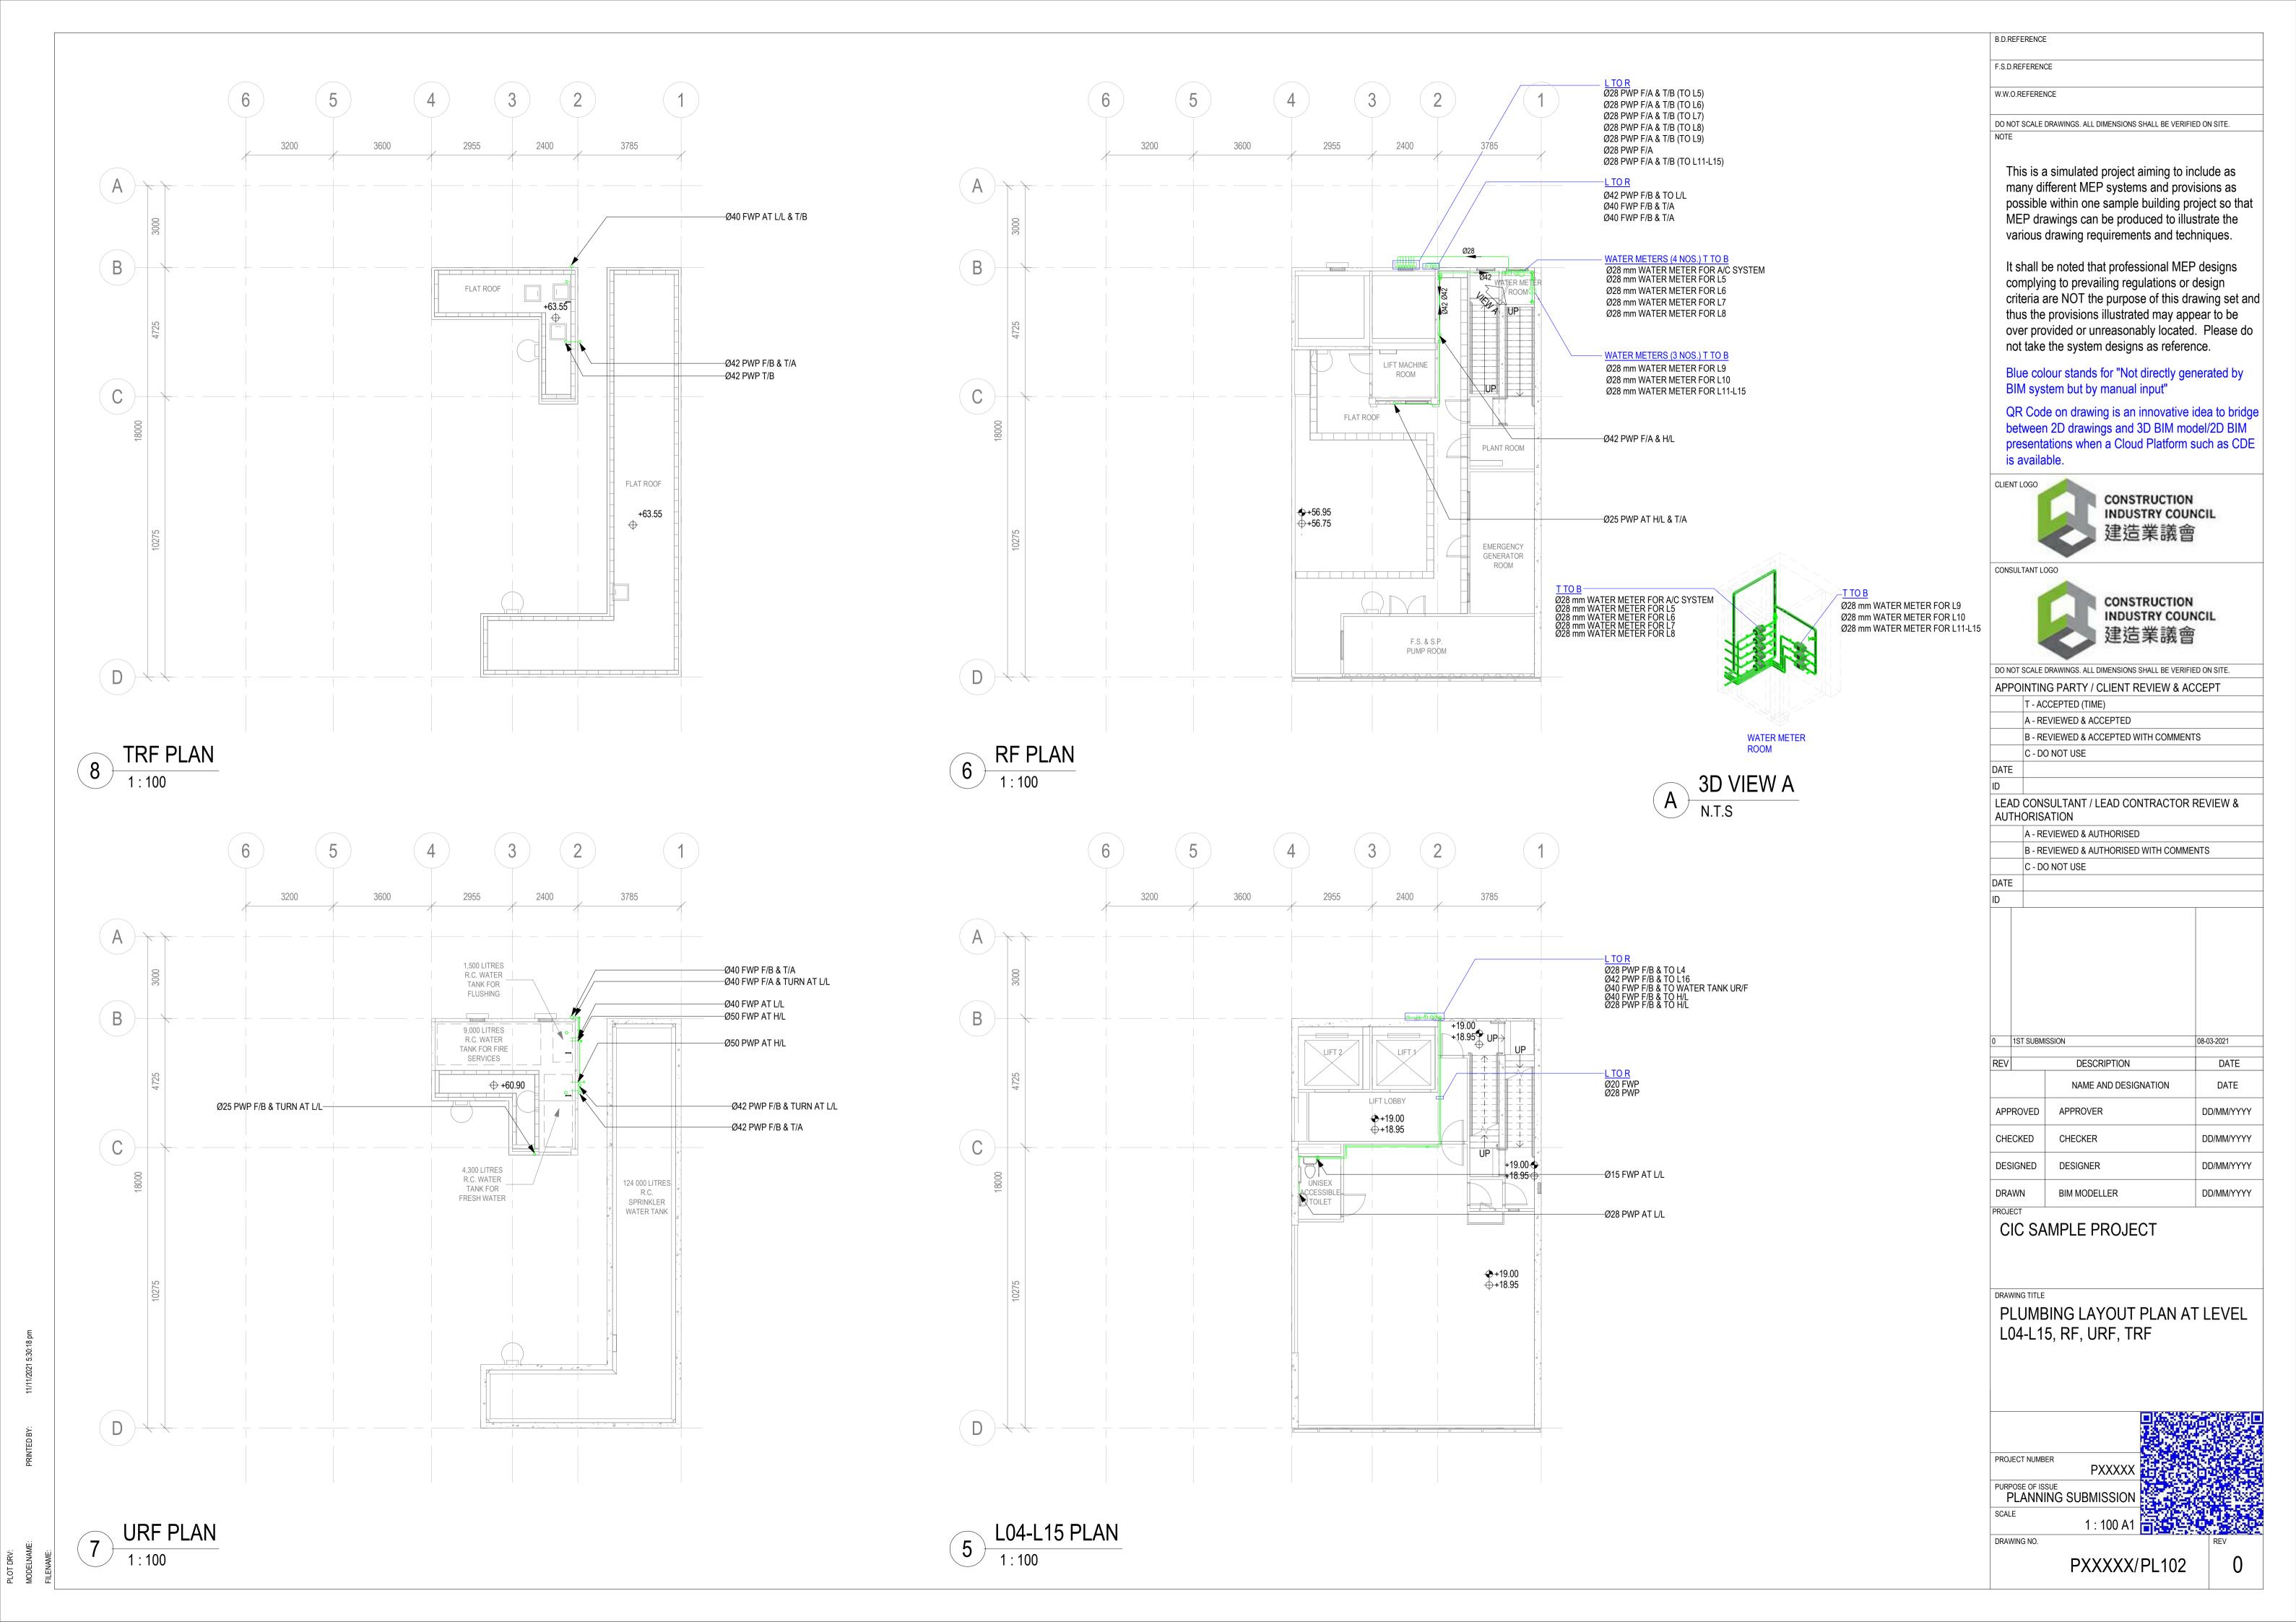



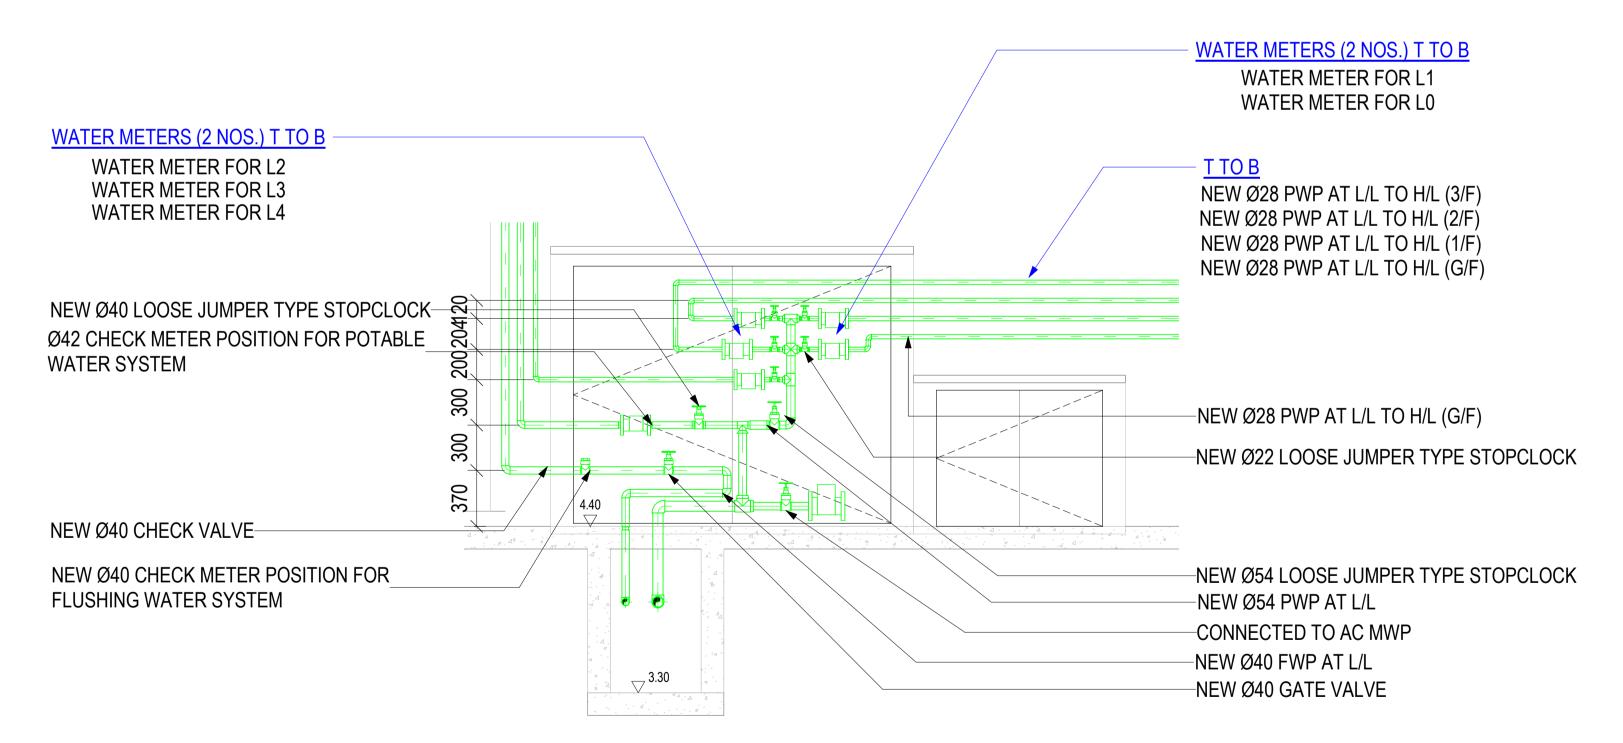

ELEVATION_DETAIL OF LOO LOCKABLE WATER METER CABINET

B.D.REFERENCE F.S.D.REFERENCE W.W.O.REFERENCE DO NOT SCALE DRAWINGS. ALL DIMENSIONS SHALL BE VERIFIED ON SITE. This is a simulated project aiming to include as many different MEP systems and provisions as possible within one sample building project so that MEP drawings can be produced to illustrate the various drawing requirements and techniques. It shall be noted that professional MEP designs complying to prevailing regulations or design criteria are NOT the purpose of this drawing set and thus the provisions illustrated may appear to be over provided or unreasonably located. Please do not take the system designs as reference. Blue colour stands for "Not directly generated by BIM system but by manual input" QR Code on drawing is an innovative idea to bridge between 2D drawings and 3D BIM model/2D BIM presentations when a Cloud Platform such as CDE is available. CLIENT LOGO CONSTRUCTION INDUSTRY COUNCIL 建造業議會 CONSULTANT LOGO CONSTRUCTION INDUSTRY COUNCIL 建造業議會 DO NOT SCALE DRAWINGS. ALL DIMENSIONS SHALL BE VERIFIED ON SITE APPOINTING PARTY / CLIENT REVIEW & ACCEPT T - ACCEPTED (TIME) A - REVIEWED & ACCEPTED B - REVIEWED & ACCEPTED WITH COMMENTS C - DO NOT USE LEAD CONSULTANT / LEAD CONTRACTOR REVIEW & AUTHORISATION A - REVIEWED & AUTHORISED B - REVIEWED & AUTHORISED WITH COMMENTS C - DO NOT USE DATE 1ST SUBMISSION 08-03-2021 DESCRIPTION DATE NAME AND DESIGNATION DATE APPROVED APPROVER DD/MM/YYYY CHECKED CHECKER DD/MM/YYYY


DESIGNED DESIGNER DD/MM/YYYY DRAWN **BIM MODELLER** DD/MM/YYYY


ARRANGMENT OF WATER METER CABINET ATLEVEL GF & RF


CIC SAMPLE PROJECT

PROJECT NUMBER PXXXXX PURPOSE OF ISSUE PLANNING SUBMISSION DRAWING NO.

PXXXXX/PL400

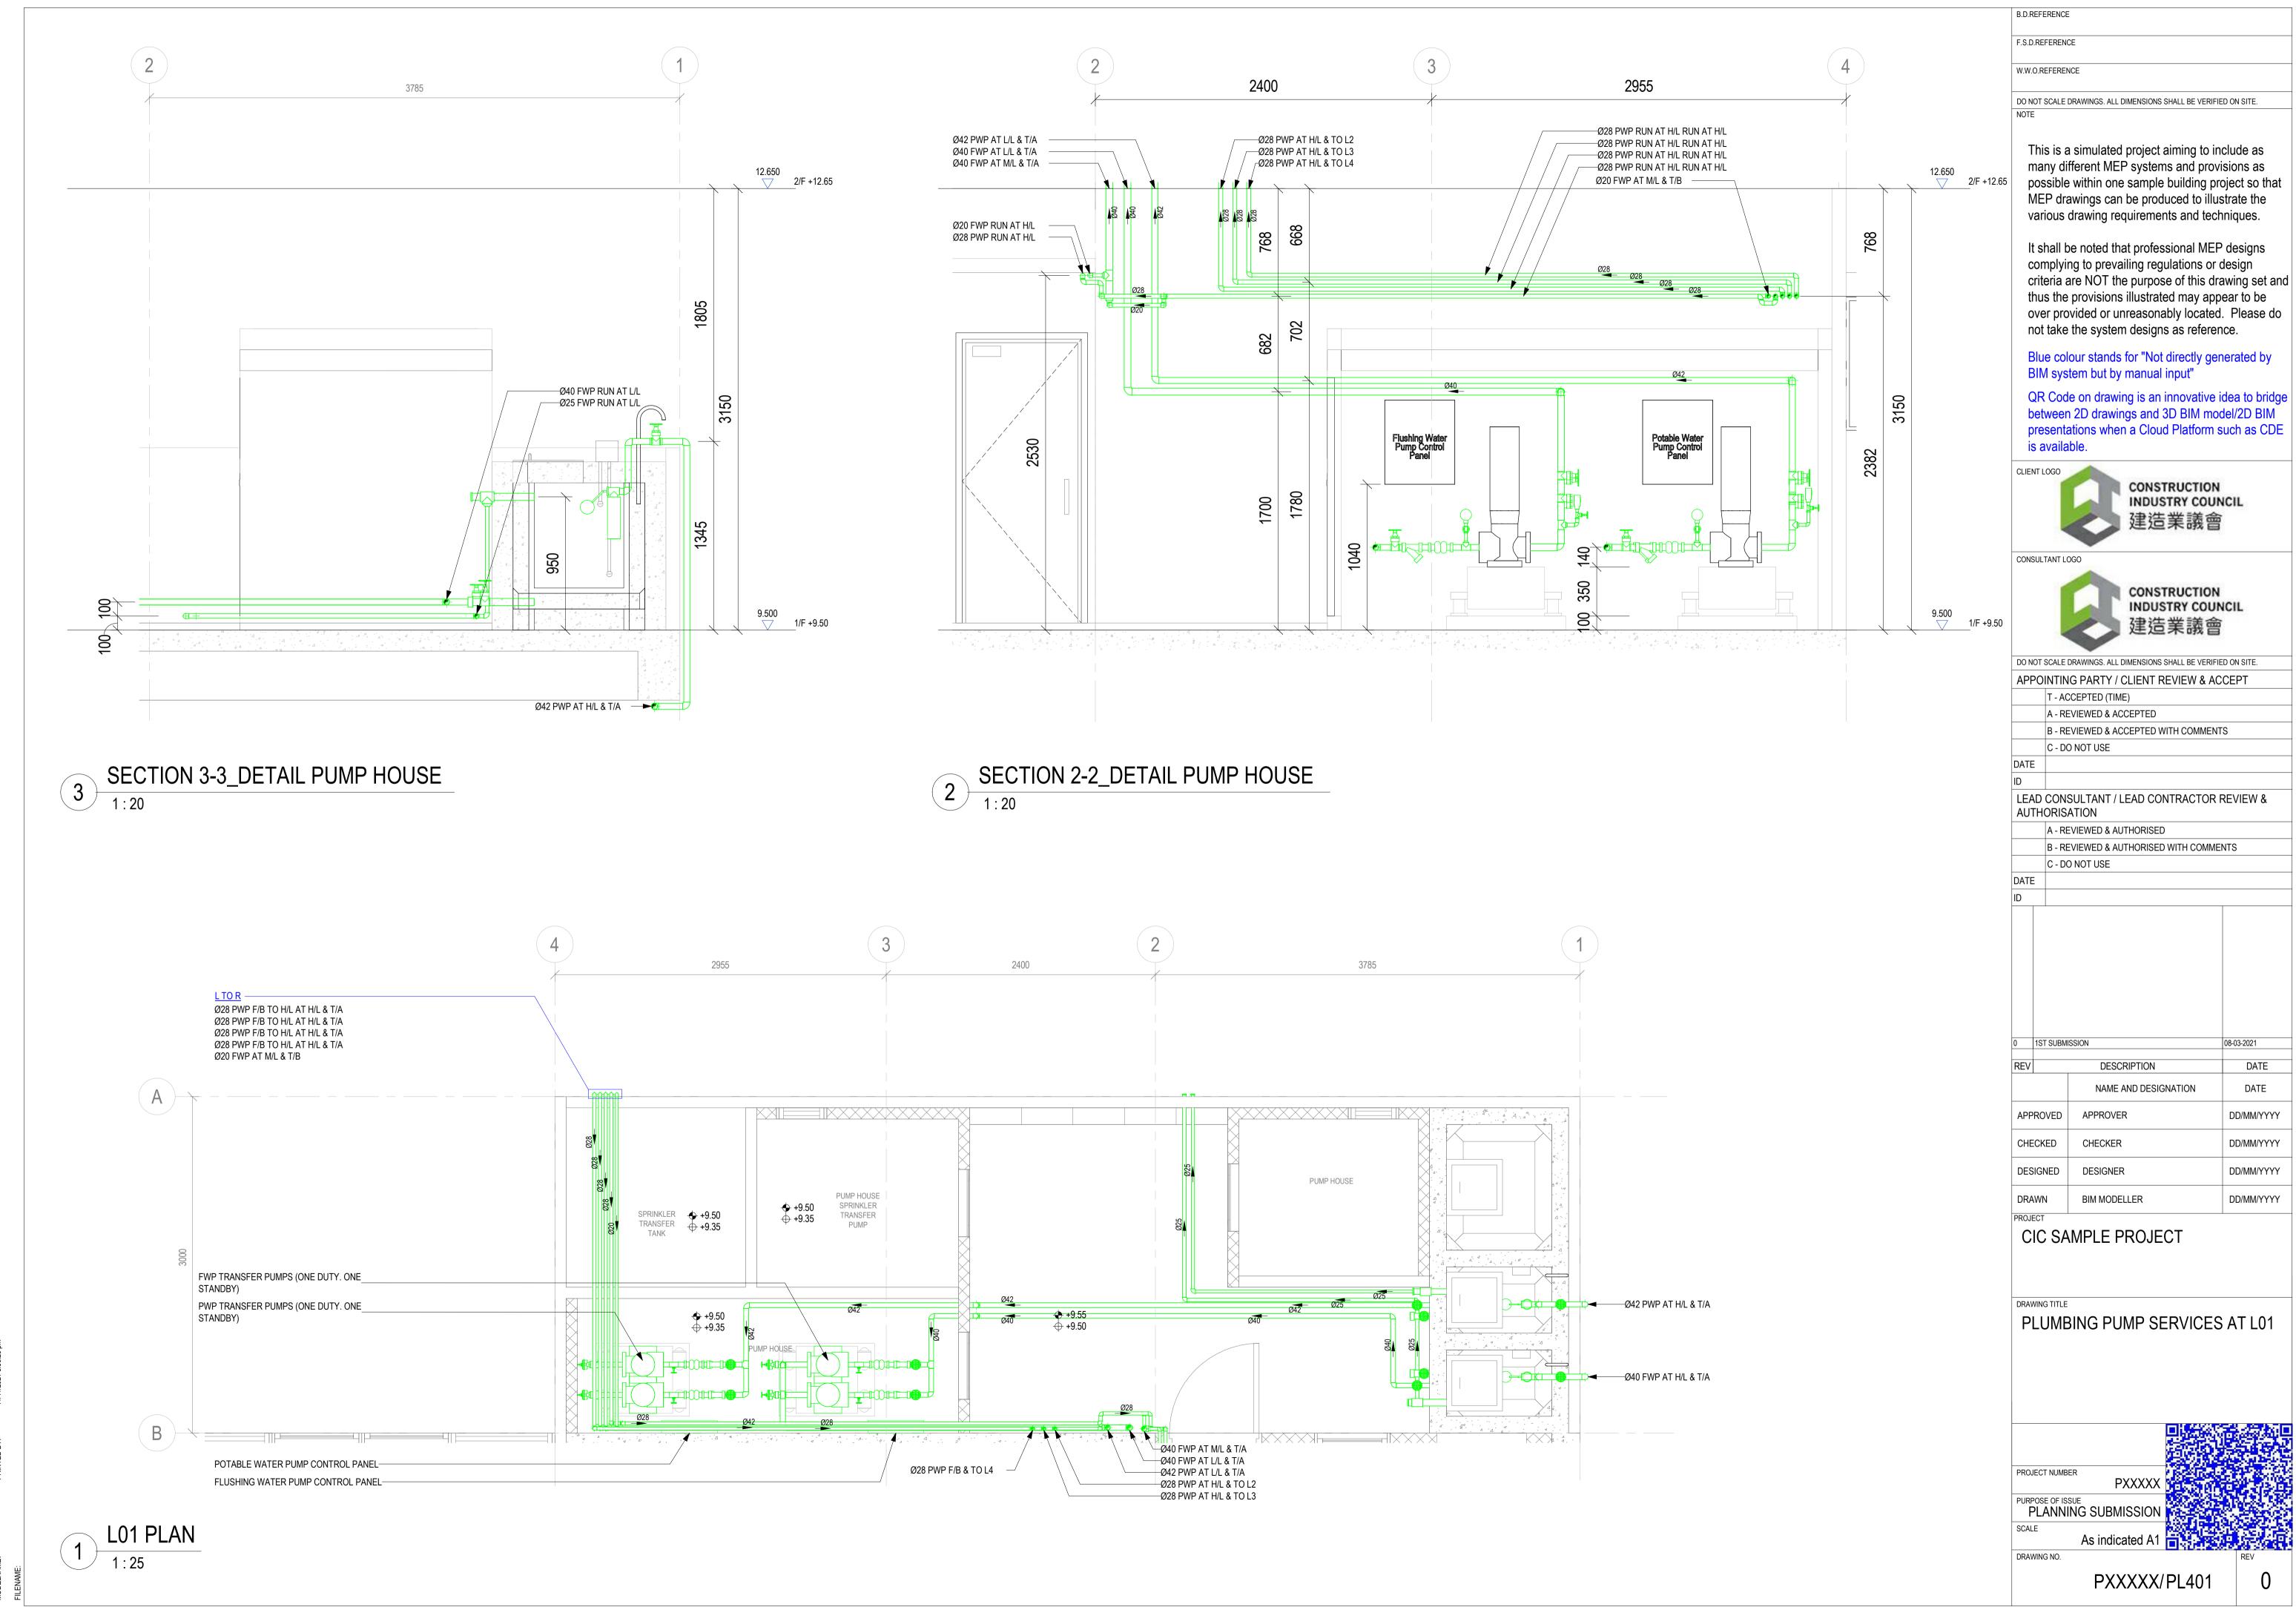

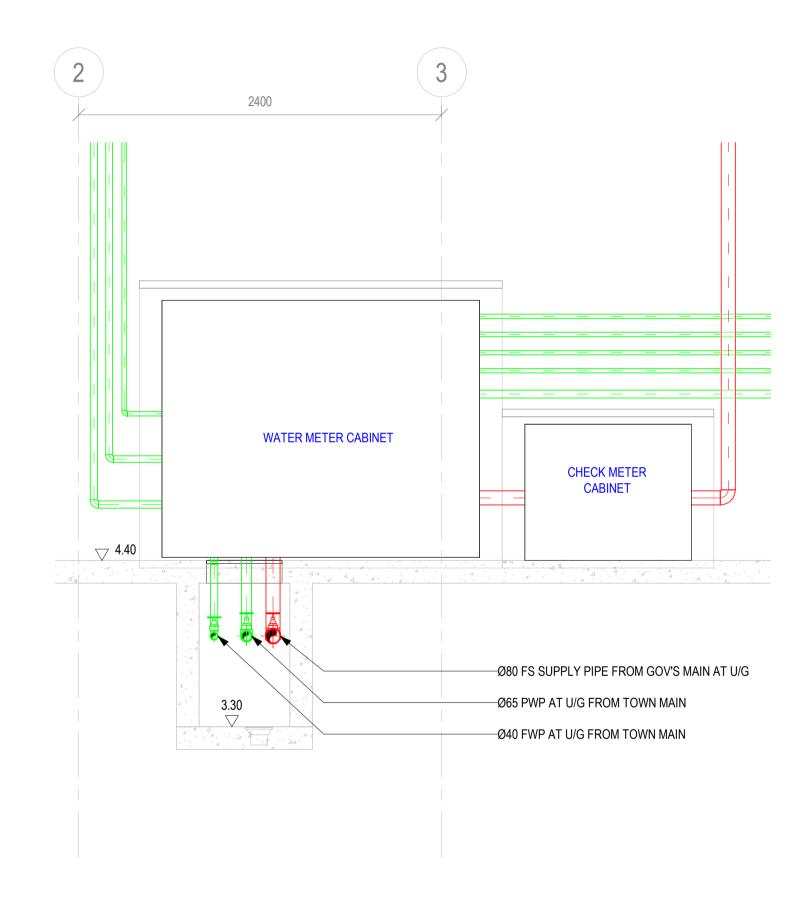

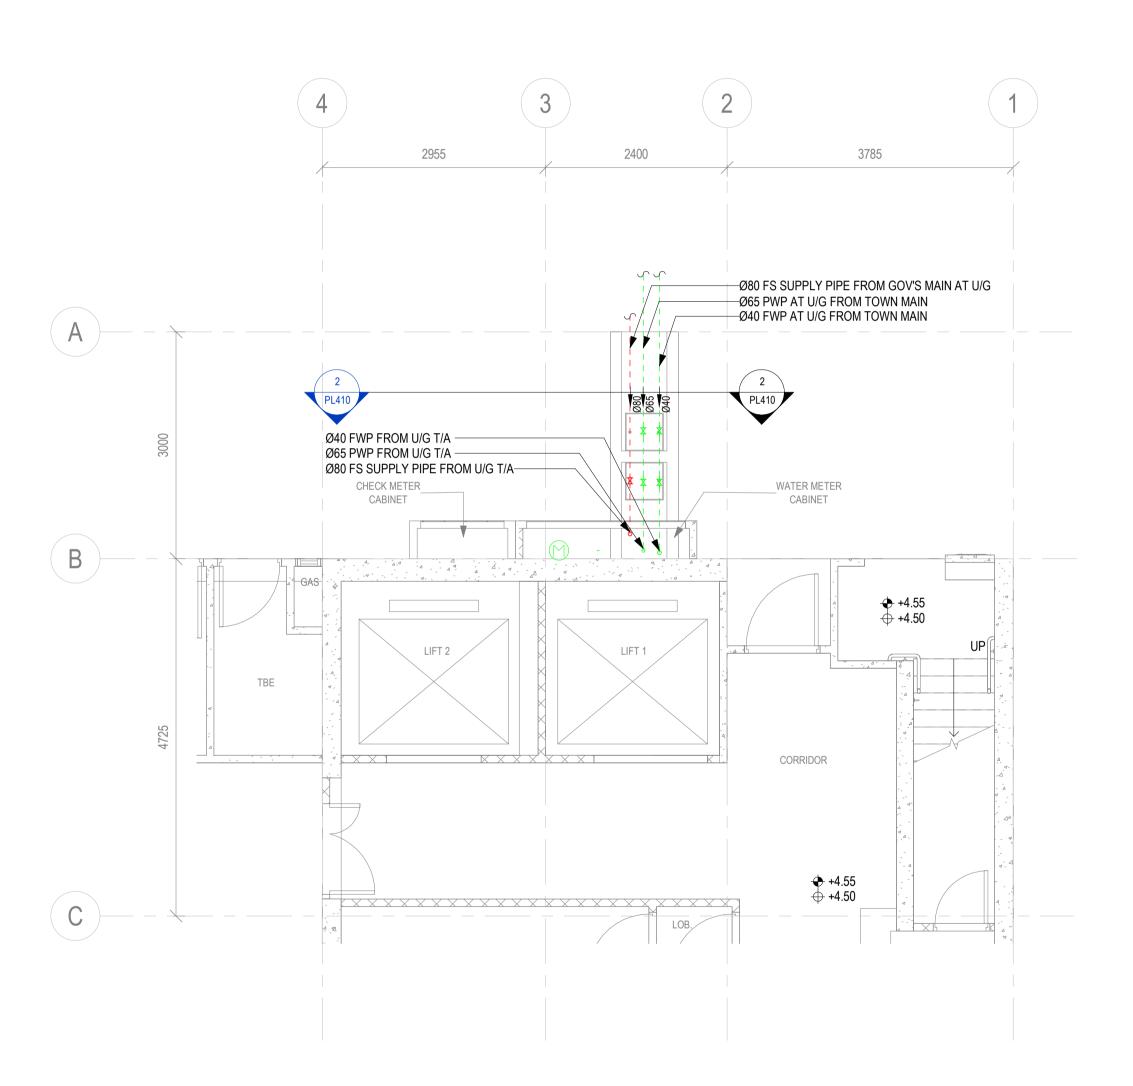

SECTION 2-2_WATER METER CABINET

1:25

B.D.REFERENCE F.S.D.REFERENCE W.W.O.REFERENCE DO NOT SCALE DRAWINGS. ALL DIMENSIONS SHALL BE VERIFIED ON SITE. This is a simulated project aiming to include as many different MEP systems and provisions as possible within one sample building project so that MEP drawings can be produced to illustrate the various drawing requirements and techniques. It shall be noted that professional MEP designs complying to prevailing regulations or design criteria are NOT the purpose of this drawing set and thus the provisions illustrated may appear to be over provided or unreasonably located. Please do not take the system designs as reference. Blue colour stands for "Not directly generated by BIM system but by manual input" QR Code on drawing is an innovative idea to bridge between 2D drawings and 3D BIM model/2D BIM presentations when a Cloud Platform such as CDE is available. CLIENT LOGO CONSTRUCTION INDUSTRY COUNCIL 建造業議會 CONSULTANT LOGO CONSTRUCTION INDUSTRY COUNCIL 建造業議會 DO NOT SCALE DRAWINGS. ALL DIMENSIONS SHALL BE VERIFIED ON SITE. APPOINTING PARTY / CLIENT REVIEW & ACCEPT T - ACCEPTED (TIME) A - REVIEWED & ACCEPTED B - REVIEWED & ACCEPTED WITH COMMENTS C - DO NOT USE LEAD CONSULTANT / LEAD CONTRACTOR REVIEW & AUTHORISATION A - REVIEWED & AUTHORISED B - REVIEWED & AUTHORISED WITH COMMENTS C - DO NOT USE DATE ID 1ST SUBMISSION DESCRIPTION NAME AND DESIGNATION APPROVED APPROVER CHECKED CHECKER DESIGNED DESIGNER **BIM MODELLER** CIC SAMPLE PROJECT

UNDERGROUND WATER SUPPLY LAYOUT AT LEVEL GF

PURPOSE OF ISSUE PLANNING SUBMISSION DRAWING NO.

PXXXXX/PL410

08-03-2021

DATE


DATE

DD/MM/YYYY

DD/MM/YYYY

DD/MM/YYYY

DD/MM/YYYY

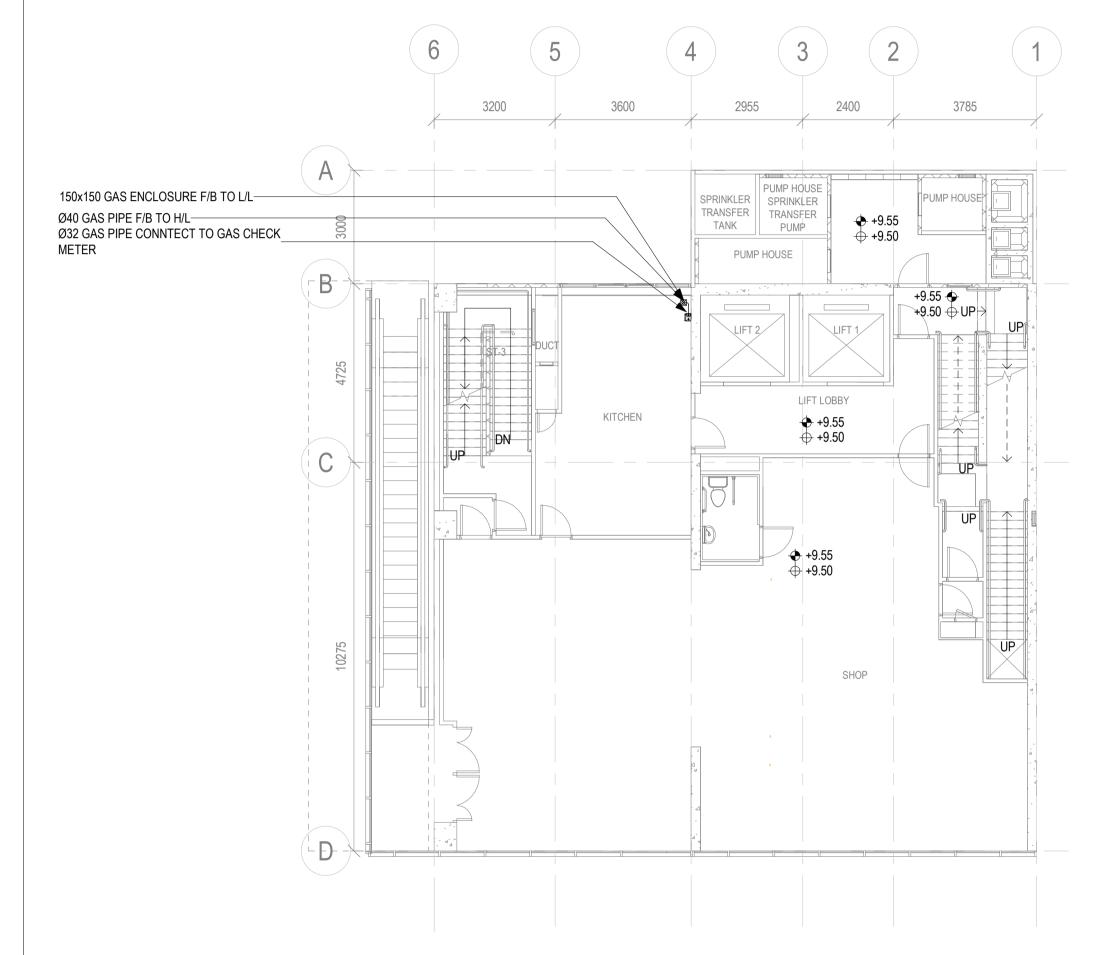

2955 3785 Ø100 GAS PIPE AT U/G FROM GAS MAIN-150x150 GAS ENCLOSURE AT U/G-Ø100 GAS PIPE FROM U/G T/A 150x150 GAS ENCLOSURE FROM U/G T/A----WATER METER В +4.55 +4.50 DANGEROUS GOODS STORE TBE (CAT.5) +4.55 +4.50 +4.55 +4.50 MAIN SWITCH +4.55 ROOM +4.50 CARETAKER'S COUNTER AREA UMSEX ACCESSIBLE TOILET TRANSFORMER ROOM +4.55 ROOM +4.50 +4.55 +4.50

2 L01 PLAN 1: 100

1 GF PLAN 1:100

B.D.REFERENCE F.S.D.REFERENCE W.W.O.REFERENCE DO NOT SCALE DRAWINGS. ALL DIMENSIONS SHALL BE VERIFIED ON SITE. This is a simulated project aiming to include as many different MEP systems and provisions as possible within one sample building project so that MEP drawings can be produced to illustrate the various drawing requirements and techniques. It shall be noted that professional MEP designs complying to prevailing regulations or design criteria are NOT the purpose of this drawing set and thus the provisions illustrated may appear to be over provided or unreasonably located. Please do not take the system designs as reference. Blue colour stands for "Not directly generated by BIM system but by manual input" QR Code on drawing is an innovative idea to bridge between 2D drawings and 3D BIM model/2D BIM presentations when a Cloud Platform such as CDE is available. CLIENT LOGO CONSTRUCTION INDUSTRY COUNCIL 建造業議會 CONSULTANT LOGO CONSTRUCTION INDUSTRY COUNCIL 建造業議會 DO NOT SCALE DRAWINGS. ALL DIMENSIONS SHALL BE VERIFIED ON SITE. APPOINTING PARTY / CLIENT REVIEW & ACCEPT T - ACCEPTED (TIME) A - REVIEWED & ACCEPTED B - REVIEWED & ACCEPTED WITH COMMENTS C - DO NOT USE LEAD CONSULTANT / LEAD CONTRACTOR REVIEW & AUTHORISATION A - REVIEWED & AUTHORISED B - REVIEWED & AUTHORISED WITH COMMENTS C - DO NOT USE DATE DESCRIPTION DATE NAME AND DESIGNATION APPROVED DD/MM/YYYY DD/MM/YYYY DESIGNED DESIGNER DD/MM/YYYY **BIM MODELLER** DD/MM/YYYY CIC SAMPLE PROJECT TOWN GAS LAYOUT PXXXXX PURPOSE OF ISSUE PLANNING SUBMISSION

11/11/2021 5:30:37 pm

PRINTED BY:

PLOT DRV: MODELNAME:

PXXXXX/TG201

DRAWING NO.